


SCALE: 1:200 A2


18/03/2022


RL+38.90 RL+37.65 1FL+35.90 ____ . ____ . ___ . _ -1.8M HIGH ACOUSTIC FENCE GFL+32.60 AREA U1 INDOOR PLAY AREA 02 OUTDOOR PLAY NGL+30.75 EAST ELEVATION 1:100 (<u>E</u>) PROPOSED CHILDCARE CENTRE 21 BELLEVUE STREET N. PARRAMATTA NSW NORTH & EAST ELEVATIONS SCALE: 1:100 A1


1FL+35.90

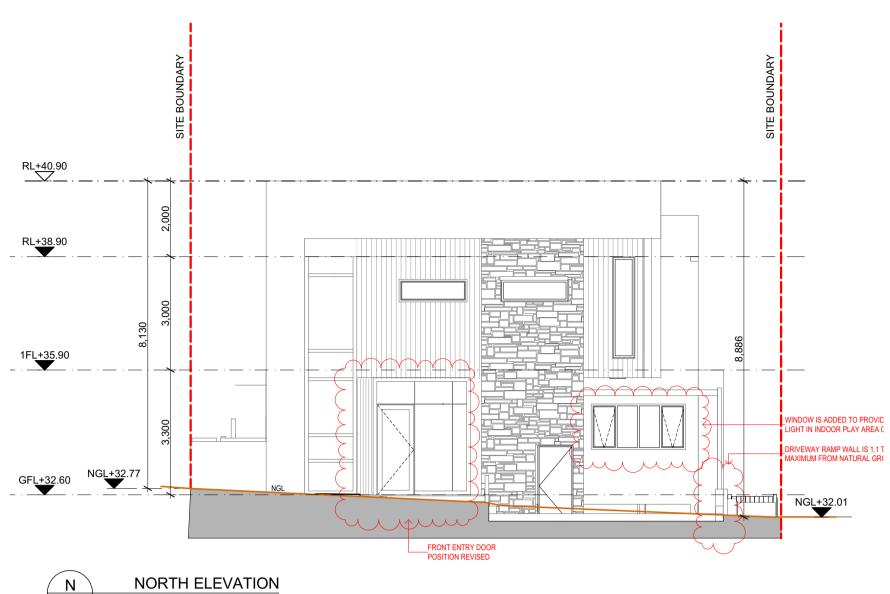




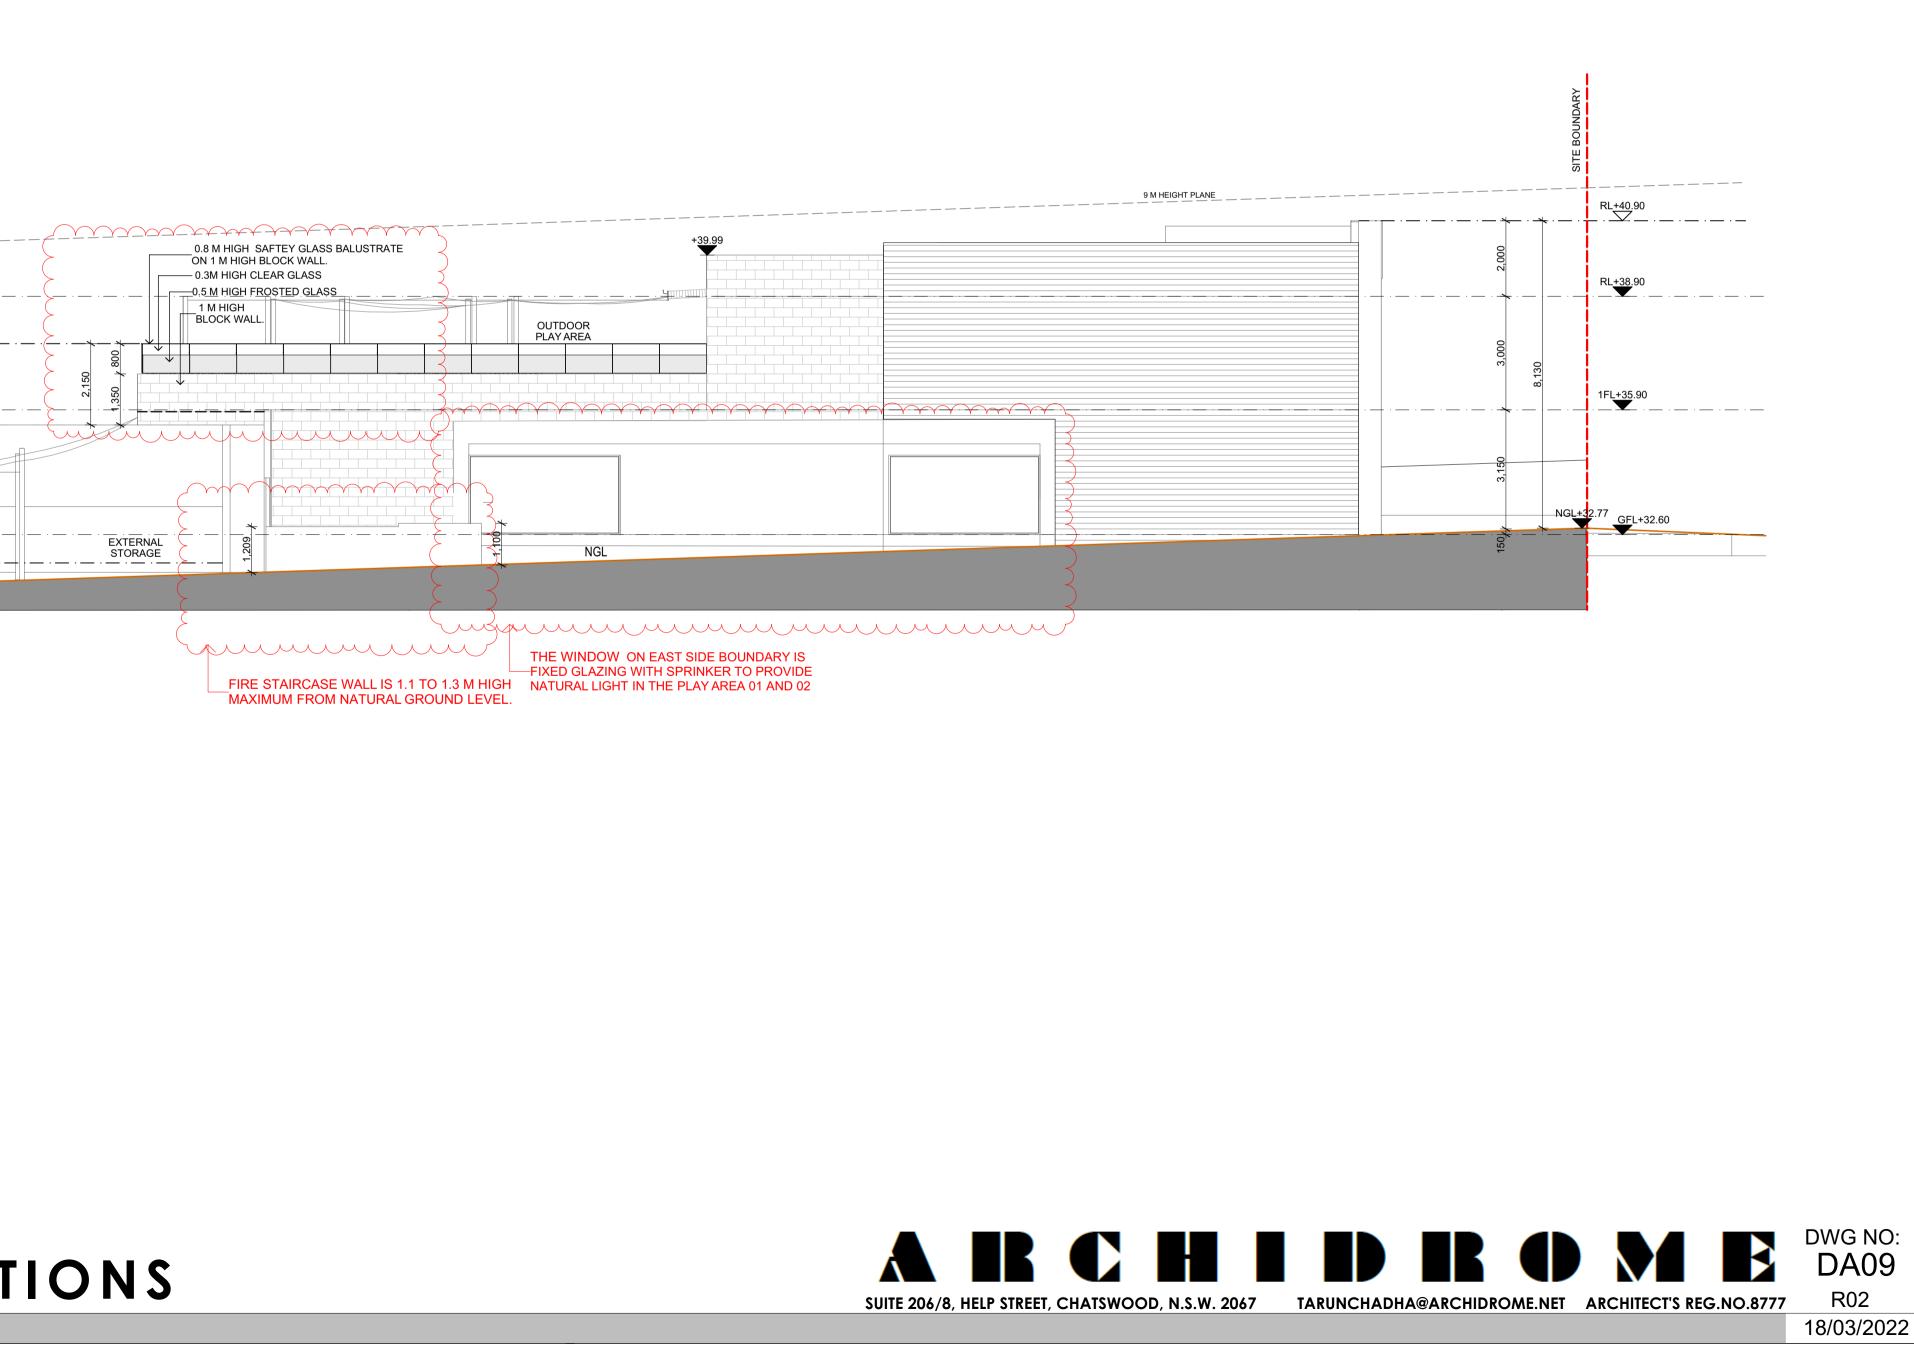

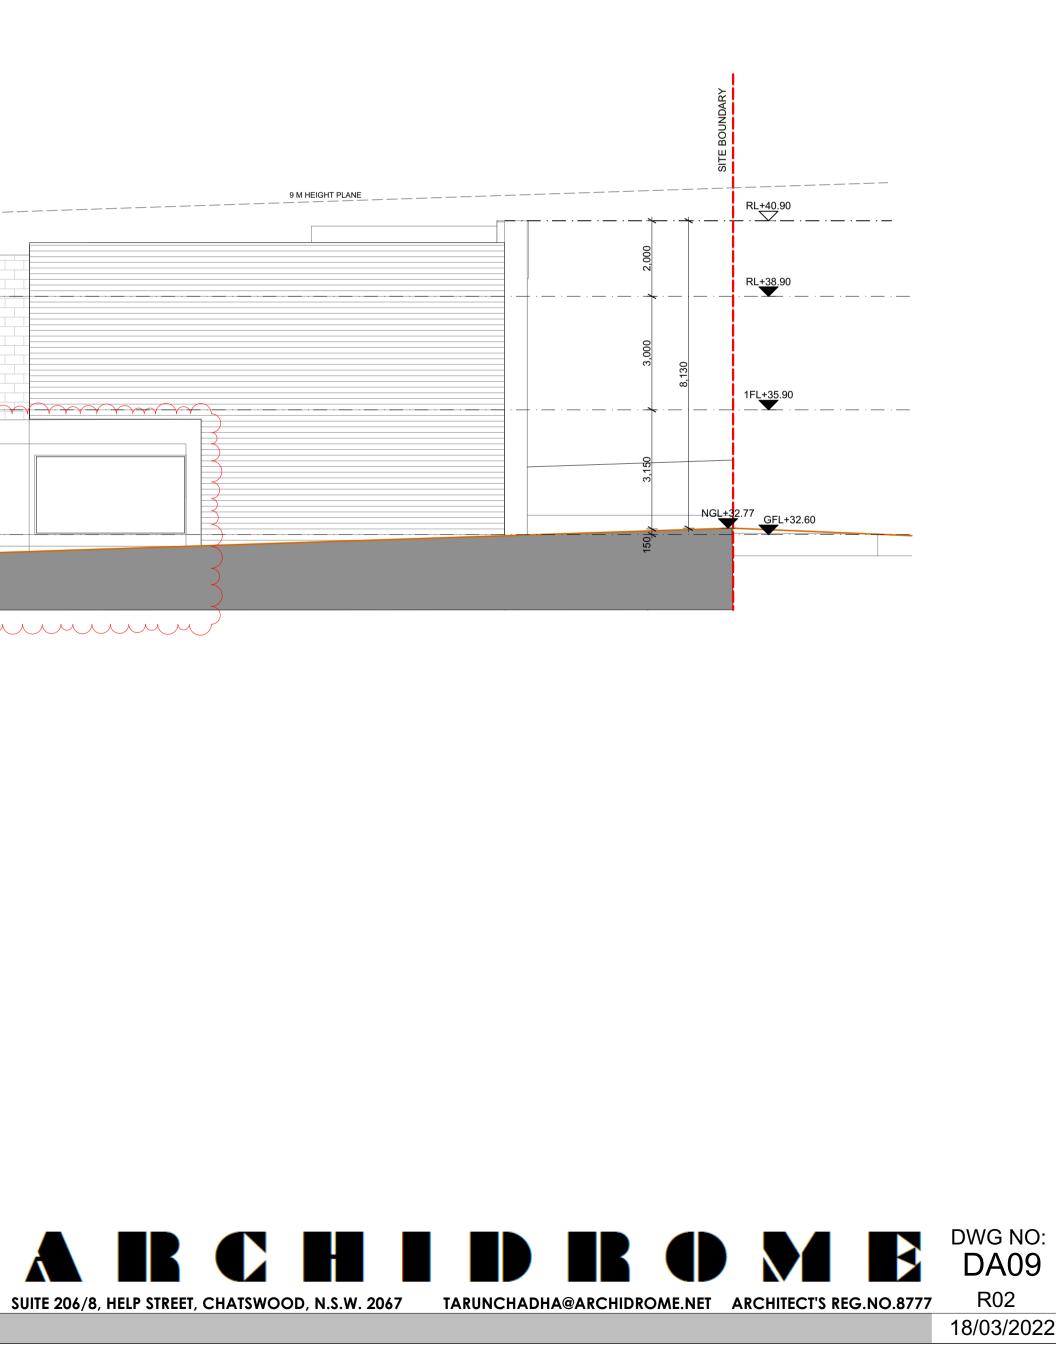

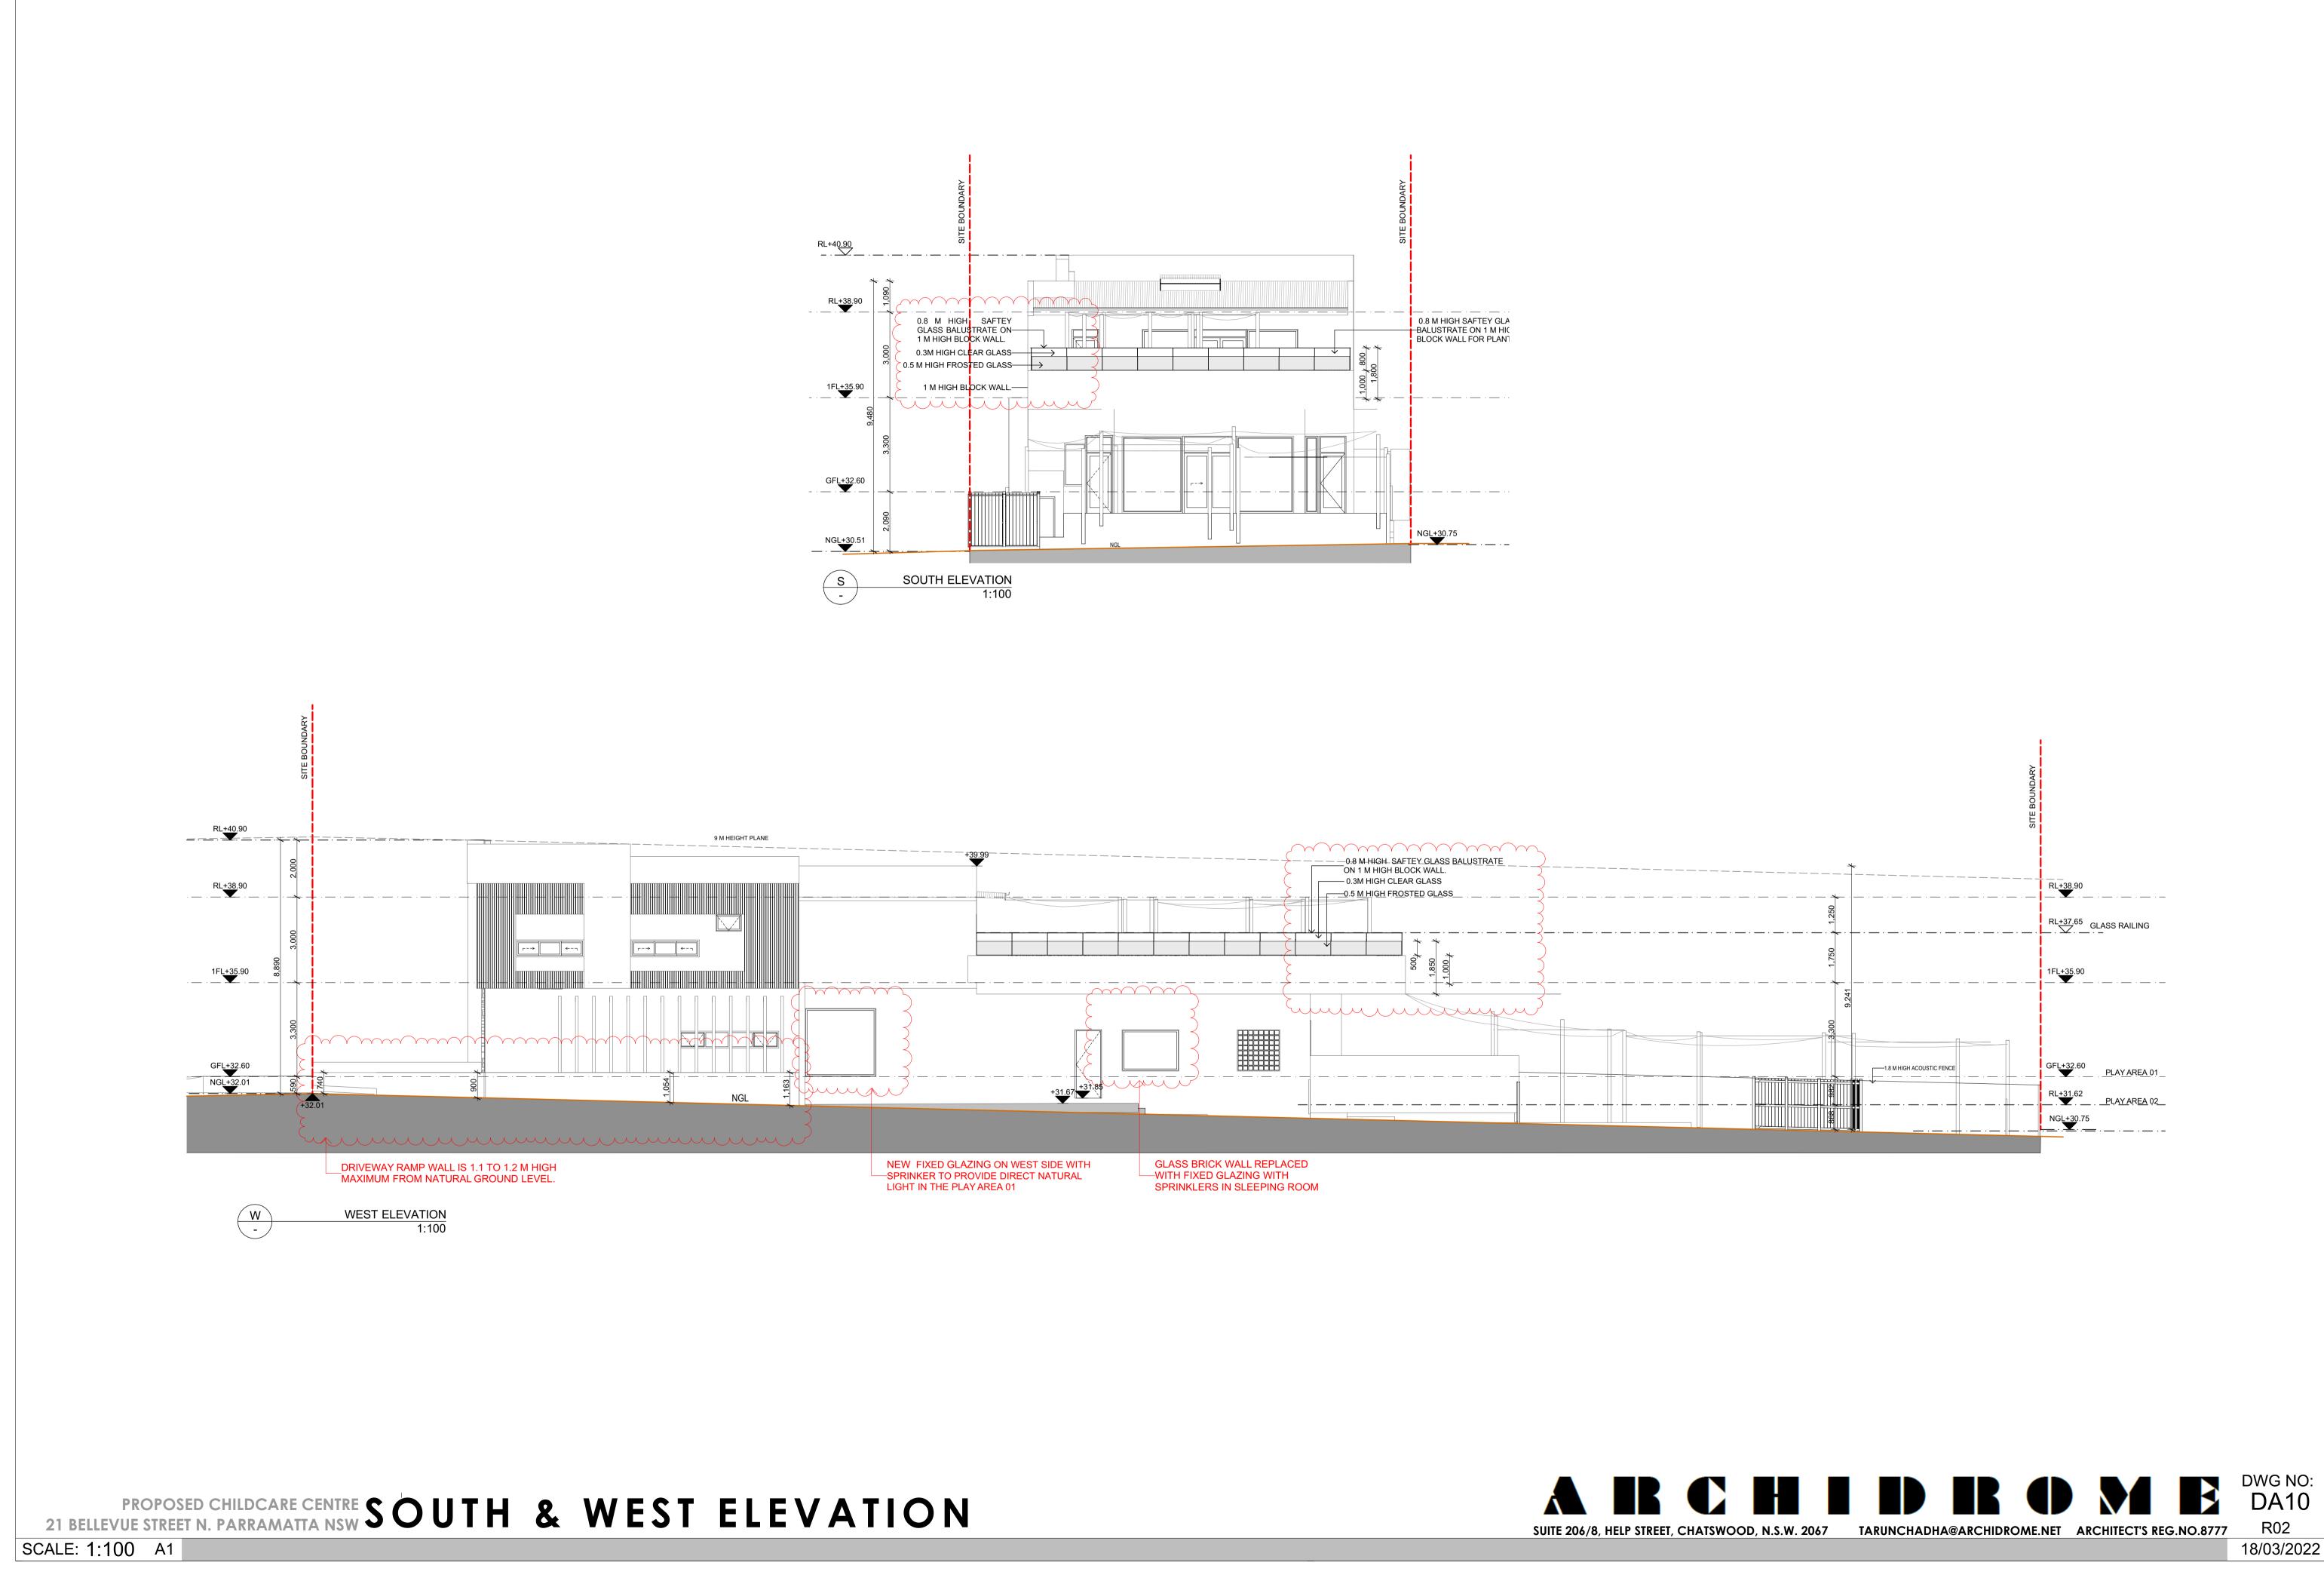

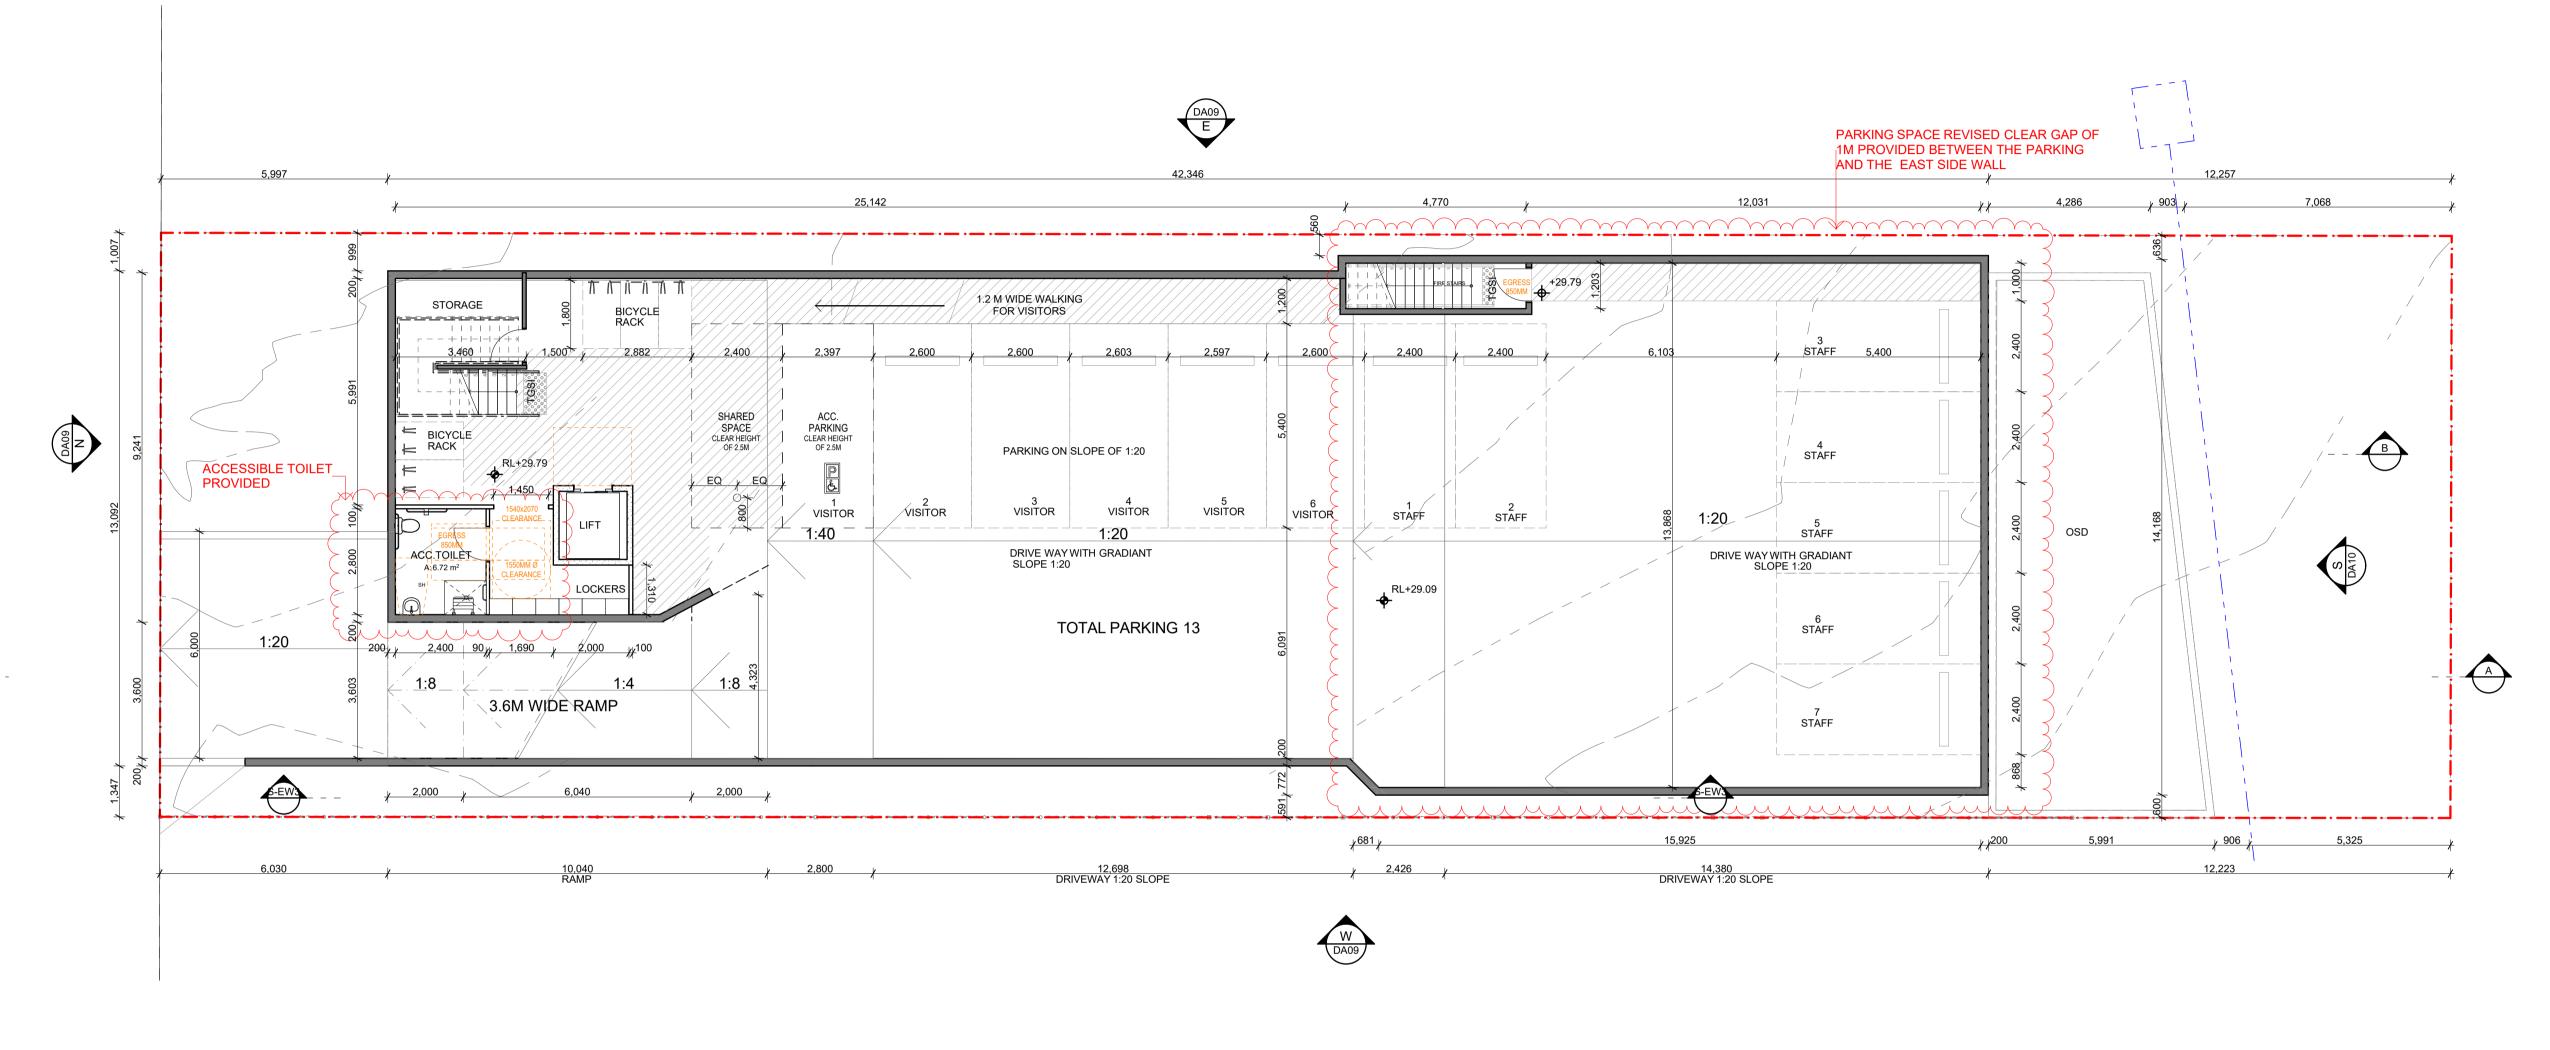



PROPOSED CHILDCARE CENTRE BASEMENT PLAN 21 BELLEVUE STREET N. PARRAMATTA NSW


SCALE: 1:100 A1


LEGEND	
W	WASTE BIN
R	RECYCLE BIN
	SEWER LINE
<u> </u>	SITE BOUNDARY
	WALKWAY MARKED W





PARKING WITHIN SITE BOUNDARY	13
VISITOR STAFF ACCESSIBLE PARKING (VISITOR)	05 07 01

WITH 30% LUMINANCE PAINT

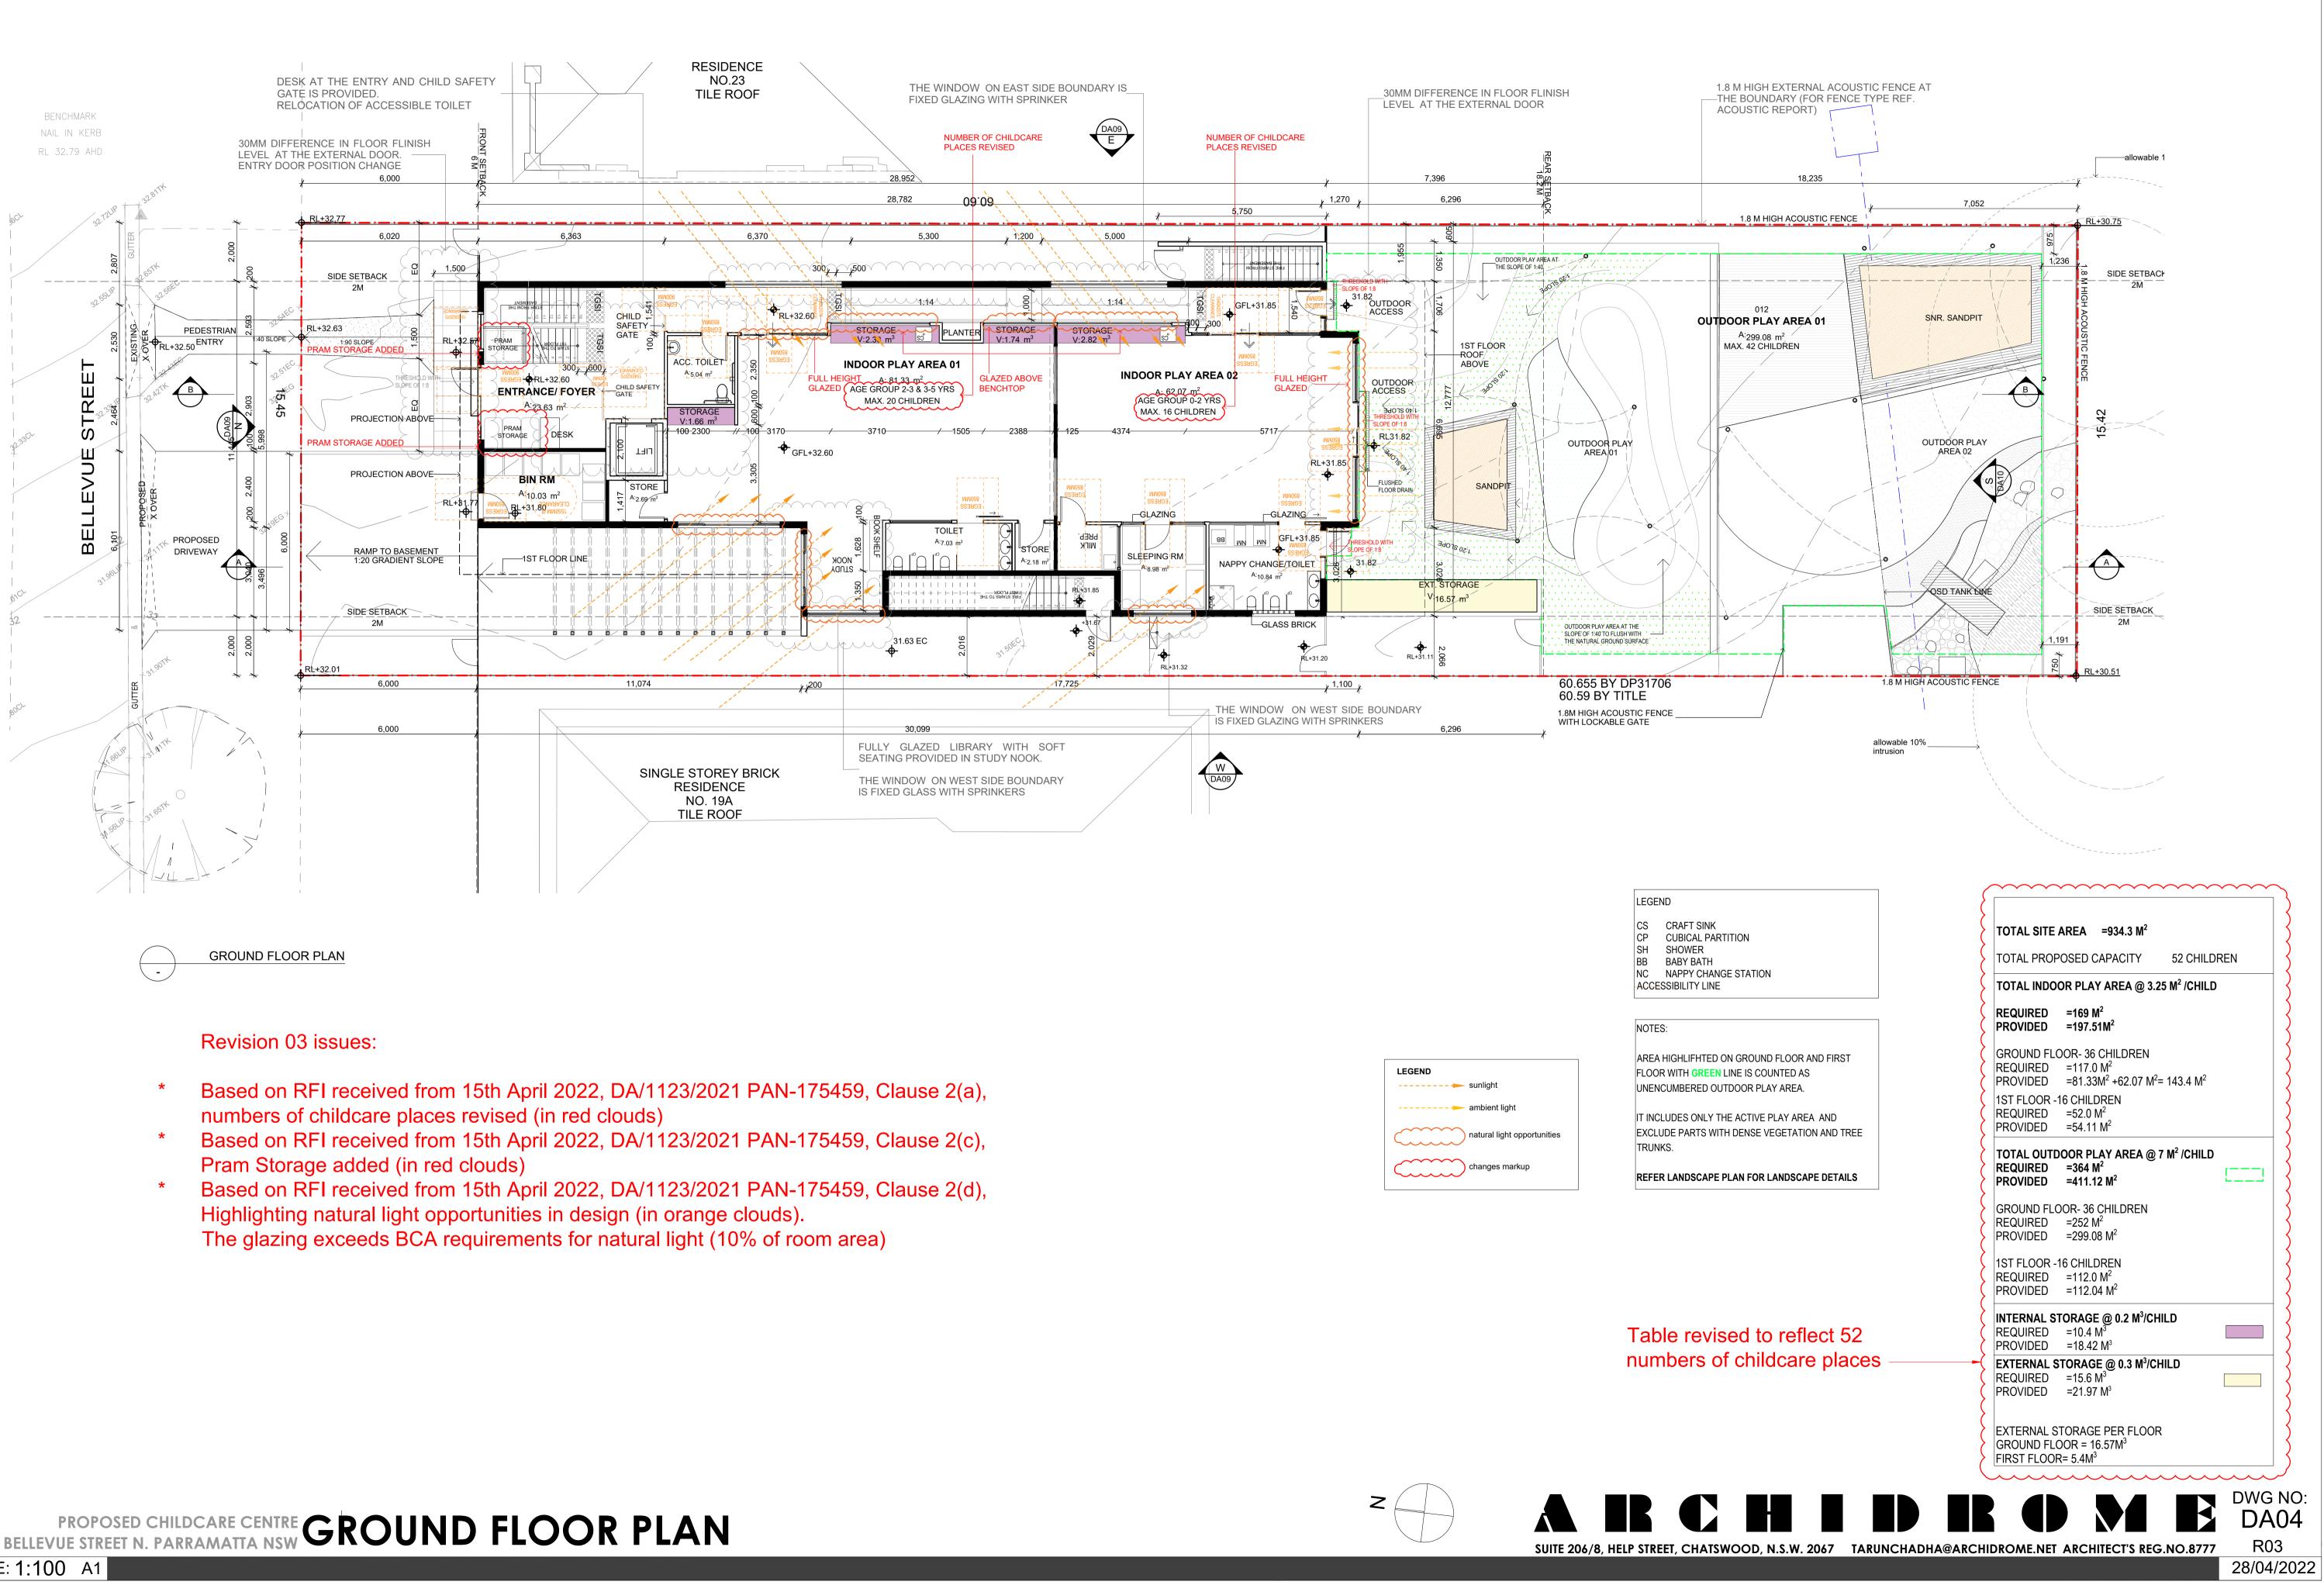

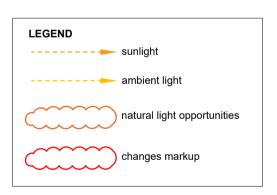

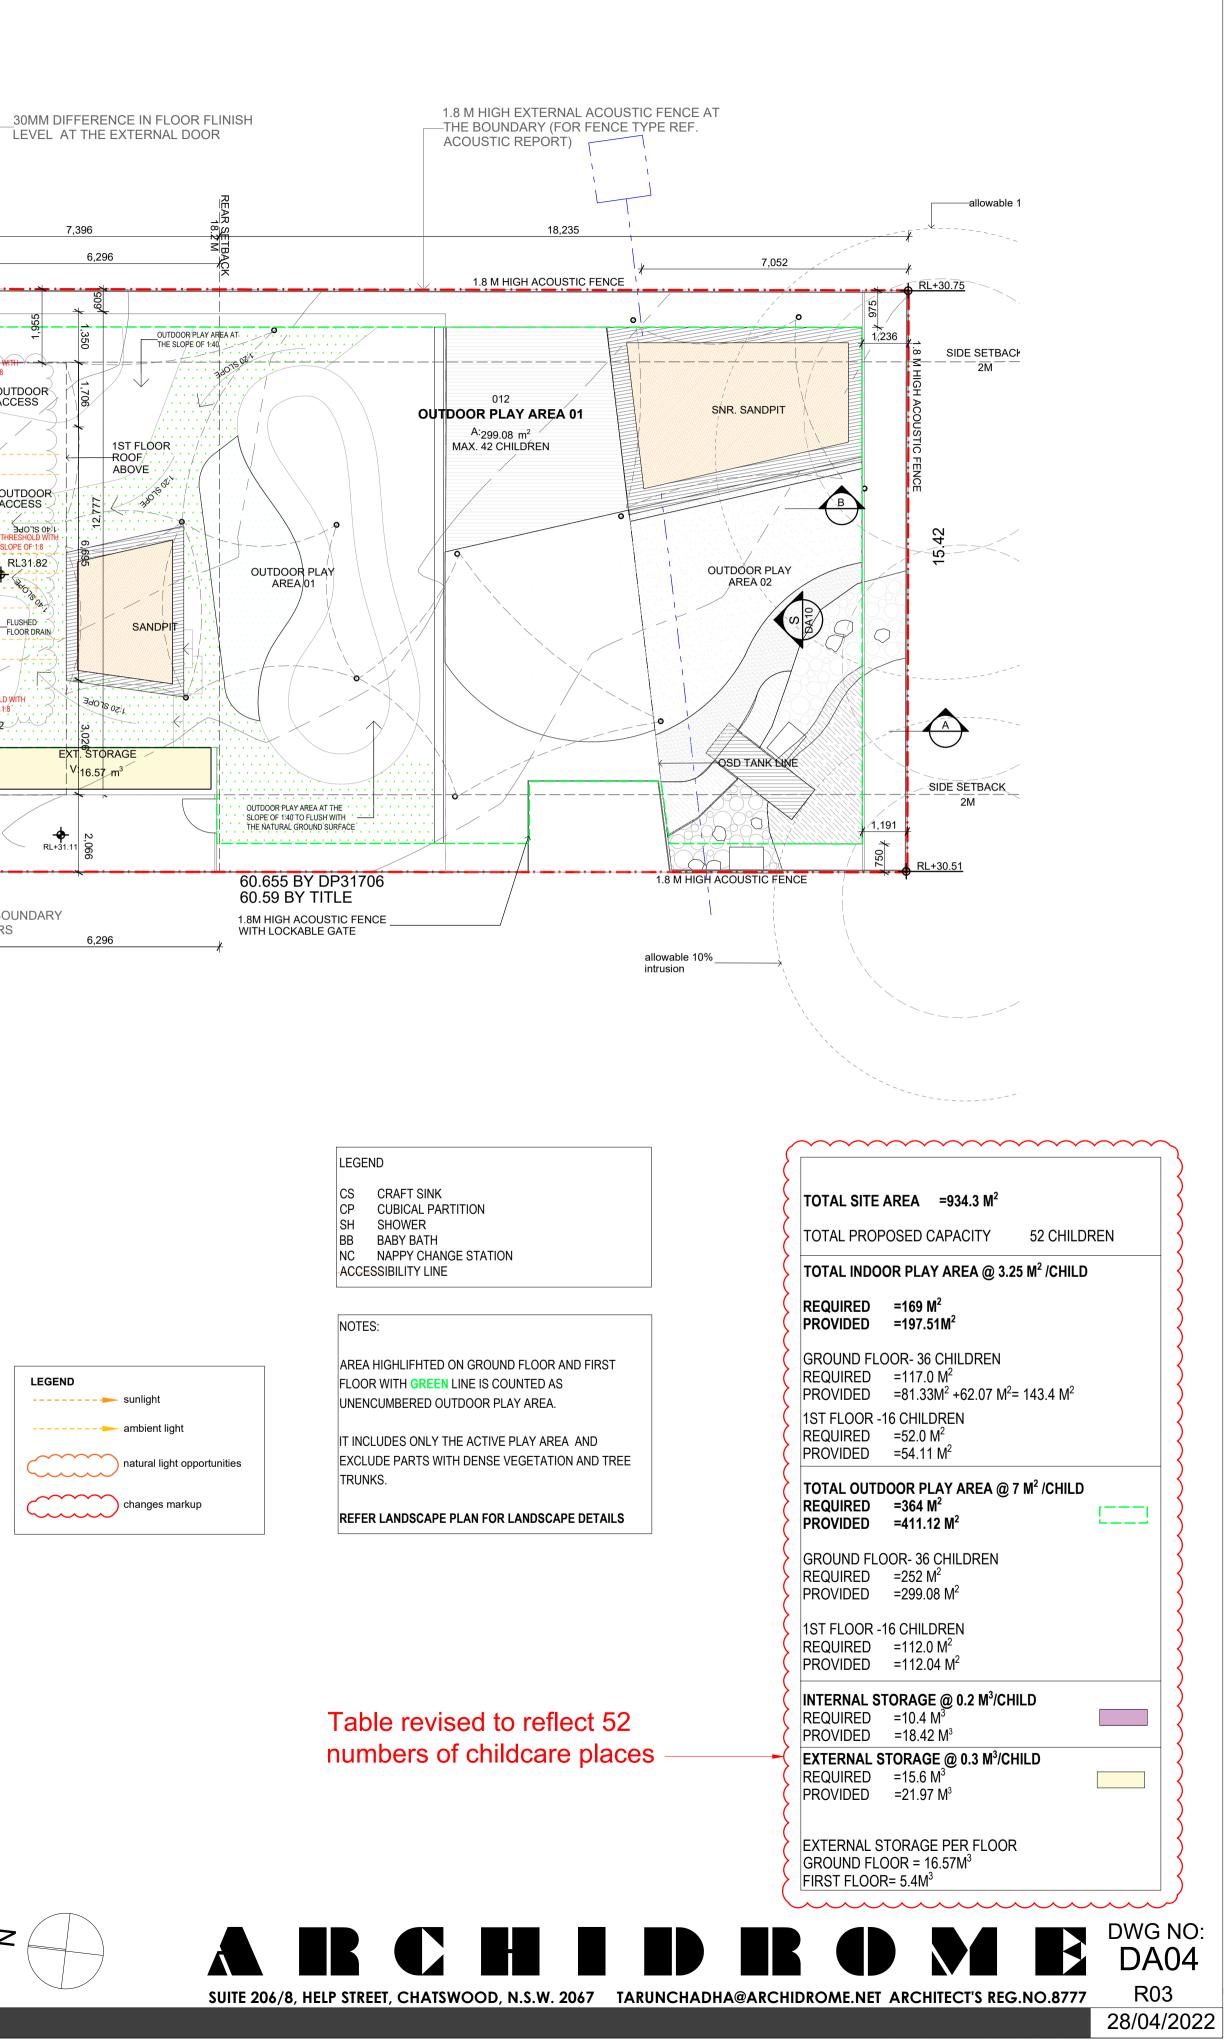

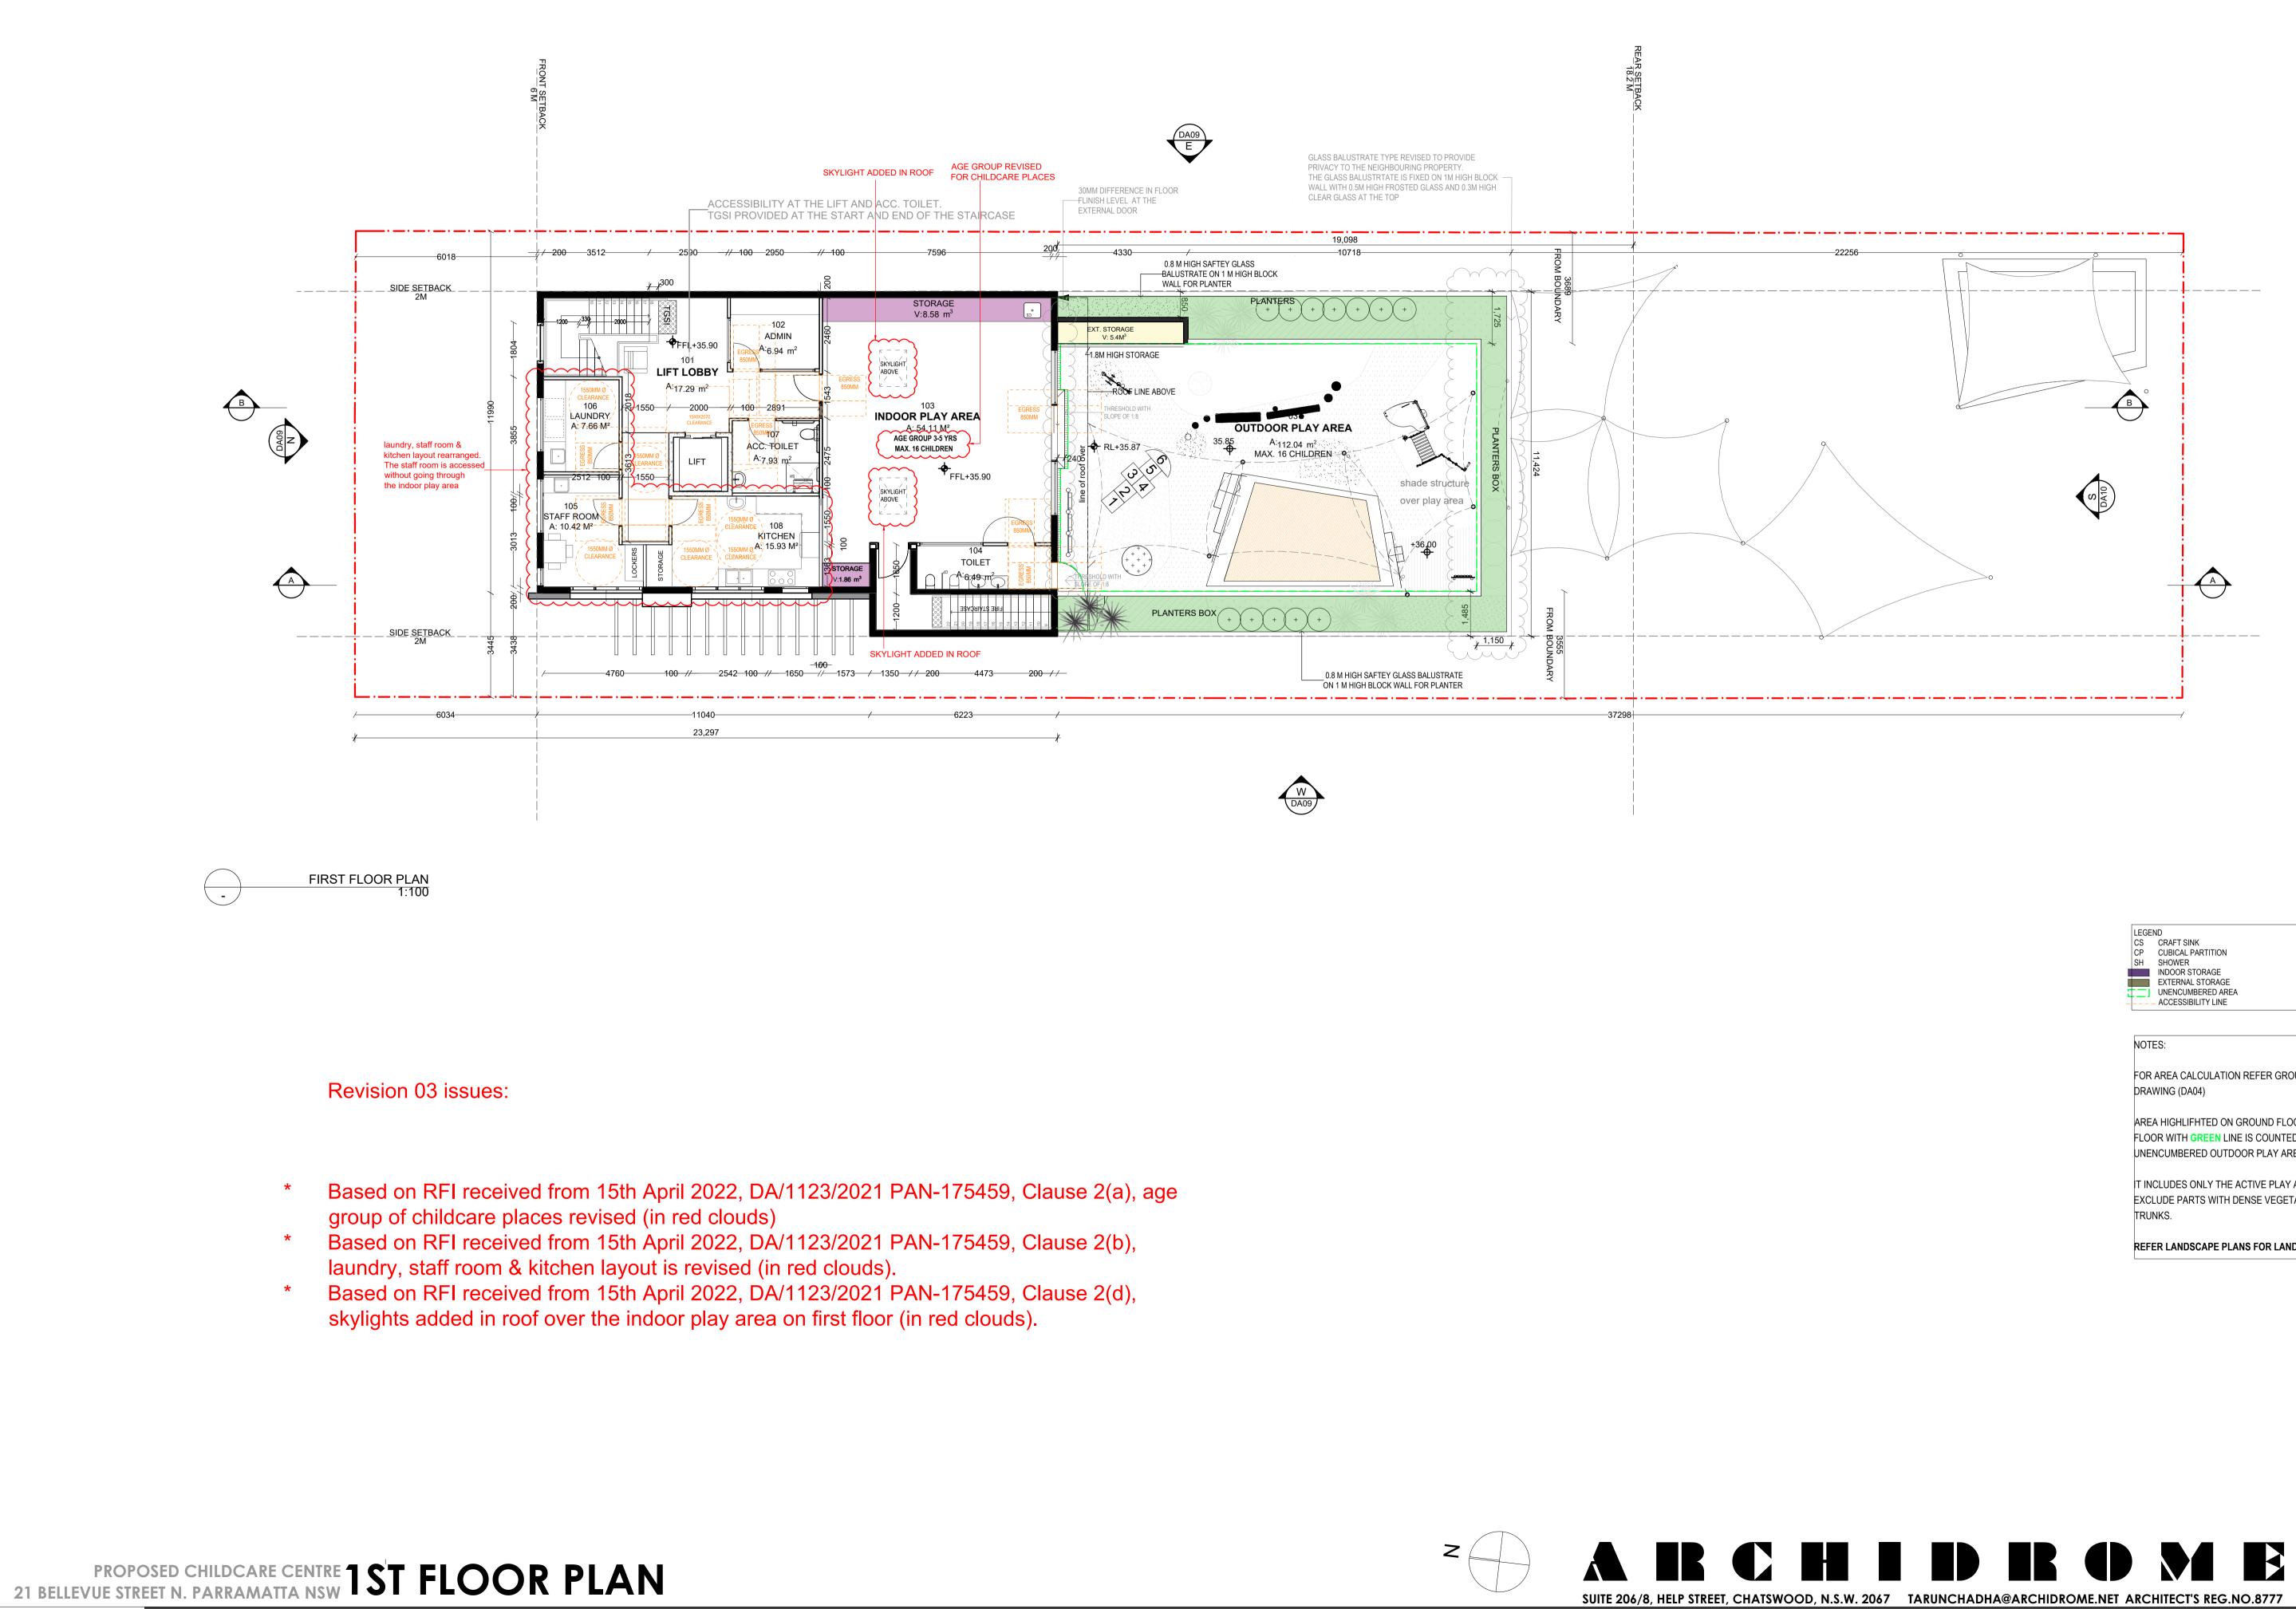


FOR AREA CALCULATION REFER GROUND FLOOR PLAN

AREA HIGHLIFHTED ON GROUND FLOOR AND FIRST FLOOR WITH GREEN LINE IS COUNTED AS UNENCUMBERED OUTDOOR PLAY AREA.

T INCLUDES ONLY THE ACTIVE PLAY AREA AND EXCLUDE PARTS WITH DENSE VEGETATION AND TREE

REFER LANDSCAPE PLANS FOR LANDSCAPE DETAILS



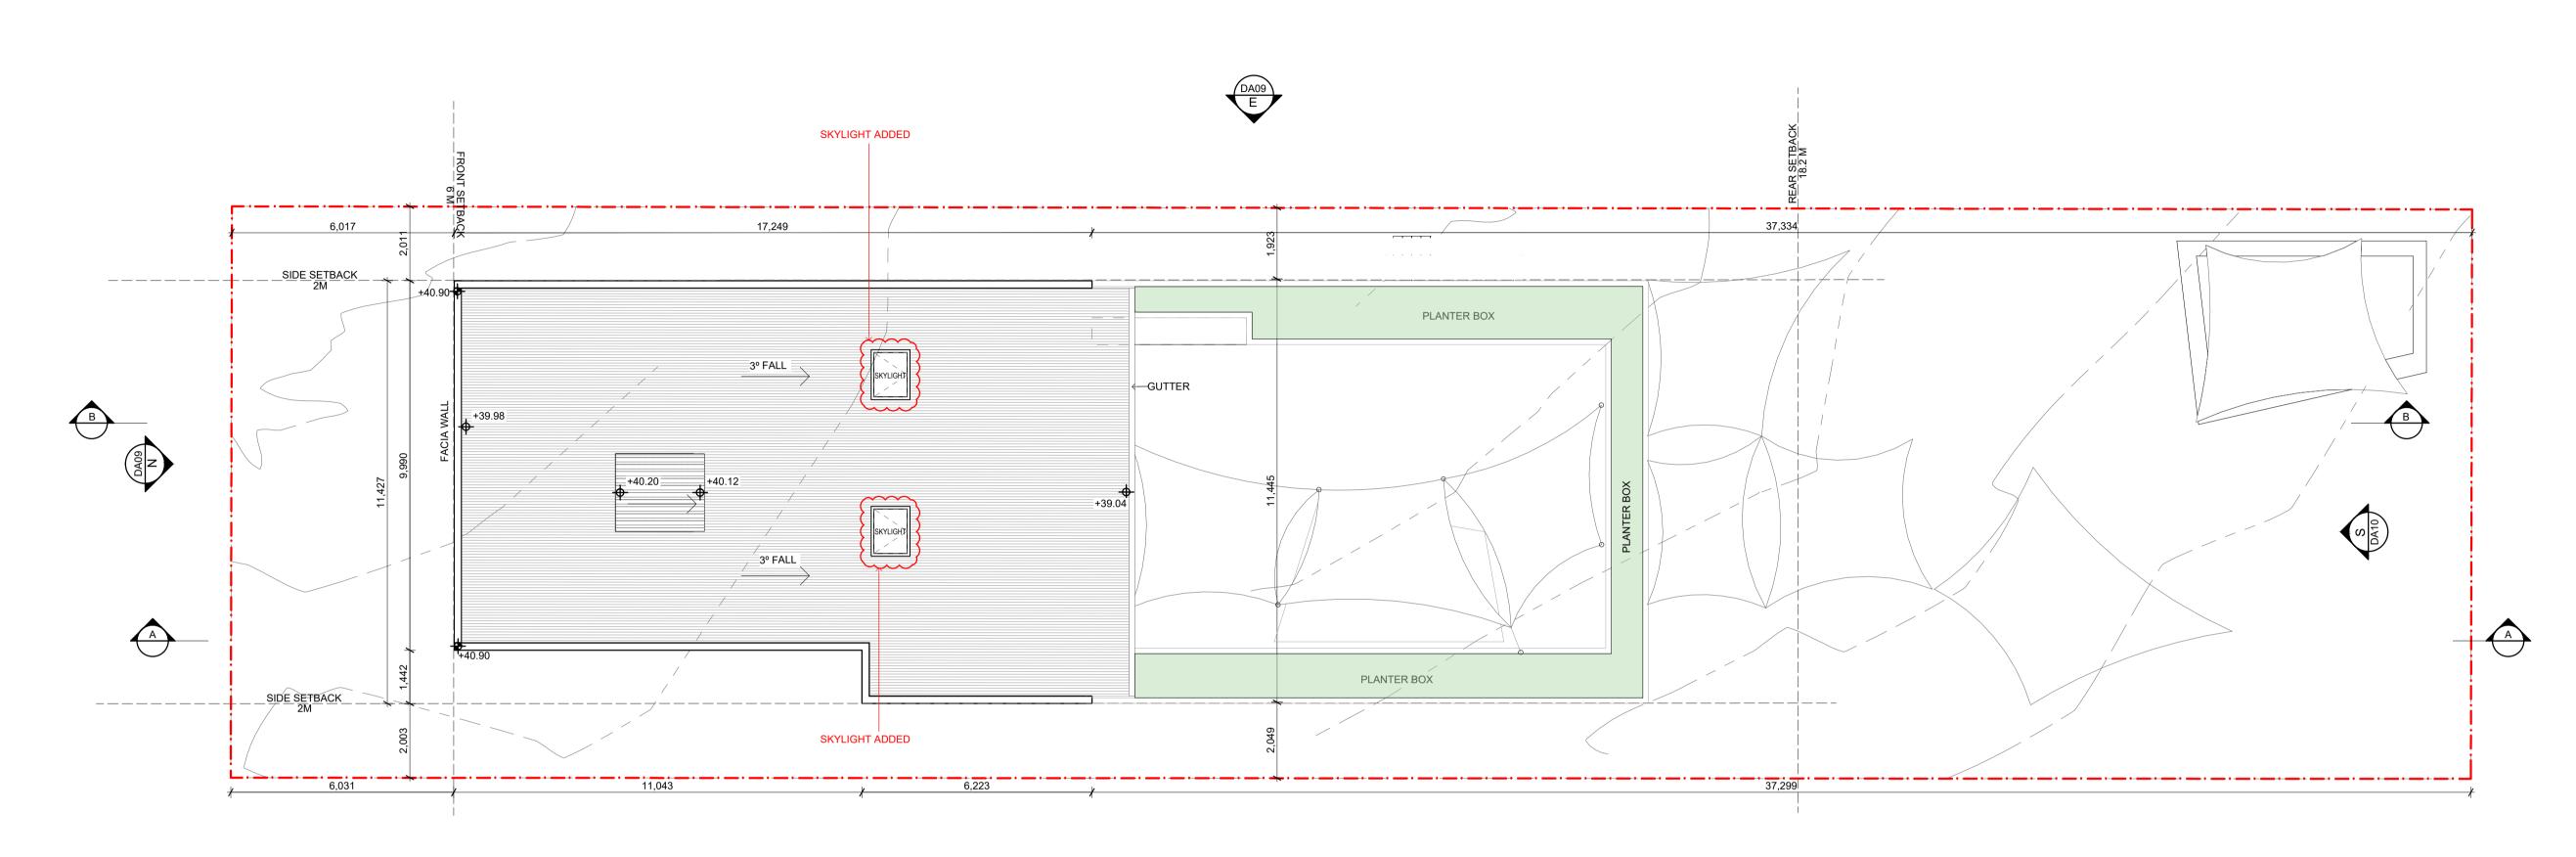




Revision 03 issues:


Based on RFI received from 15th April 2022, DA/1123/2021 PAN-175459, Clause 2(d), * skylights added in roof over the indoor play area on first floor

SCALE: 1:100 A1




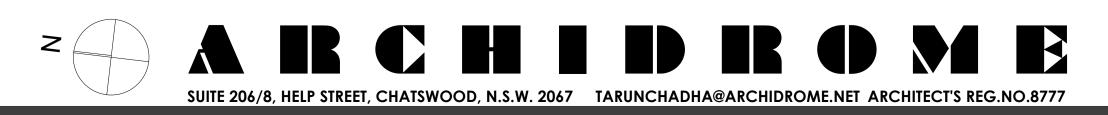





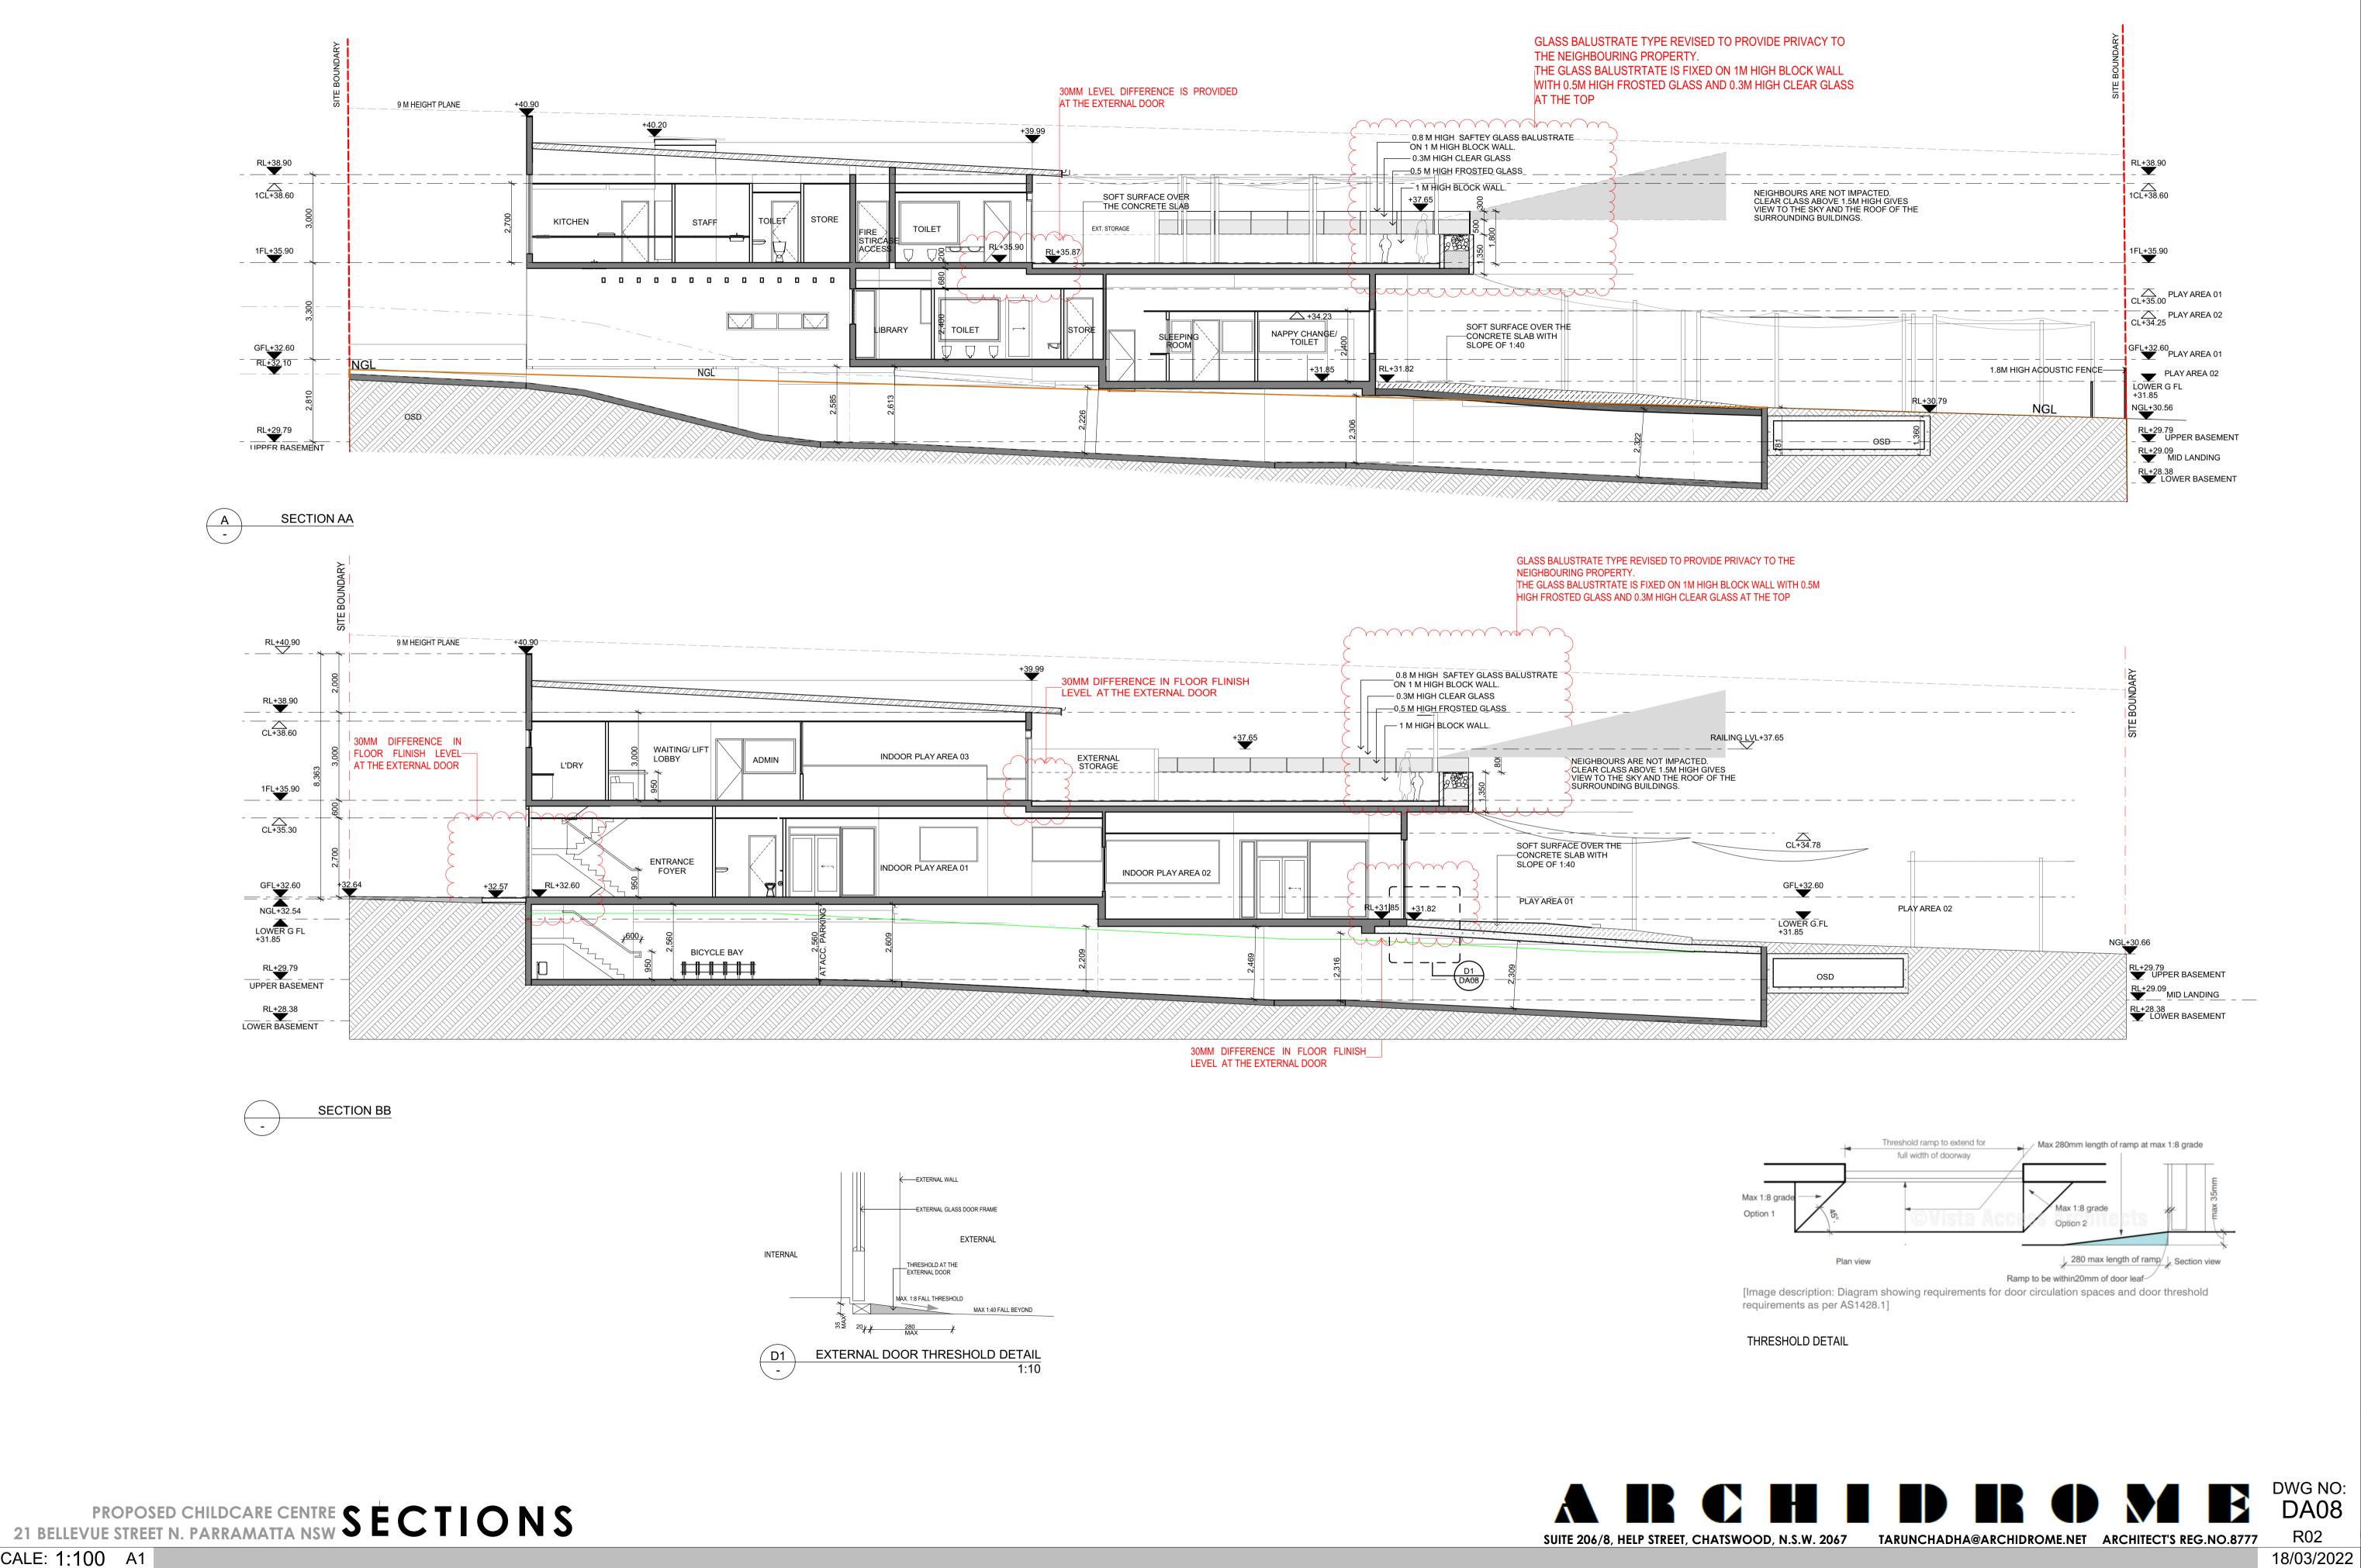

SCALE: 1:100 A1

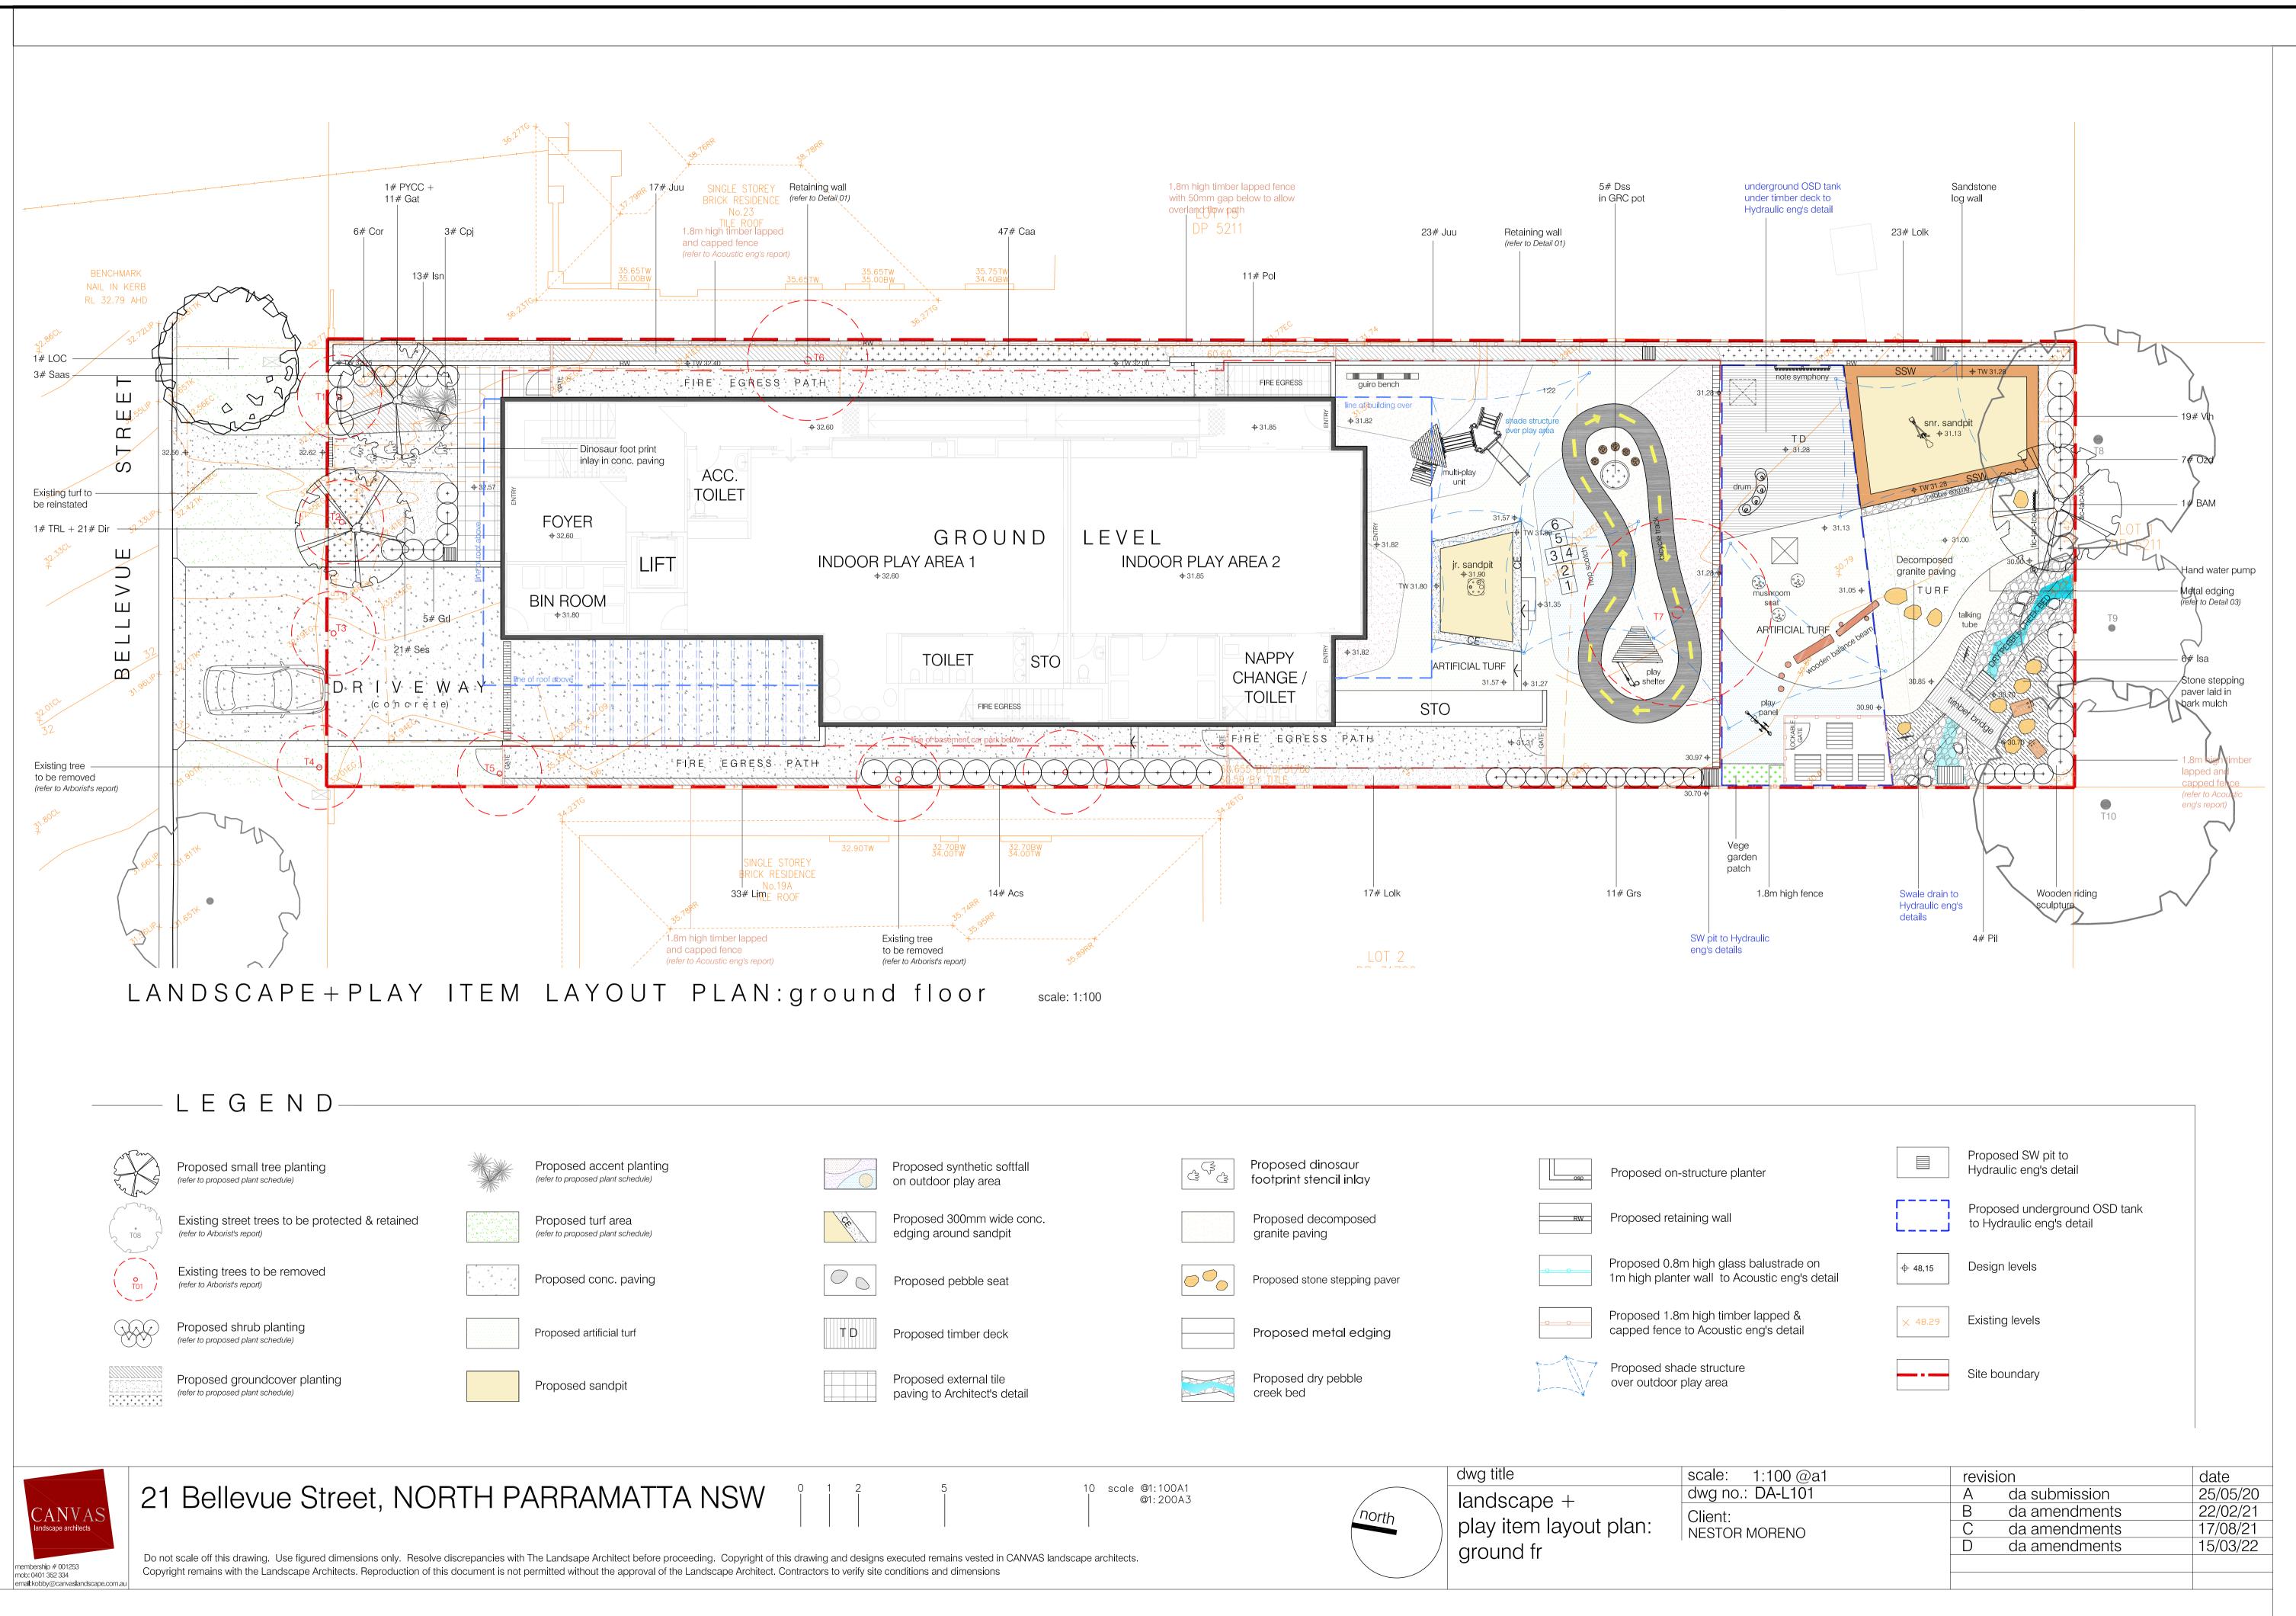

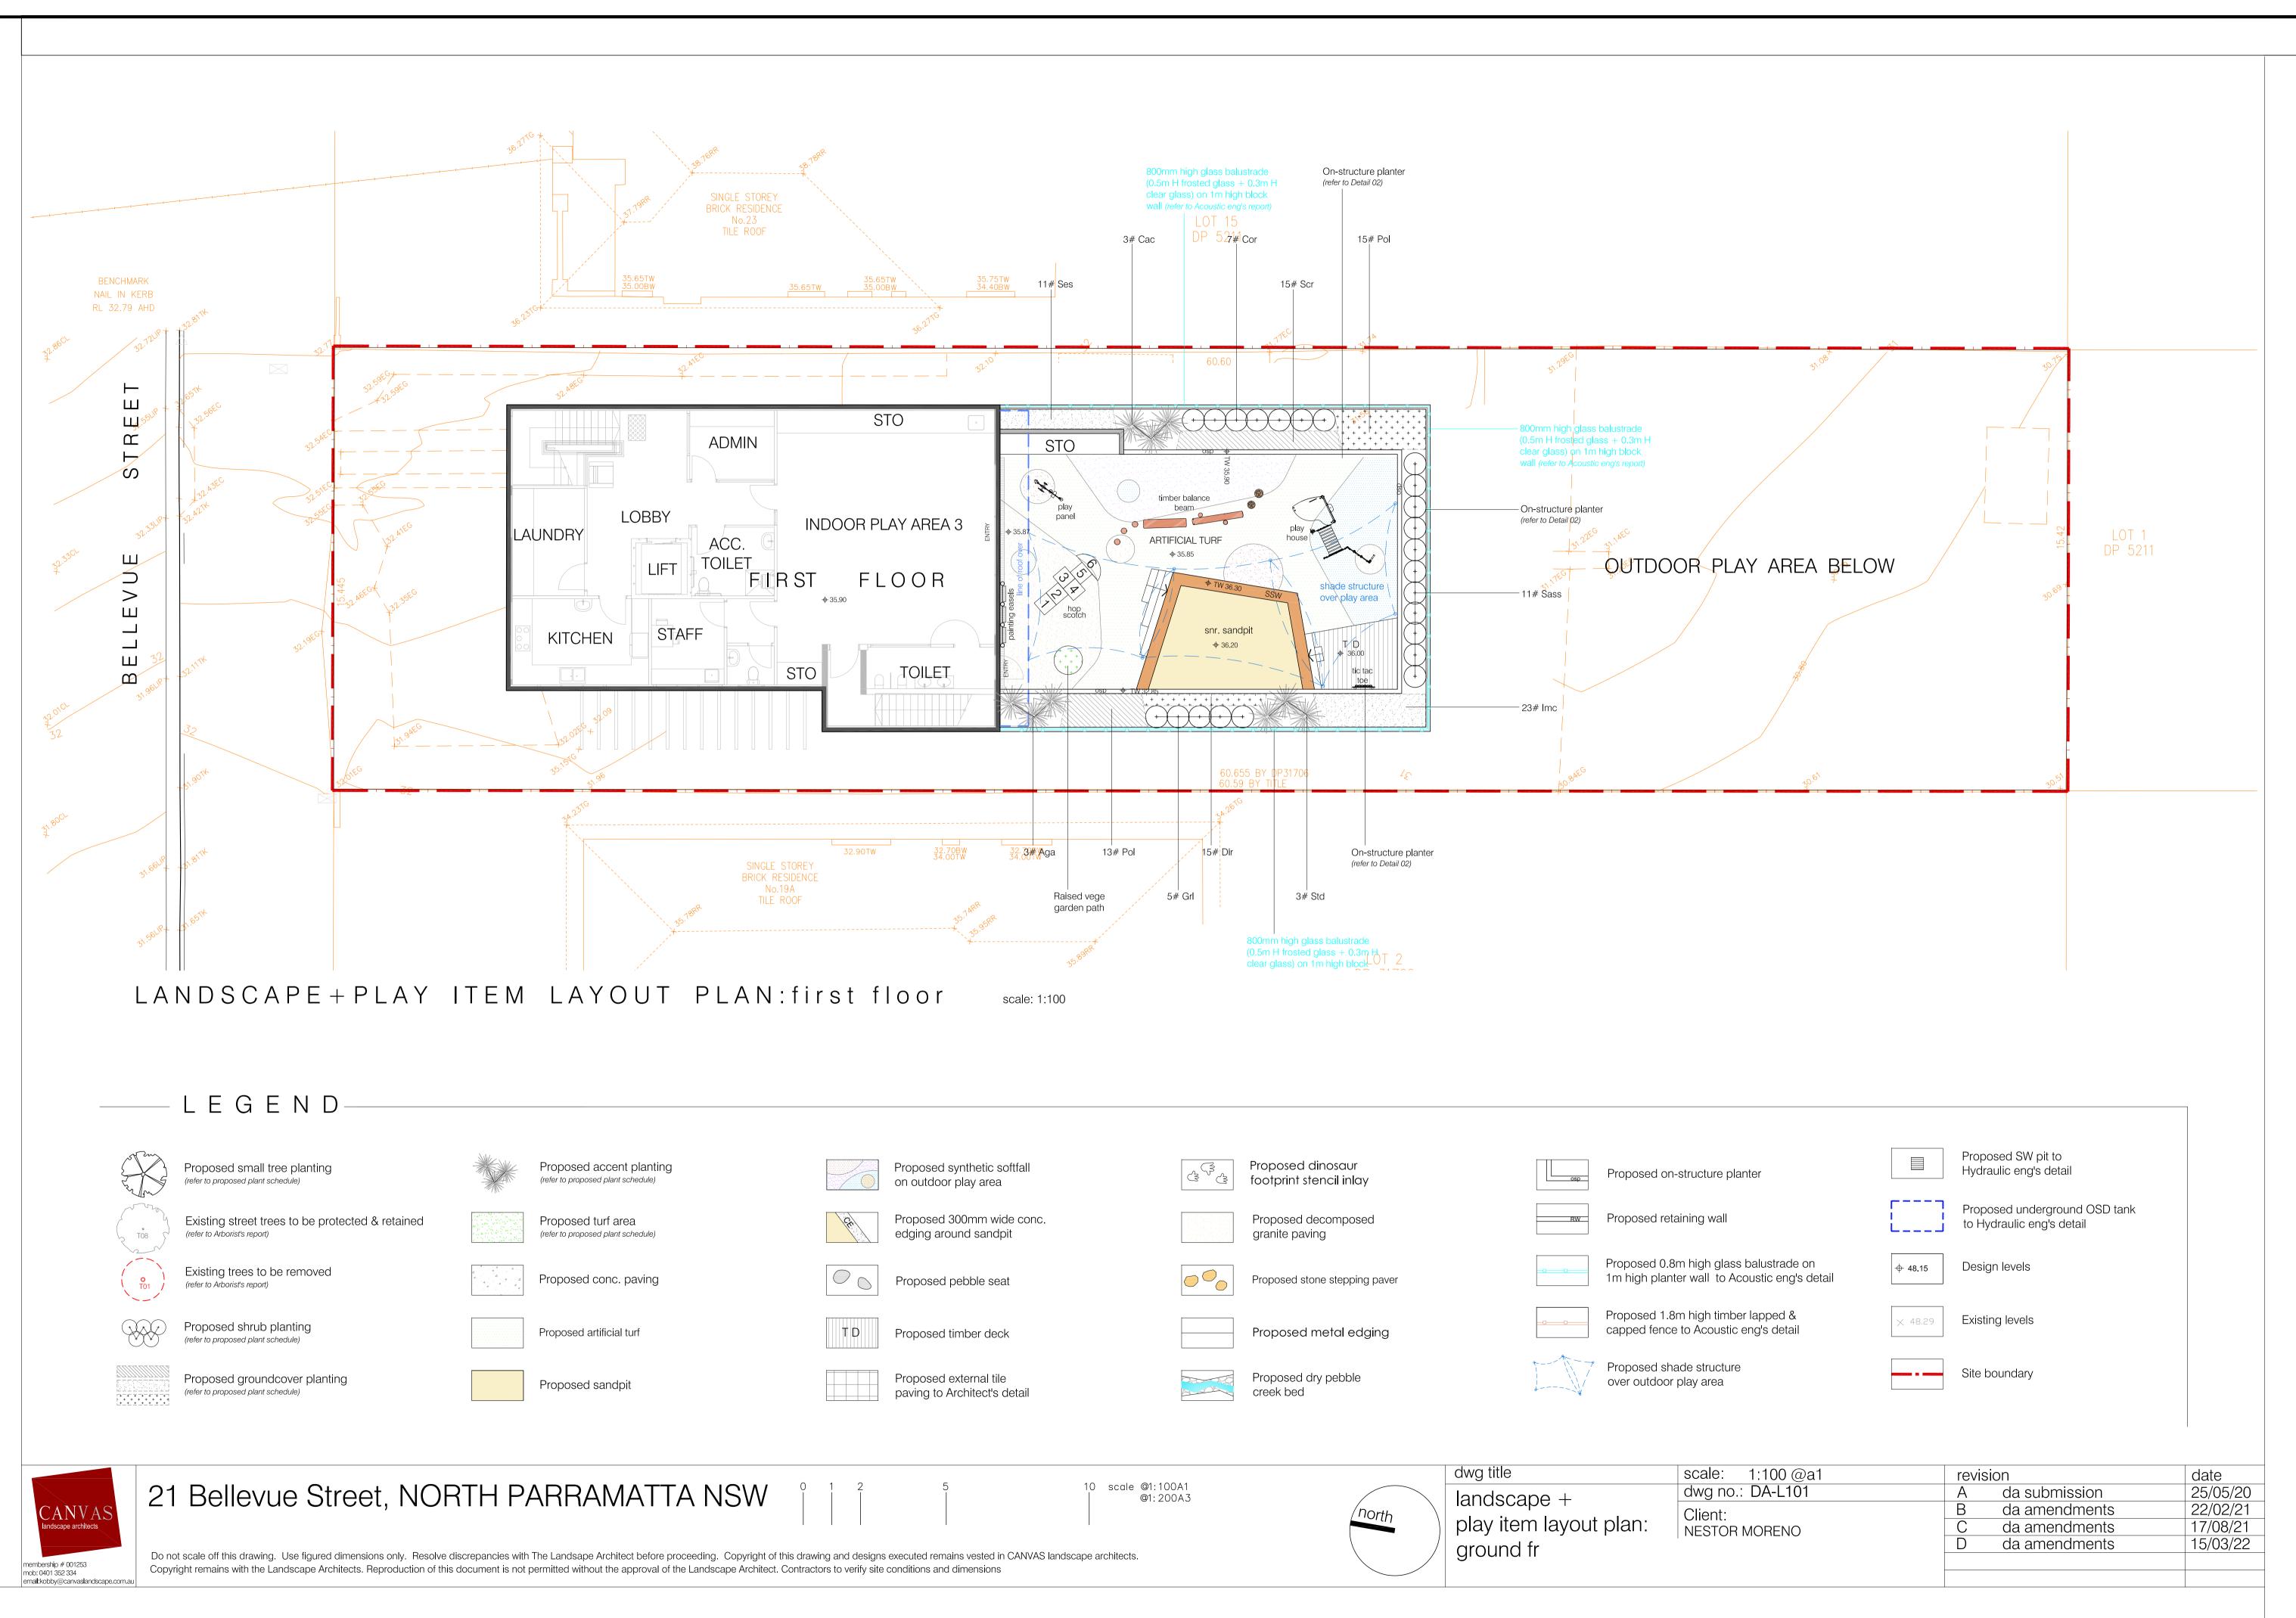

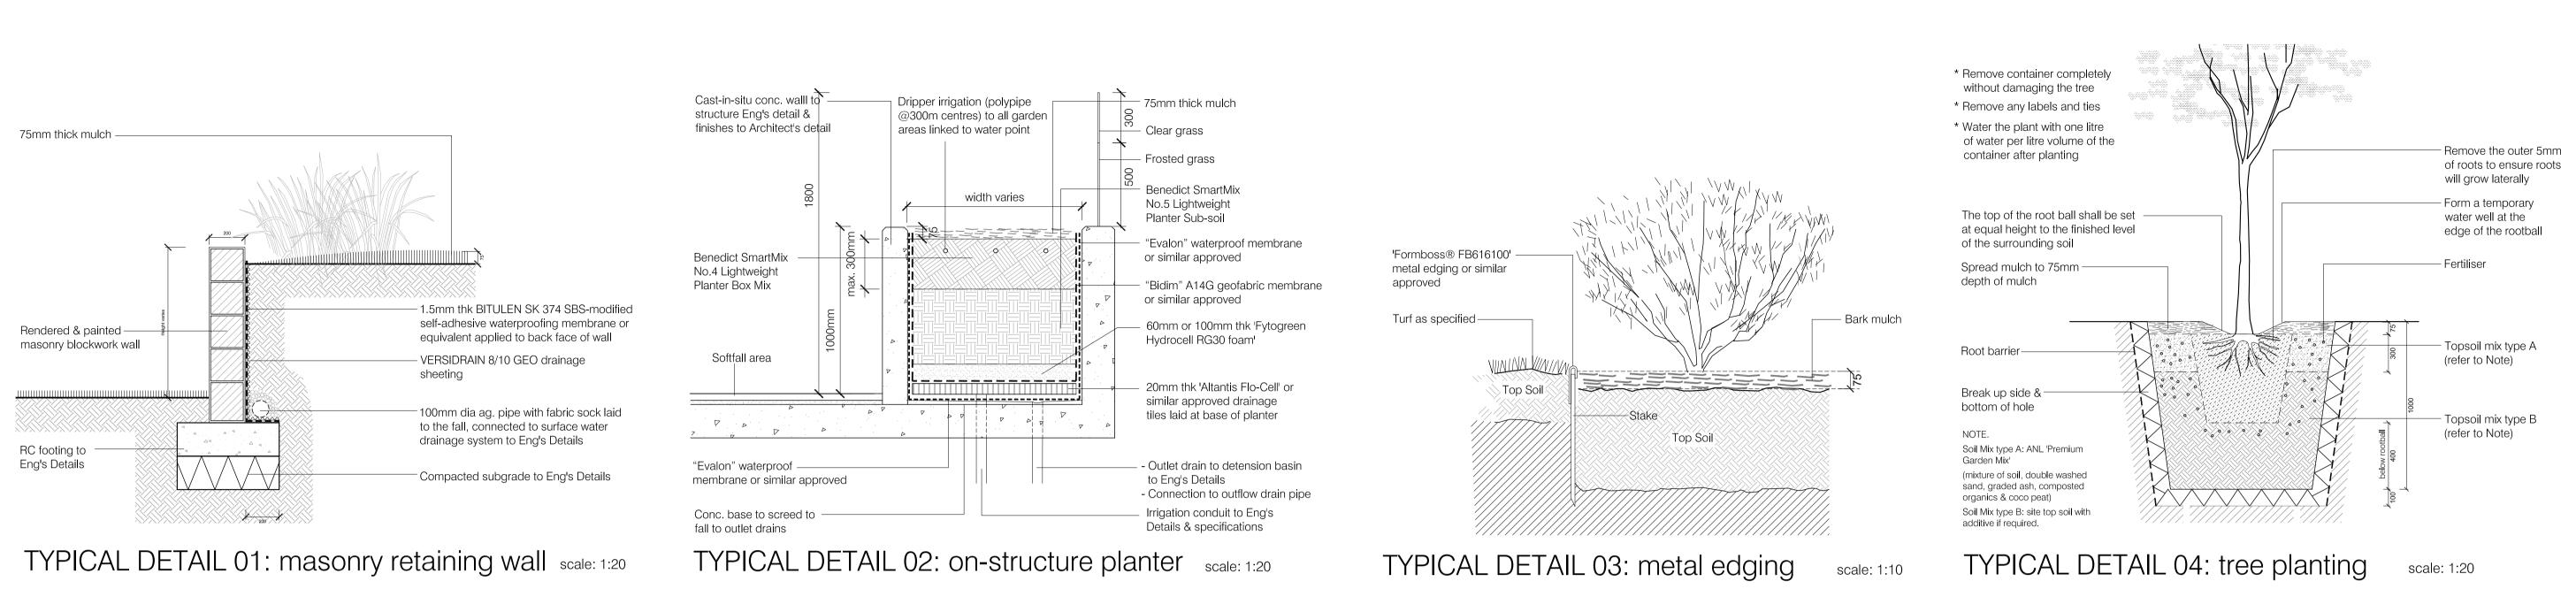

MANTENANCE PROGRAM

The typical range of maintenance tasks required over a 12 month period is summarised in the table.

Any information provided in the table must be assessed in the light of the weather and general site conditions. For example, watering frequency depends on the soil drainage and rainfall; fertiliser type and frequency needs to be adjusted to suit the plant requirements and the soil fertility and pH.

MULCH

Mulch will need be topped up periodically to maintain a min. depth of 75mm. Mulch should be kept at least 50mm away from plant stems to reduce the rick of collar rot.

Weeds in mulched beds will need to be controlled by hand pulling or by the use of non residual herbicides. When using herbicides be very careful to avoid spray drifting onto valuable plants. the smallest contact with the chemicals can cause damage.

PLANT MAINTENANCE


Deep watering once or twice a week is more beneficial to plants than frequent light watering. Frequent watering will produce shallow roots and make the plant less stable and susceptible to drought. Maintain moisture to the bottom of the rootball for the first 3 months. To help safeguard plants remove labels immediately after planting. Where plants are susceptible to damage by vehicles to pedestrians, maintain protective fences until plants are well established. Replace dead plants fortnightly until such time as alternative maintenance procedures are in places.

LAWN MAINTENANCE

Once lawn has been established, carry out watering and fertilising as suggested in the typical maintenance program. In summer, through watering, two or three times each week will encourage roots to go deeper in search of water. Mow grass as required to maintain an even tidy appearance.

	Frequency							
Maintenance Task	January	February	March	April	May	June	July	
Grass								
Mowing lawn		WEEKI			AS R	EQUIRED		
Watering lawn	TV	VICE WEE	KLY			AS REQU	RED	
Feritilising lawn								
Weed control								
Top dressing								
Aerating				PRIOR	TO RESE	DING		
Reseeding								
Trees & Shrubs								
Watering		WEEKLY				AS REQU	IRED	
Feritilising								
Pruning								
Mulching								
Weed control								
Thinning								
Insect & disease control								

PROPOSED PLANTING & SAMPLE PLAY ITEMS IMAGE PALETTE

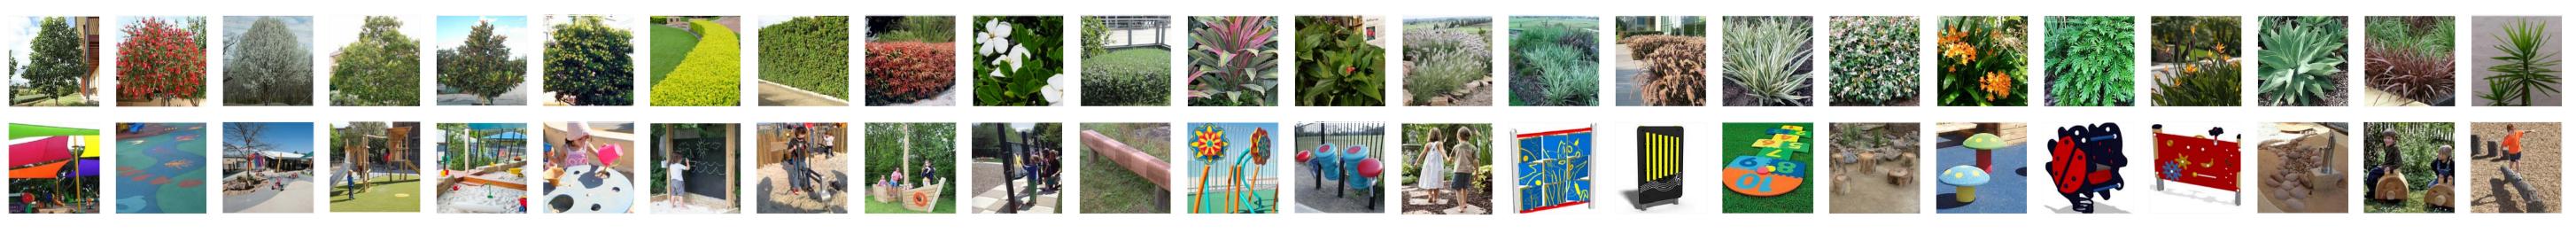



21 Bellevue Street, NORTH PARRAMATTA NSW

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PROPO	SED	ΡΙΑΝΤ	SCHE

CODE	BOTANICAL NAME	COMMON NAME	POT SIZE	MATURE HEIGHT	NO
	TREES				
BAM	Backhousia myrtifolia	Grey Myrtle	75L	4m	1
LOC	Lophostemon confertus (street tree)	Brushbox	75L	15m	1
PYCC	Pyrus calleryana 'Chanticleer'	Calleryana Pear	100L	11m	1
TRL	Tristaniopsis laurina	Water Gum	100L	8m	1
	SCREEN & BARRIER SHRUBS	1	-		
Acs	Acmena smithii var.minor	Dwarf Lillypilly	25L	3m	14
Cor	Correa reflexa	Native Fuchsia	200mm	1.2m	13
Grl	Grevillea linearifolia	White Spider Flower	200mm	1m	10
Grs	Grevillea sericea	Silky Grevillea	200mm	1.5m	11
Ozd	Ozothamnus diosmifolius	Rice Flower	200mm	2m	7
Pil	Pimelea linifolia	Slender Rice Flower	200mm	1.5m	4
Isa	Isopogon anemonefolius	Drumsticks	200mm	1.8m	6
Saas	Syzygium australe 'Aussie Southern'	Syzygium 'Aussie Southern'	5L	2m	14
	ACCENT PLANTS				
Aga	Agave attenuata	Century Plant	200mm	1.5m	3
Cac	Cordyline australis 'Cabernett'	Cordyline Cabernett	200mm	1.2m	3
Срј	Cordyline "Pink Joy"	Pink Joy Cordyline	150mm	1.2m	3
Std	Strelitzia reginae dwarf	Dwarf Bird-of-Paradise	200mm	0.6m	3

	dwg title	scale: as shown @a1	revision	date
	landaaana turiaal	dwg no.: DA-L103	A da submission	25/05/20
	landscape typical	Client:	B da amendments	22/02/21
	details & plant schedule	NESTOR MORENO	C da amendments	17/08/21
		1	D da amendments	15/03/22
and designs executed remains vested in CANVAS landscape architects. to verify site conditions and dimensions				

EDULE

CODE	BOTANICAL NAME	COMMON NAME	POT SIZE	MATURE HEIGHT	NO
	GROUND COVERS				
Caa	Carex appressa	Tall Sedge	150mm	0.7m	21
Dir	Dianella revoluta 'little rev'	Black Anther Flax Lily	150mm	0.3m	36
Dss	Dianella Silver Streak	Silver Streak Flax Lily	150mm	0.4m	5
Gat	Gazania tomentosa	Gazania	140mm	0.15m	11
Imc	Imperata cylindrica	Blady Grass	150mm	0.6m	23
lsn	Isolepis nodosa	Nobby Club-rush	150mm	0.5m	13
Juu	Juncus usitatus	Tussock Rush	150mm	1m	40
Lim	Liriope muscari 'Variegata'	Variegata Lily Turf	150mm	0.3m	33
Lolk	Lomandra longifolia 'Katrinus'	Spiny-headed Mat-rush 'Katrinus'	150mm	0.7m	38
Pol	Poa labilladieri	Tussock Grass	150mm	0.8m	39
Scr	Scaevola ramosissima	Puple Fan Flower	150mm	0.4m	15
Ses	Senecio lautus	Variable groundsel	100mm	0.4m	32
Vih	Viola hederacea	Native Violet	100mm	0.2m	19
	TURF GRASS				
As noted	Stenotaphrum secundatum	Sir Walter Buffalo	roll		75m2

ΝΟΤΕ

local native plant species of the P arramatta LGA as per Parramatta Biodiversity Strategy Vol. 2