DRAWING LIST

00	COVER SHEET
01	SITE LOCATION
02	SITE PLAN
03	BASEMENT FLOOR PLAN
04	GROUND FLOOR PLAN
05	LEVEL 1 FLOOR PLAN
06	LEVEL 2-4 FLOOR PLAN
07	TYPICAL FLOOR PLAN (LEVEL 5-11)
08	ROOF PLAN
09	SECTION A
10	SECTION B
11	SECTION C
12	NORTH & SOUTH ELEVATIONS
13	EAST ELEVATION
14	WEST ELEVATION
15	FSR AREA CALCULATION
16	AMENITY AREA DIAGRAMS
17	SHADOW DIAGRAMS - SHEET 1
18	SHADOW DIAGRAMS - SHEET 2
19	SHADOW DIAGRAMS - SHEET 3
20	SHADOW DIAGRAMS - SHEET 4
21	181 MACQUARIE ST & 12 CHARLES ST GFA DIAGRAM
21	SOLAR STUDY DIAGRAMS
22	SOLAR STUDY DIAGRAMS
23	ROOM TYPE A, A.1 & B
24	ROOM TYPE C & D
25	ROOM TYPE E - ADAPTABLE ROOM
26	3D VIEW
27	SURVEY PLAN



DEVELOPMENT APPLICATION FOR THE PROPOSED NEW STUDENT ACCOMMODATION

AT 183 MACQUARIE STREET, PARRAMATTA



PREPARED FOR

SITE LOCATION PLAN 1:5000

LOCATION PLAN LEGEND

SUBJECT SITE

PRINCIPLE PEDESTRIAN ACCESS

BUS STOP

TRAIN STATION

LIGHT RAIL FERRY WHARF

GOGET CARSHARE

RAPISARDA

VIEW FROM EAST (MACQUARIE STREET)



VIEW FROM WEST (MACQUARIE STREET)



VIEW FROM NORTH (MACQUARIE STREET)

INVESTMENTS

DEVELOPMENT APPLICATION NEW STUDENT ACCOMMODATION AT 183 MACQUARIE STREET, PARRAMATTA


SITE LOCATION

NR/LZ CHECKED BY:

> SCALE: 1:5000, 1:4.05 AT A3

DA

Main Office: Level 2, 68 Sophia Street, Surry Hills NSW 2010 Parramatta Office: Suite 4103, 11 Hassall Street, Parramatta NSW 2150 ARCHITECTURE
Tourism + Residential + 61 2 9283 0860 | www.ptiarchitecture.com.au Nominated Registered Architect: Peter Israel (reg no 5064) ABN 90 050 071 022

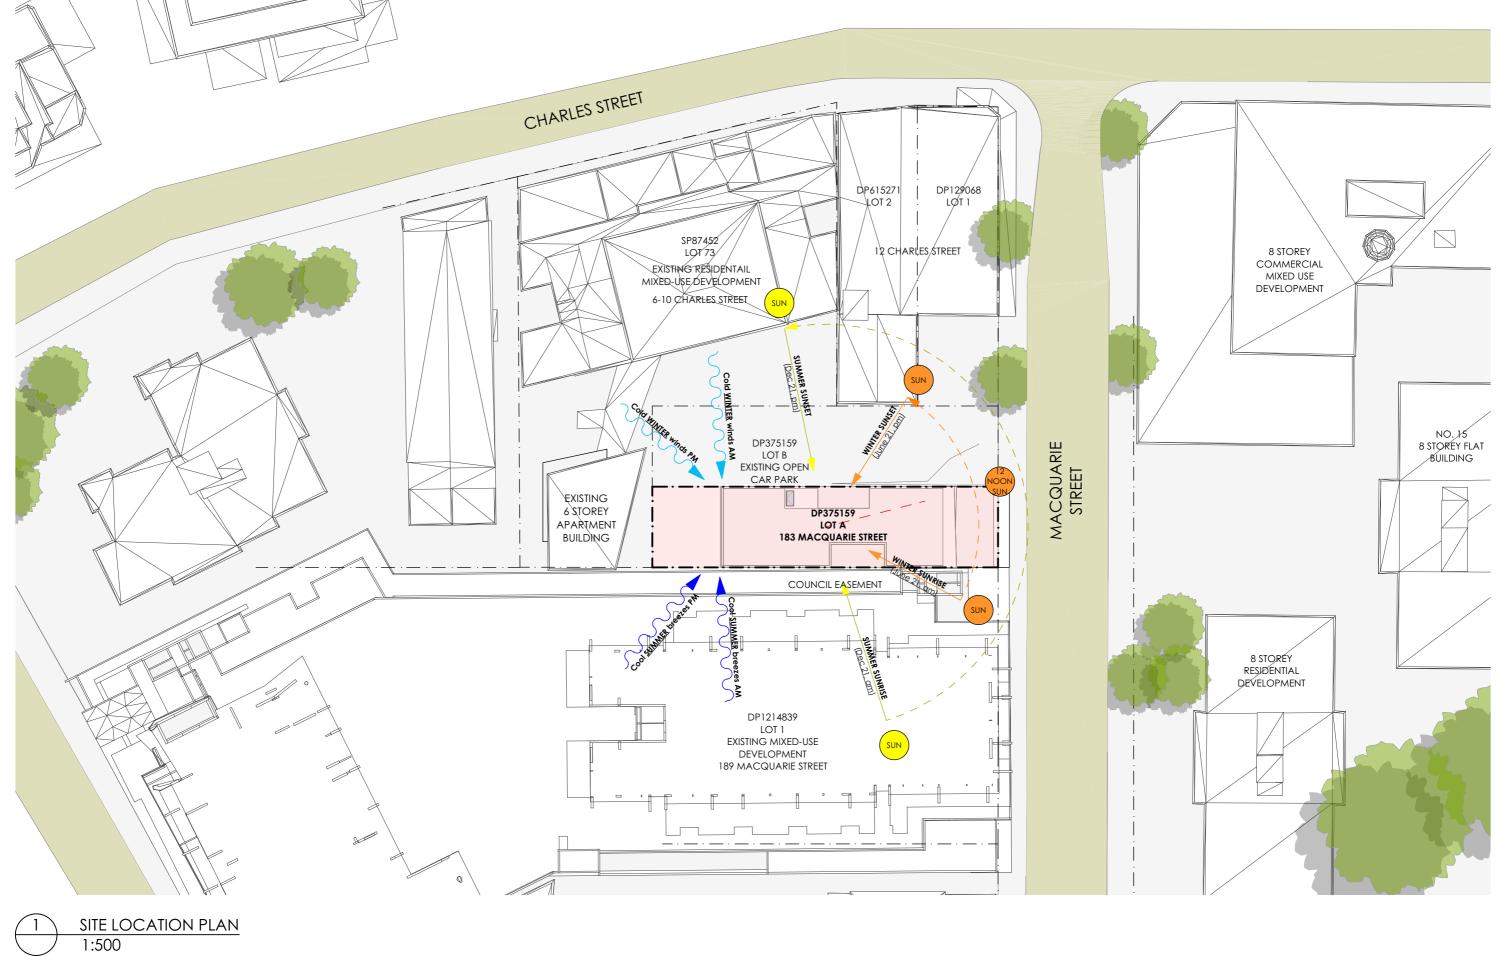



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ABN 90 050 071 022

REV DESCRIPTION

A Development Application

NR 13/10/2022

RAPISARDA INVESTMENTS DEVELOPMENT APPLICATION NEW STUDENT ACCOMMODATION AT 183 MACQUARIE STREET, PARRAMATTA

DRAWING TITL

SITE PLAN




DRAWN BY: NR/LZ
CHECKED BY: PI

SCALE: 1:500 AT A3
PROJECT NO: P547

DA

02 dwg no.

A

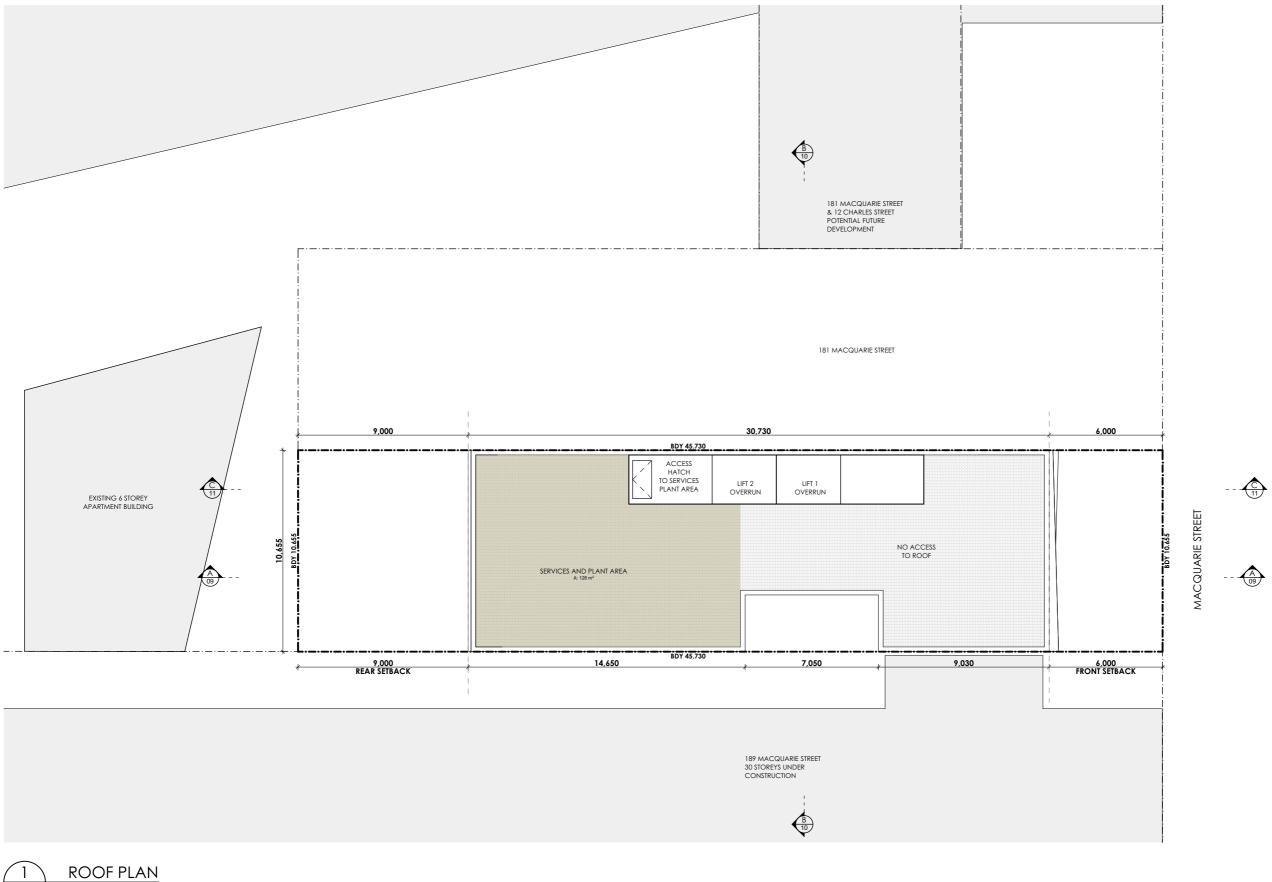

ROOF PLAN 1:200



REV DESCRIPTION

13/10/2022

RAPISARDA **INVESTMENTS** DEVELOPMENT APPLICATION NEW STUDENT ACCOMMODATION AT 183 MACQUARIE STREET, PARRAMATTA

ROOF PLAN




NR/LZ

CHECKED BY: PI SCALE: 1:200 AT A3 PROJECT No: P567

DA

80

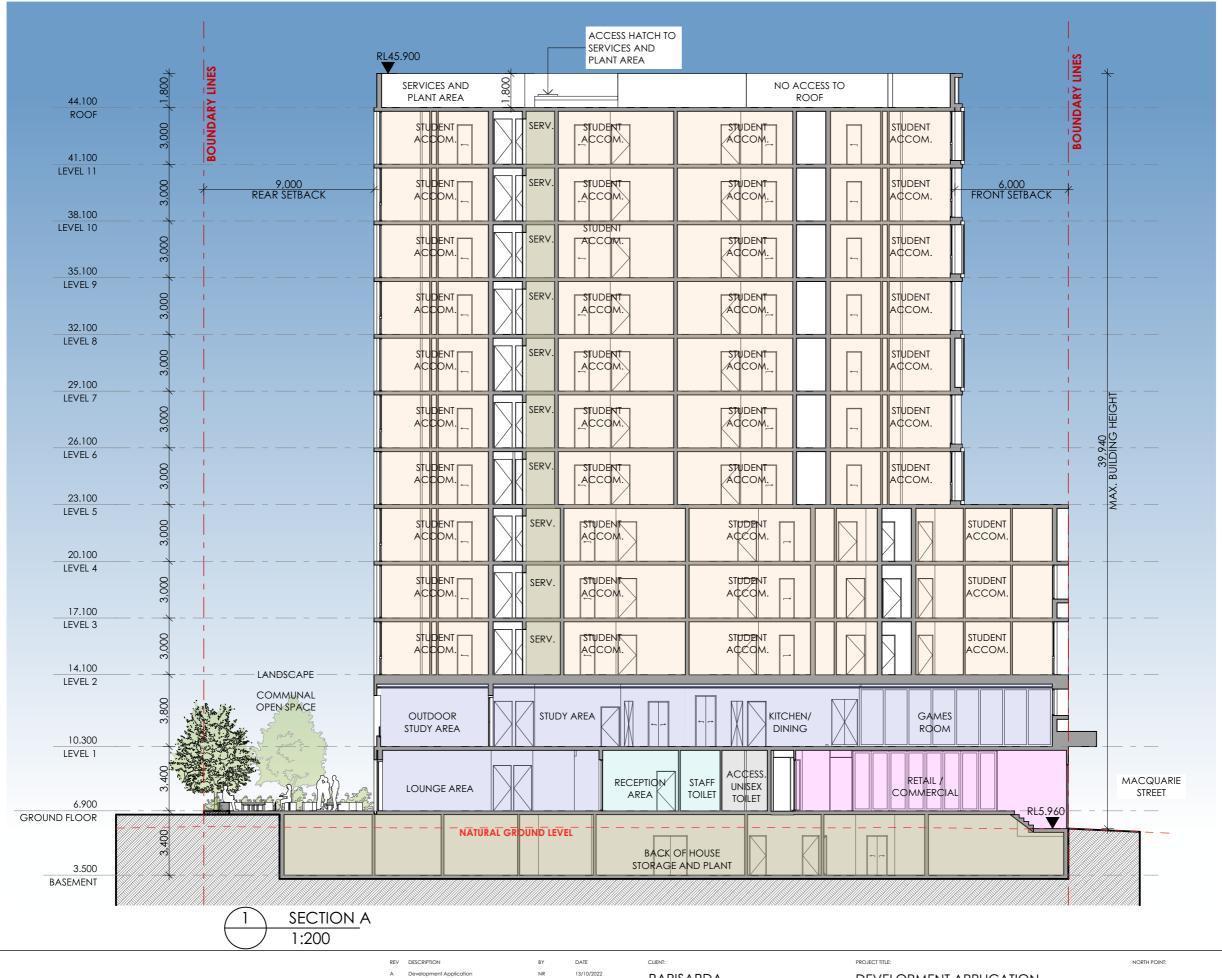



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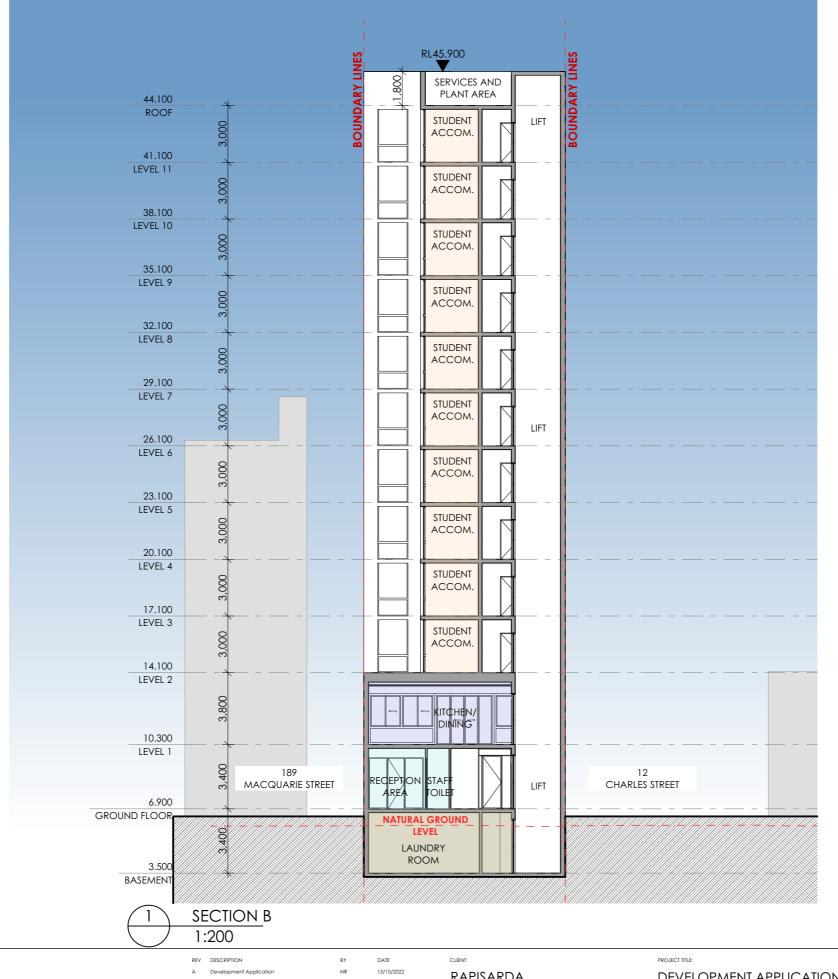
RAPISARDA INVESTMENTS **DEVELOPMENT APPLICATION** NEW STUDENT ACCOMMODATION AT 183 MACQUARIE STREET, PARRAMATTA

SECTION A



DRAWN BY: NR/LZ CHECKED BY: PI

SCALE: 1:200 AT A3 PROJECT No: P567





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ABN 90 050 071 022

RAPISARDA **INVESTMENTS** **DEVELOPMENT APPLICATION** NEW STUDENT ACCOMMODATION AT 183 MACQUARIE STREET, PARRAMATTA

SECTION B




NR/LZ

CHECKED BY: PI SCALE: 1:200 AT A3 PROJECT No: P567

DA

10

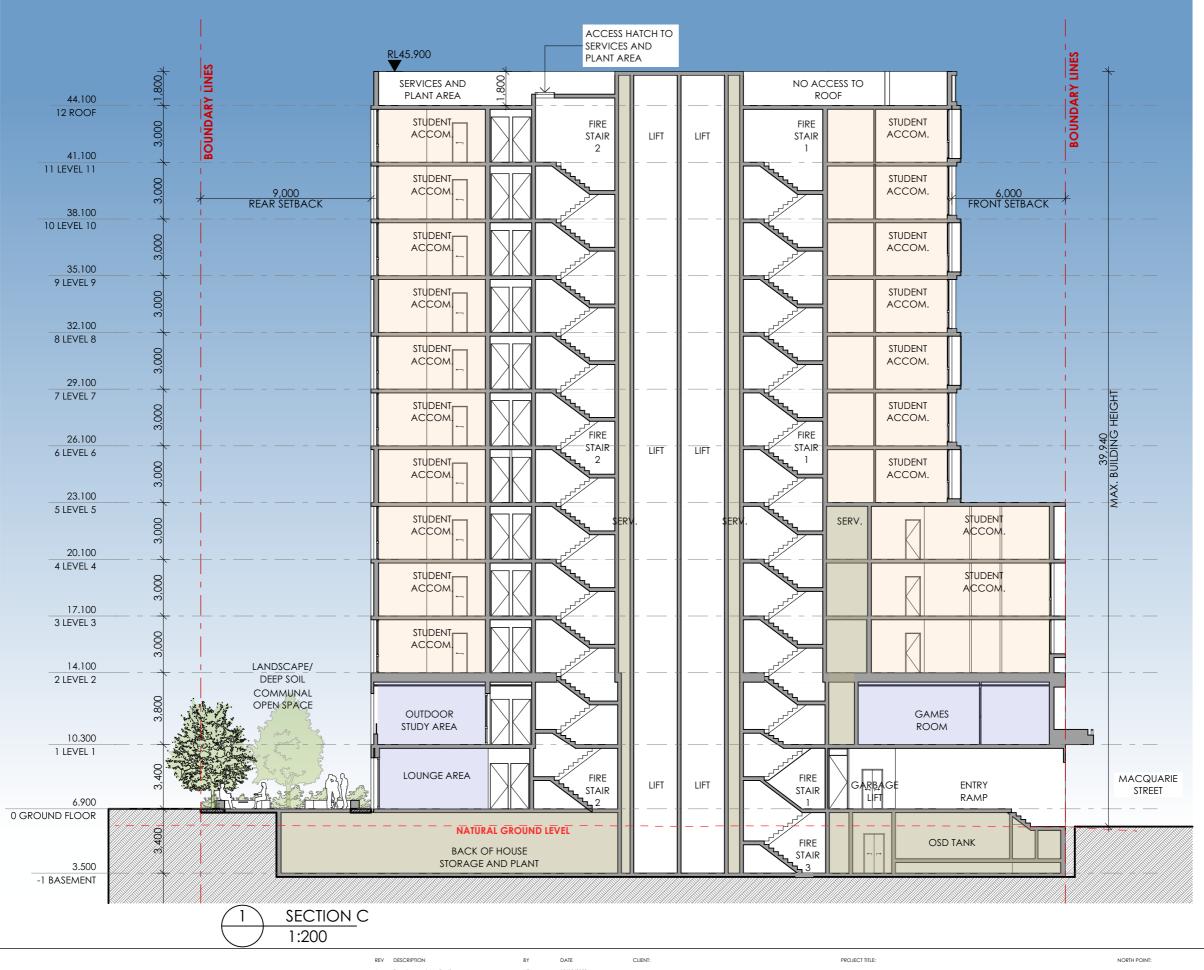

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13/10/2022

RAPISARDA INVESTMENTS **DEVELOPMENT APPLICATION** NEW STUDENT ACCOMMODATION AT 183 MACQUARIE STREET, PARRAMATTA

SECTION C



DRAWN BY: NR/LZ CHECKED BY:

SCALE: 1:200 AT A3 PROJECT No: P567



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Nominated Registered Architect: Peter Israel (reg no 5064)
ABN 90 050 071 022

D + DIO + DD +

13/10/2022

Rapisarda Investments DEVELOPMENT APPLICATION
NEW STUDENT ACCOMMODATION AT
183 MACQUARIE STREET, PARRAMATTA

DRAWING TITI

NORTH & SOUTH ELEVATIONS



DRAWN BY: NR/LZ
CHECKED BY: DI

CHECKED BY: PI


SCALE: 1:200 AT A3

PROJECT No: P567

DA

12

revi

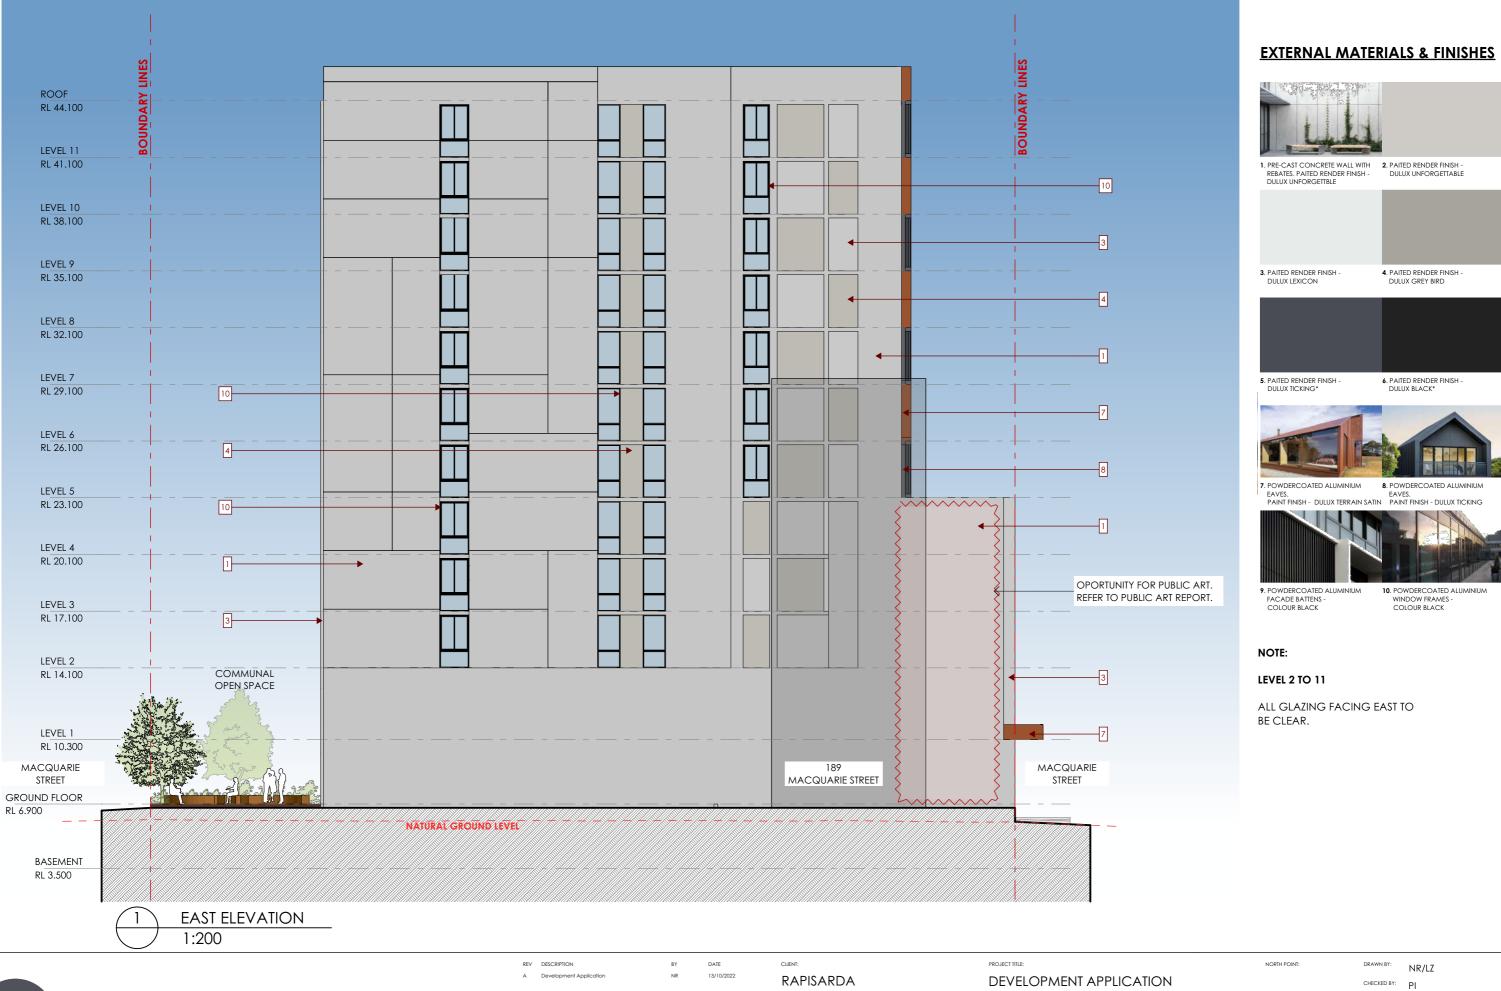

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INVESTMENTS

NEW STUDENT ACCOMMODATION AT 183 MACQUARIE STREET, PARRAMATTA

EAST ELEVATION

SCALE: 1:200 AT A3 PROJECT No: P567

DA

13

EXTERNAL MATERIALS & FINISHES



PRE-CAST CONCRETE WALL WITH
 REBATES, PAITED RENDER FINISH DULUX UNFORGETIBLE

DULUX UNFORGETIBLE

OUT 1. PRE-CAST CONCRETE WALL WITH

A PAITED RENDER FINISH DULUX UNFORGETIBLE



3. PAITED RENDER FINISH -DULUX LEXICON

4. PAITED RENDER FINISH -DULUX GREY BIRD



PAITED RENDER FINISH -DULUX TICKING*

6. PAITED RENDER FINISH -DULUX BLACK*





9. POWDERCOATED ALUMINIUM FACADE BATTENS COLOUR BLACK

10. POWDERCOATED ALUMINIUM WINDOW FRAMES COLOUR BLACK

13/10/2022

RAPISARDA **INVESTMENTS** **DEVELOPMENT APPLICATION** NEW STUDENT ACCOMMODATION AT 183 MACQUARIE STREET, PARRAMATTA

WEST ELEVATION




NR/LZ

CHECKED BY: PI SCALE: 1:200 AT A3 PROJECT No:

P567

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EXISTING SITE AREA= 497m²

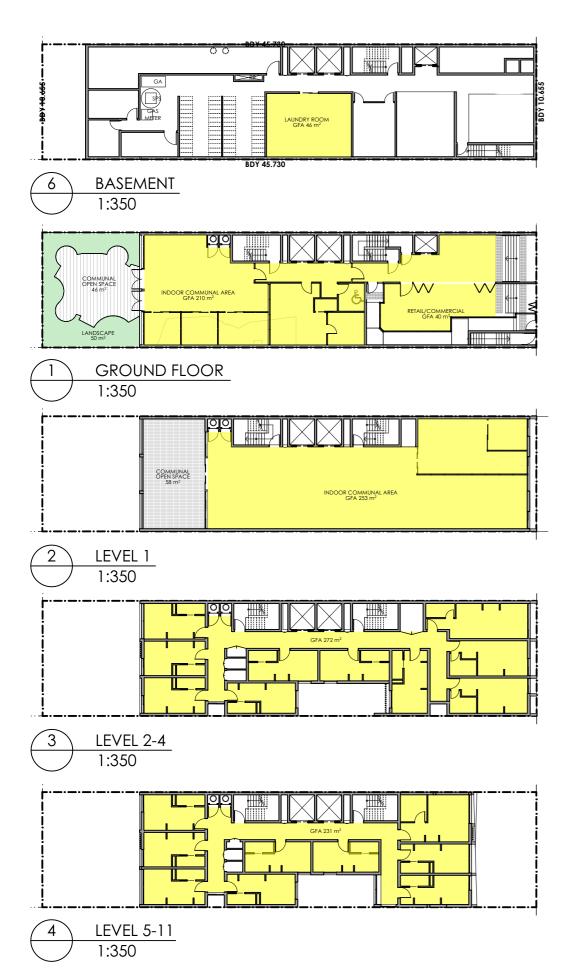

REV DESCRIPTION

A Development Applicat

NR 13/10/2022

RAPISARDA INVESTMENTS DEVELOPMENT APPLICATION

NEW STUDENT ACCOMMODATION AT 183 MACQUARIE STREET, PARRAMATTA

DRAWING TI

FSR AREA CALCULATION

DRAWN BY: NR/LZ
CHECKED BY: PI

SCALE: 1:350 AT A3
PROJECT No: P567

DA 15

5 no. 1

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ABN 90 050 071 022

ARCHITECTURE

Tourism + Residential

183 MACQUARIE STREET, PARRAMATTA
CITY OF PARRAMATTA COUNCIL

ZONING = B4 MIXED USE HEIGHT = 39.940m


FSR = 6:1

ALLOWABLE MAX. GFA = 2,982m² ALLOWABLE MAX. HEIGHT = 40m


ACCOMODATION SCHEDULI	<u> </u>		
NUMBER OF ROOMS	GF	0	
	LEVEL 1	0	
	LEVEL 2-4	30 (10 PER LEVEL)	
	LEVEL 5-11	63 (9 PER LEVEL)	
TOTAL NUMBER OF STUDENT	ROOMS	93	
COMMUNAL AREAS		3 (AT BASEMENT, GF AND LEVEL 1)	
ACCESSIBLE ROOMS		7 PROVIDED WITHIN THE 93	
MANAGER/RECEPTION AREA	1	1 (AT GF)	

AREA SCHEDULE			
RETAIL GFA		40 m²	
STUDENT ACCOMMODATION GFA L	EVEL 2-4	816 m² (272 m² EACH LEVEL)	
L	EVEL 5-11	1,617 m² (231m² EACH LEVEL)	
TOTAL STUDENT ACCOMMODATION G	FA	2,433.0 m²	
COMMUNAL INDOOR SPACE AREA		509 m²	
COMMUNAL OPEN SPACE AREA		104 m²	
LANDSCAPE AREA		50 m ²	

AREA SCHEDULE	
TOTAL PROPOSED GFA	2,982 m²
TOTAL PROPOSED FSR	6:1

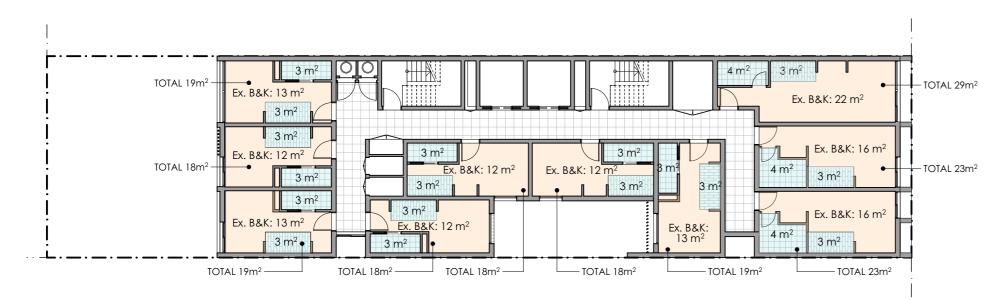

LEVEL 2-4 1:200

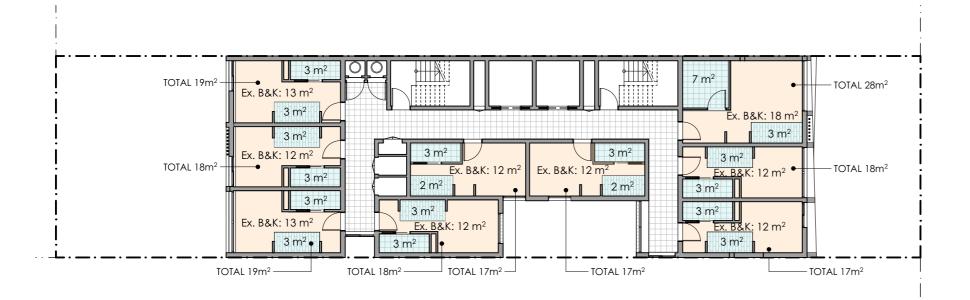

LEVEL 5-11 1:200

AMENITY AREA LEGEND

ROOM AREA (EXCL. KITCHEN & BATHROOM) AMENITYAREA

(KITCHEN / BATHROOM)

PRIVATE OPEN SPACE



REV DESCRIPTION

13/10/2022

RAPISARDA **INVESTMENTS**

DEVELOPMENT APPLICATION NEW STUDENT ACCOMMODATION AT 183 MACQUARIE STREET, PARRAMATTA

AMENITY AREA DIAGRAMS




NR/LZ CHECKED BY: PI

SCALE: 1:200 AT A3 PROJECT No: P567

DA

16

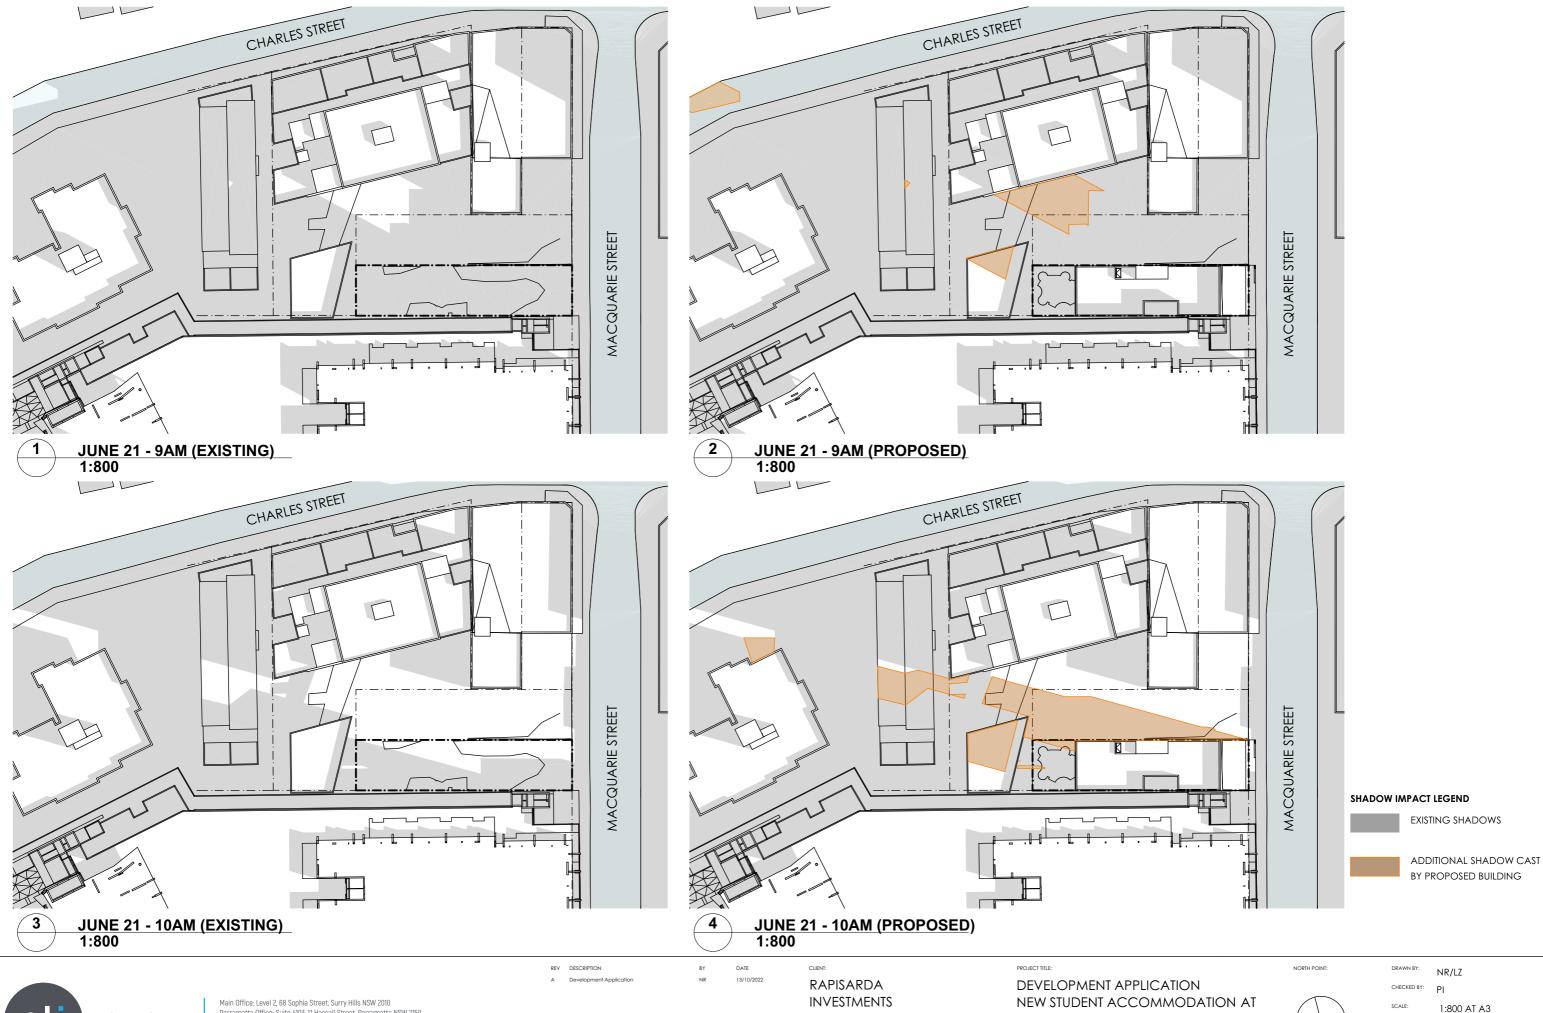


ARCHITECTURE

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183 MACQUARIE STREET, PARRAMATTA

SHADOW DIAGRAMS - SHEET 1

1:800 AT A3 PROJECT No:

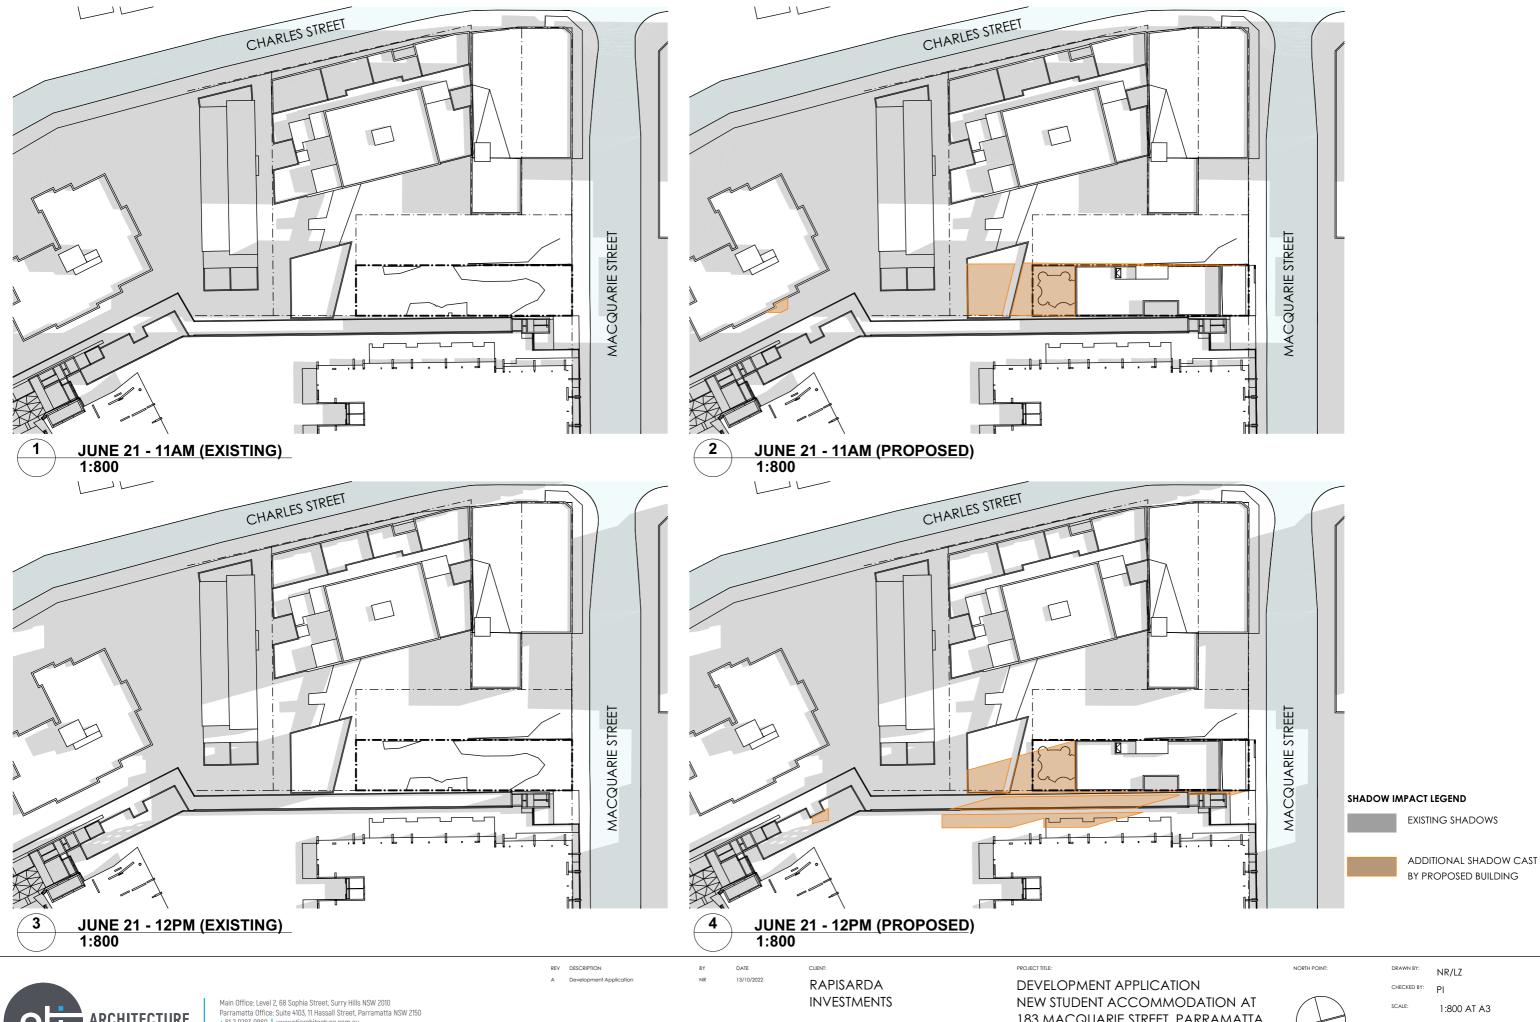


ARCHITECTURE

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183 MACQUARIE STREET, PARRAMATTA

SHADOW DIAGRAMS - SHEET 2



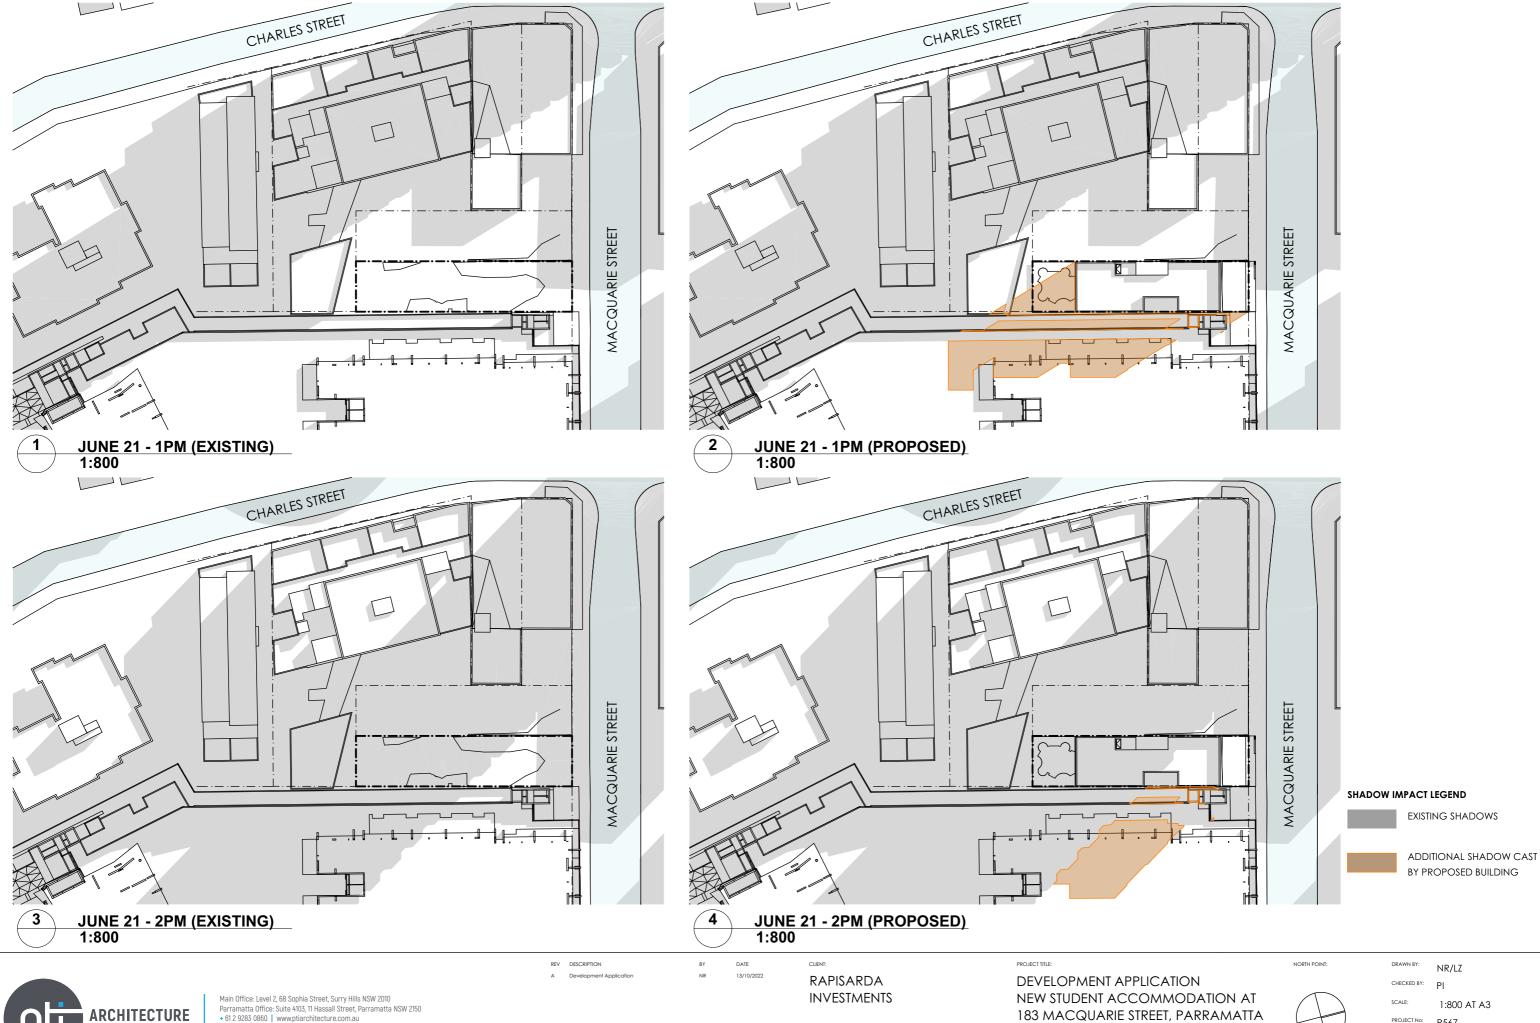



ARCHITECTURE

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SHADOW DIAGRAMS - SHEET 3





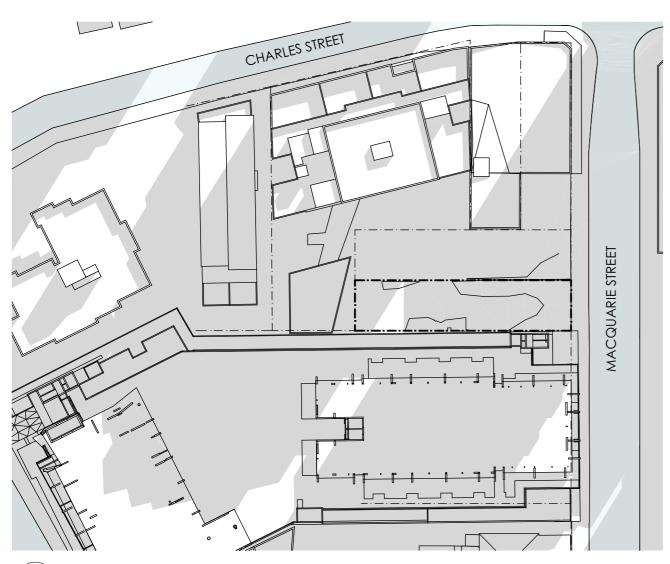

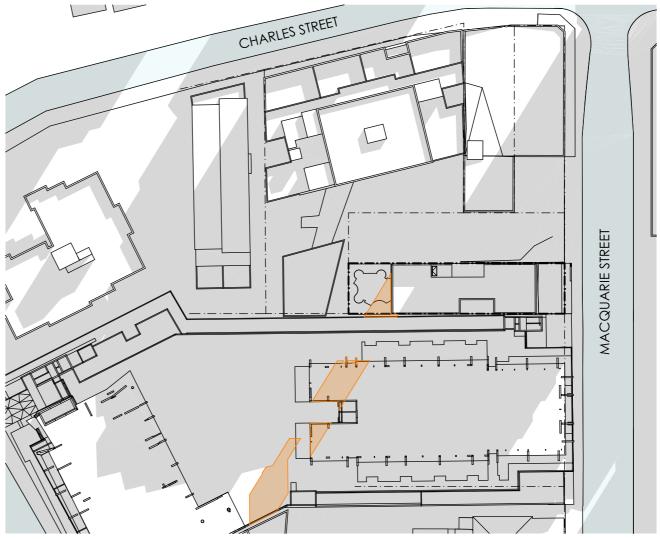JUNE 21 - 3PM (EXISTING) 1:800 **2** JUNE 21 - 3PM (PROPOSED) 1:800

SHADOW IMPACT LEGEND

EX

EXISTING SHADOWS

ADDITIONAL SHADOW CAST BY PROPOSED BUILDING



REV DESCRIPTION

A Development Application

DATE 13/10/2022

RAPISARDA INVESTMENTS DEVELOPMENT APPLICATION NEW STUDENT ACCOMMODATION AT 183 MACQUARIE STREET, PARRAMATTA

DRAWING 1

SHADOW DIAGRAMS - SHEET 4



DRAWN BY: NR/LZ
CHECKED BY: PI

SCALE: 1:800 AT A3


PROJECT No: P567

DA stage. 20 dwg no.


revi






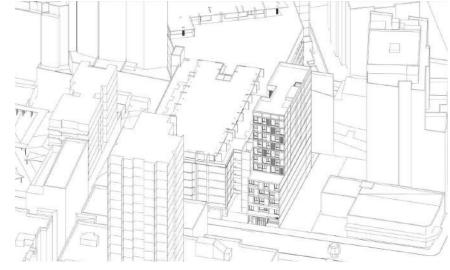

4 SOLAR ACCESS - 9AM 21 JUNE NTS

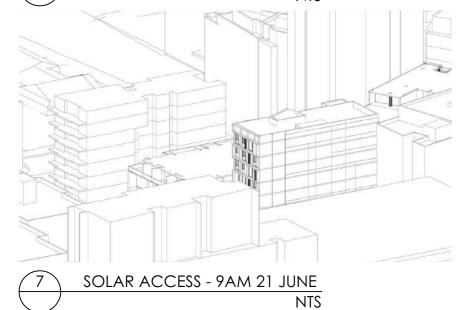


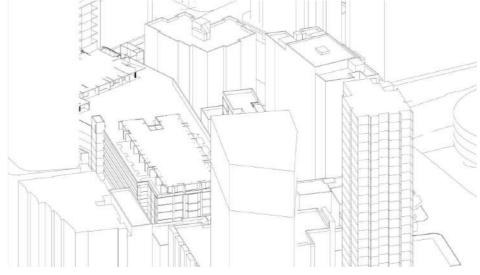

SOLAR ACCESS - 9AM 21 JUNE NTS



5 SOLAR ACCESS - 9AM 21 JUNE NTS

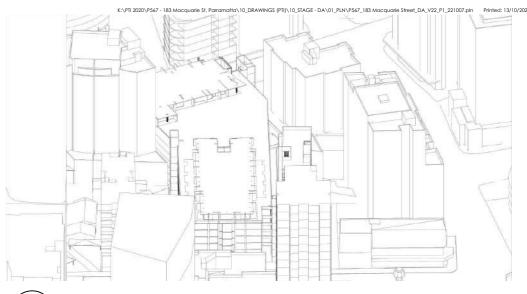

3 SOLAR ACCESS - 9AM 21 JUNE NTS



6 SOLAR ACCESS - 9AM 21 JUNE NTS



REV DESCRIPTION

A Development Application

BY DATE NR 13/10/2022

RAPISARDA INVESTMENTS DEVELOPMENT APPLICATION
NEW STUDENT ACCOMMODATION AT
183 MACQUARIE STREET, PARRAMATTA

DRAWING TITLE:

SOLAR STUDY DIAGRAMS



DRAWN BY: NR/LZ
CHECKED BY: PI


SCALE: AT A3


PROJECT No: P567

DA 21

. re

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Nominated Registered Architect: Peter Israel (reg no 5064)
ABN 90 050 071 022

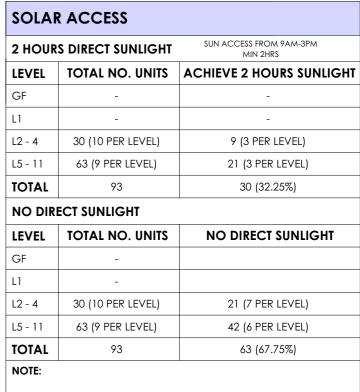

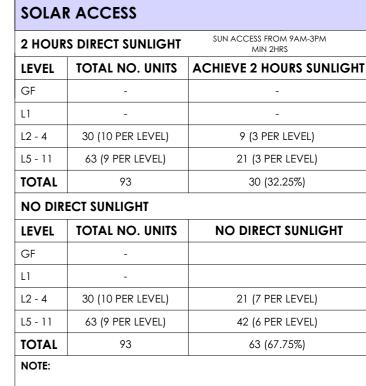


SOLAR ACCESS LEGEND


UNITS & PRIVATE OPEN SPACE RECEIVING 2 HRS SOLAR ACCESS

UNITS & PRIVATE OPEN SPACE RECEIVING NO DIRECT SUNLIGHT


SOLAR STUDY - LEVEL 2 - 4

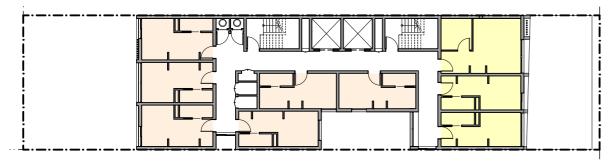

SOLAR STUDY - LEVEL 5 1:300

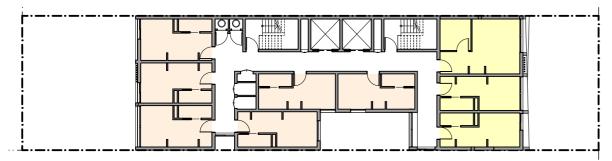

SOLAR STUDY - LEVEL 6 - 8

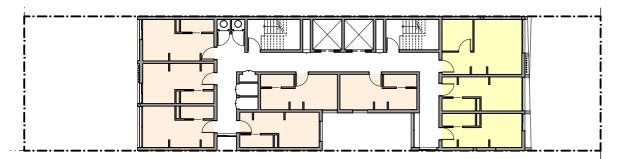

SOLAR STUDY - LEVEL 9 - 11 1:300

REV DESCRIPTION

13/10/2022


RAPISARDA **INVESTMENTS**

DEVELOPMENT APPLICATION NEW STUDENT ACCOMMODATION AT 183 MACQUARIE STREET, PARRAMATTA


SOLAR STUDY DIAGRAMS

NR/LZ CHECKED BY: SCALE:

1:300 AT A3 PROJECT No: P567

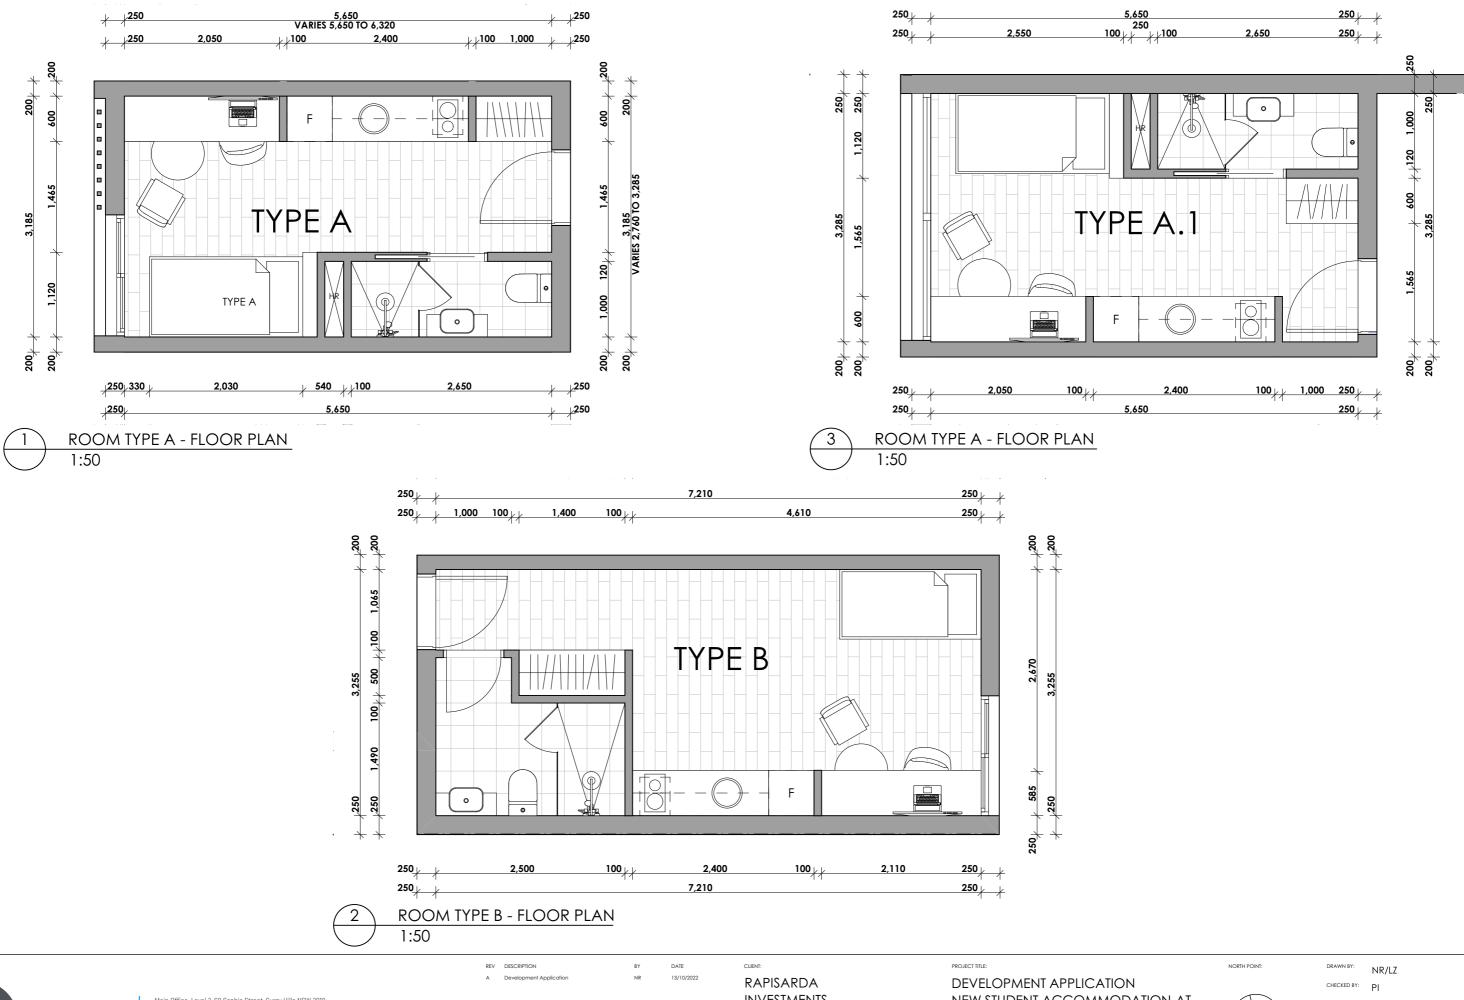

ROOM TYPE A, A.1 & B

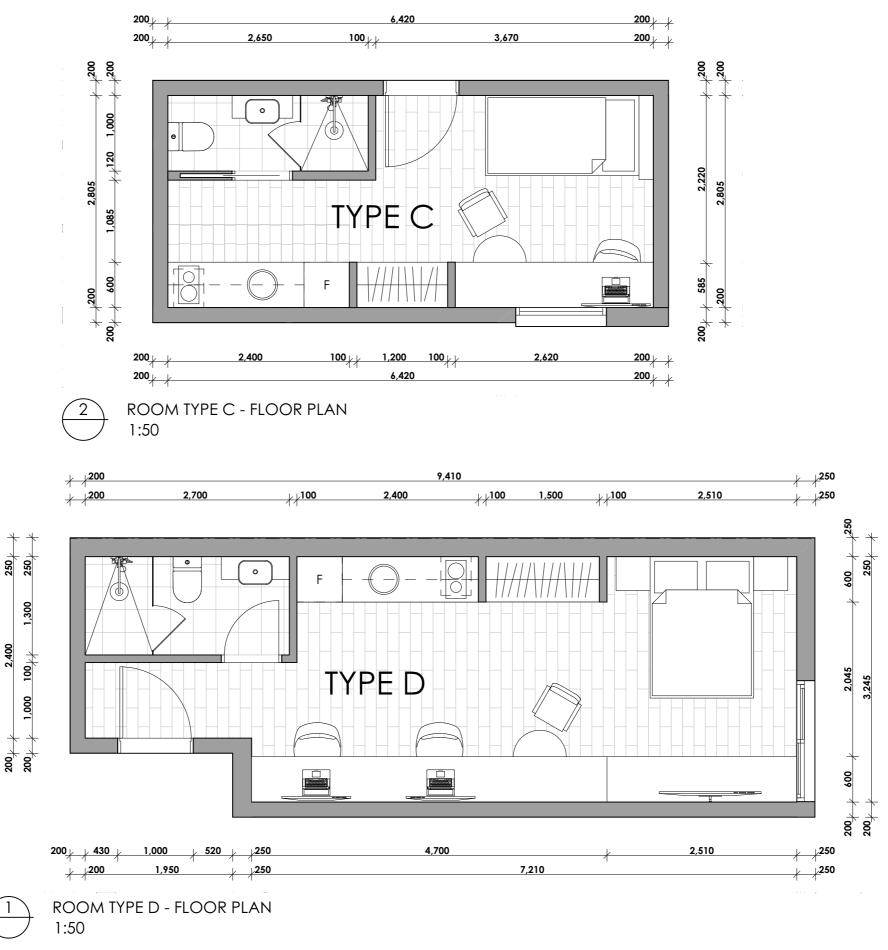

ARCHITECTURE Tourism + Residential

REV DESCRIPTION

13/10/2022


RAPISARDA **INVESTMENTS** **DEVELOPMENT APPLICATION** NEW STUDENT ACCOMMODATION AT 183 MACQUARIE STREET, PARRAMATTA


ROOM TYPE C & D



NR/LZ DRAWN BY: CHECKED BY: PI

SCALE: 1:50 AT A3 PROJECT No: P567

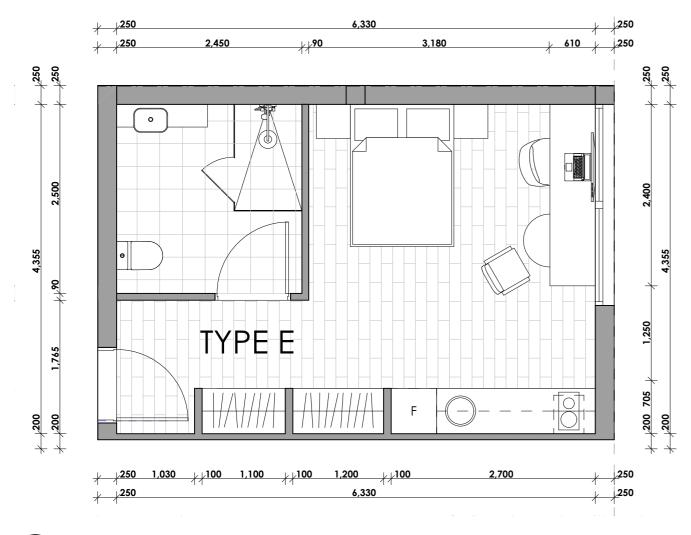

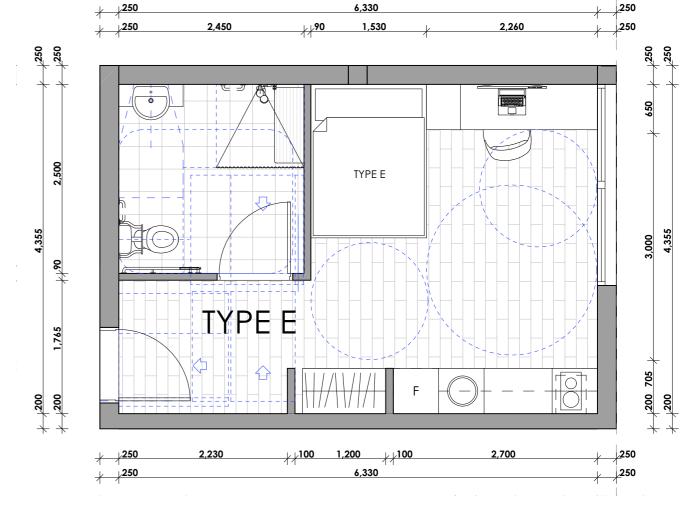

PRE-ADAPTABLE ROOM - FLOOR PLAN
1:50

1 ADAPTABLE ROOM - FLOOR PLAN 1:50







REV DESCRIPTION

A Development Application

DAT

RAPISARDA INVESTMENTS PROJECT TITLE

DEVELOPMENT APPLICATION
NEW STUDENT ACCOMMODATION AT
183 MACQUARIE STREET, PARRAMATTA

DRAWING TIT

3D VIEW



IT:

DRAWN BY: NR/LZ


CHECKED BY: PI
SCALE: 1:0.77 AT A3

DA stage.

26 dwg no.

revi

MGA

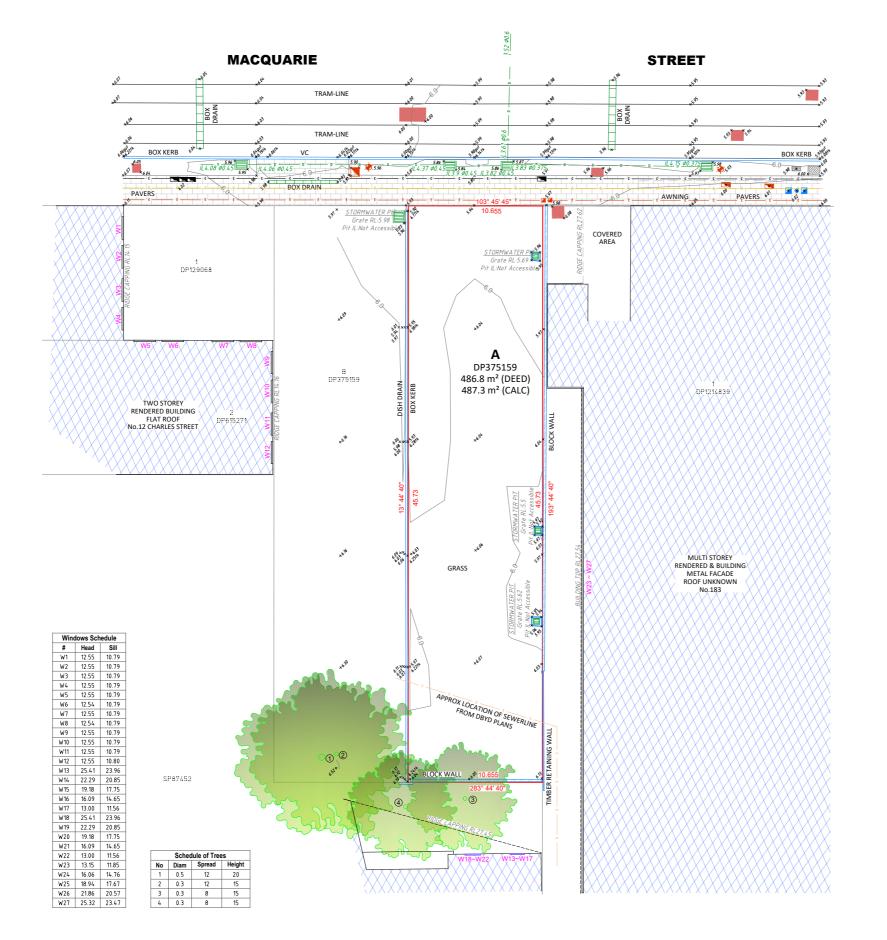

UNDERGROUND SERVICES LEGEND QUALITY LEVEL D (AS 5488.1:2019) — D — STORMWATER PIPE S SEWER MAIN

C COMMUNICATIONS CABLES

E ELECTRICITY CABLES GAS MAIN CAUTION: FIBRE OPTIC CABLES ARE PRESENT IN THIS AREA

APPROXIMATE POSITION ONLY VIDE 'DIAL-BEFORE-YOU-DIG' PLANS JOB NO

31998984 SEARCH DATE 24/05/2022. WHERE CRITICAL TO DESIGN, UNDERGROUND SERVICES SHOULD BE LOCATED BY MORE ACCURATE

SERVICES NOTES:-

- ONLY THOSE SERVICES VISIBLE AT THE TIME OF SURVEY HAVE BEEN LOCATED AND IF SHOWN AS 14 80 67" ARE QUALITY LEVEL A AS DEFINED BY AS 5488.1:2019. LEVELS SHOWN ARE SURFACE LEVELS UNLESS NOTED OTHERWISE.
- UNDERGROUND SERVICES HAVE BEEN PLOTTED FROM TOIAL BEFORE YOU -DIG 'PLANS, ARE QUALITY LEVEL D AS DEFINED BY AS 5488 1.2019 AND ARE ONLY CURRENT FOR S MONTHS FROM THE SEARCH DATE NOTED ABOVE ALL RELEVANT AUTHORITIES MUST BE CONTRACTED TO DETERMINE THE FULL EXTENT OF SERVICES PRIOR TO ANY PLANNING OR WORKS NEAR THE SITE.

ONLY TREES GREATER THAN 3.5 METRES IN HEIGHT ARE SHOWN ON THIS PLAN AND THEIR POSITIONS ARE DIAGRAMMATIC ONLY AND MAY REQUIRE ADDITIONAL SURVEY WHERE CRITICAL TO DESIGN.

CONTOURS ARE INDICATIVE AT GROUND FORM ONLY. SPOT LEVELS ONLY SHOULD BE USED FOR CALCULATIONS OF QUANTITIES WITH CAUTION.

LEVELS ARE ON AUSTRALIAN HEIGHT DATUM (AHD).

ALL SETOUT LEVELS MUST BE REFERRED TO THE BENCH MARK SHOWN ON THIS PLAN.

BOUNDARY NOTES

A BASIC BOUNDARY SURVEY HAS BEEN DONE SUITABLE FOR DA LODGEMENT PURPOSES.

BOUNDARIES HAVE NOT BEEN MARKED

SURVEY INFORMATION NOTES

THE ORIGIN OF COORDINATES COMES FROM SSM47063 E315719.154 N625648.005 CLASS B POSITIONAL UNCERTAINTY (PU) N/A (MGA2020) ADOPTED FROM SCIMS DATED 31/05/2022.

THE ORIGIN OF LEVELS COMES FROM SSM47063 RL5.859 CLASS LB POSITIONAL UNCERTAINTY (PU) N/A ADOPTED FROM SCIMS DATED 31/05/2022.

THE ORIENTATION OF THIS PLAN IS MGA NORTH WHICH HAS BEEN DETERMINED BY DP1214839.

CERTIFICATE OF TITLE NOTES

THE FOLLOWING INFORMATION RELATES TO THE RESPECTIVE CERTIFICATE OF TITLE OF EACH LOTS:

- LOT A IN DP375159 (CT EDITION 1 DATED 07/12/2015 SEARCH DATE 21/06/2022) -THERE ARE NO NOTATIONS ON THE CERTIFICATE OF TITLE

COVENANTS AND RESTRICTIONS NOTED ON THE TITLE HAVE NOT BEEN INVESTIGATED. THESE SHOULD BE INVESTIGATED PRIOR TO DESIGN TO ENSURE ANY FUTURE DEVELOPMENT COMPLIES.

ONLY THOSE SERVICES VISIBLE AT THE TIME OF SURVEY HAVE BEEN LOCATED AND ARE QUALITY LEVEL A AS DEFINED BY AS 5488.1:2019.

UNDERGROUND SERVICES HAVE BEEN PLOTTED FROM
'DIAL-BEFORE'YOU-DIG' PLANS, ARE QUALITY LEVEL D AS DEFINED BY AS
5488.1:2019 AND ARE ONLY CURRENT AT THE DATE OF SEARCH.

LEGEND

COMMUNICATIONS PIT

ELECTRICITY PILLAR

ELECTRICITY PIT

HIGHT POLE

STOP VALVE

TRAFFIC SIGNAL PIT

UNCLASSIFIED SERVICE

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DETAIL AND LEVEL SURVEY OF LOT A IN DP375159

183 MACQUARIE STREET PARRAMATTA

CLIENT: PTI ARCHITECTURE PTY LTD

FILE: 8748 183 MACQUARIE STREET PARRAMATTA REV A

LGA: PARRAMATTA	
REF: 8748	CONTOURS: 0.5m
ISSUE: A	DATUM: AHD
SURVEY DATE: 30/05/2022	AZIMUTH: MGA2020
SCALE: 1:150	SHEET 1 OF 1 SHEETS



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Student Accommodation

183 Macquarie Street, Parramatta NSW

DWG NO.	DRAWING TITLE	SCALE
000	LANDSCAPE COVER SHEET	
C101	LANDSCAPE COLOR PLAN	1:75
101 102	LANDSCAPE PLAN - GROUND FLOOR INDICATIVE MATERIALS & DESIGN CHARACTER	1:75 1:75
201	LANDSCAPE PLANTING PLAN - GROUND FLOOR	1:75
501 502	LANDSCAPE SPECIFICATION / INDICATIVE PLANT SCHEDULE LANDSCAPE DETAILS	AS SHOWN AS SHOWN

NOT FOR CONSTRUCTION

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The contractor shall check and verify all work on site (including work by others) before commencing the landscape installation. Any discrepancies are to be reported to the Project Manager or Landscape Architect prior to commencing work. Do not scale this drawing. Any required dimensions not shown shall be referred to the Landscape Architect for confirmation.

B Preliminary A Preliminary Issue Revision Description

MJW RS 11.10.22 BS RS 16.09.22 Drawn Check Date

LEGEND





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SITE IMAGE Client: RAPISARDA INVESTMENTS

183 Macquarie Street

Parramatta NSW


Landscape Cover Sheet

PRELIMINARY Student Accommodation

Scale: Job Number:

SS22-5030

000 B

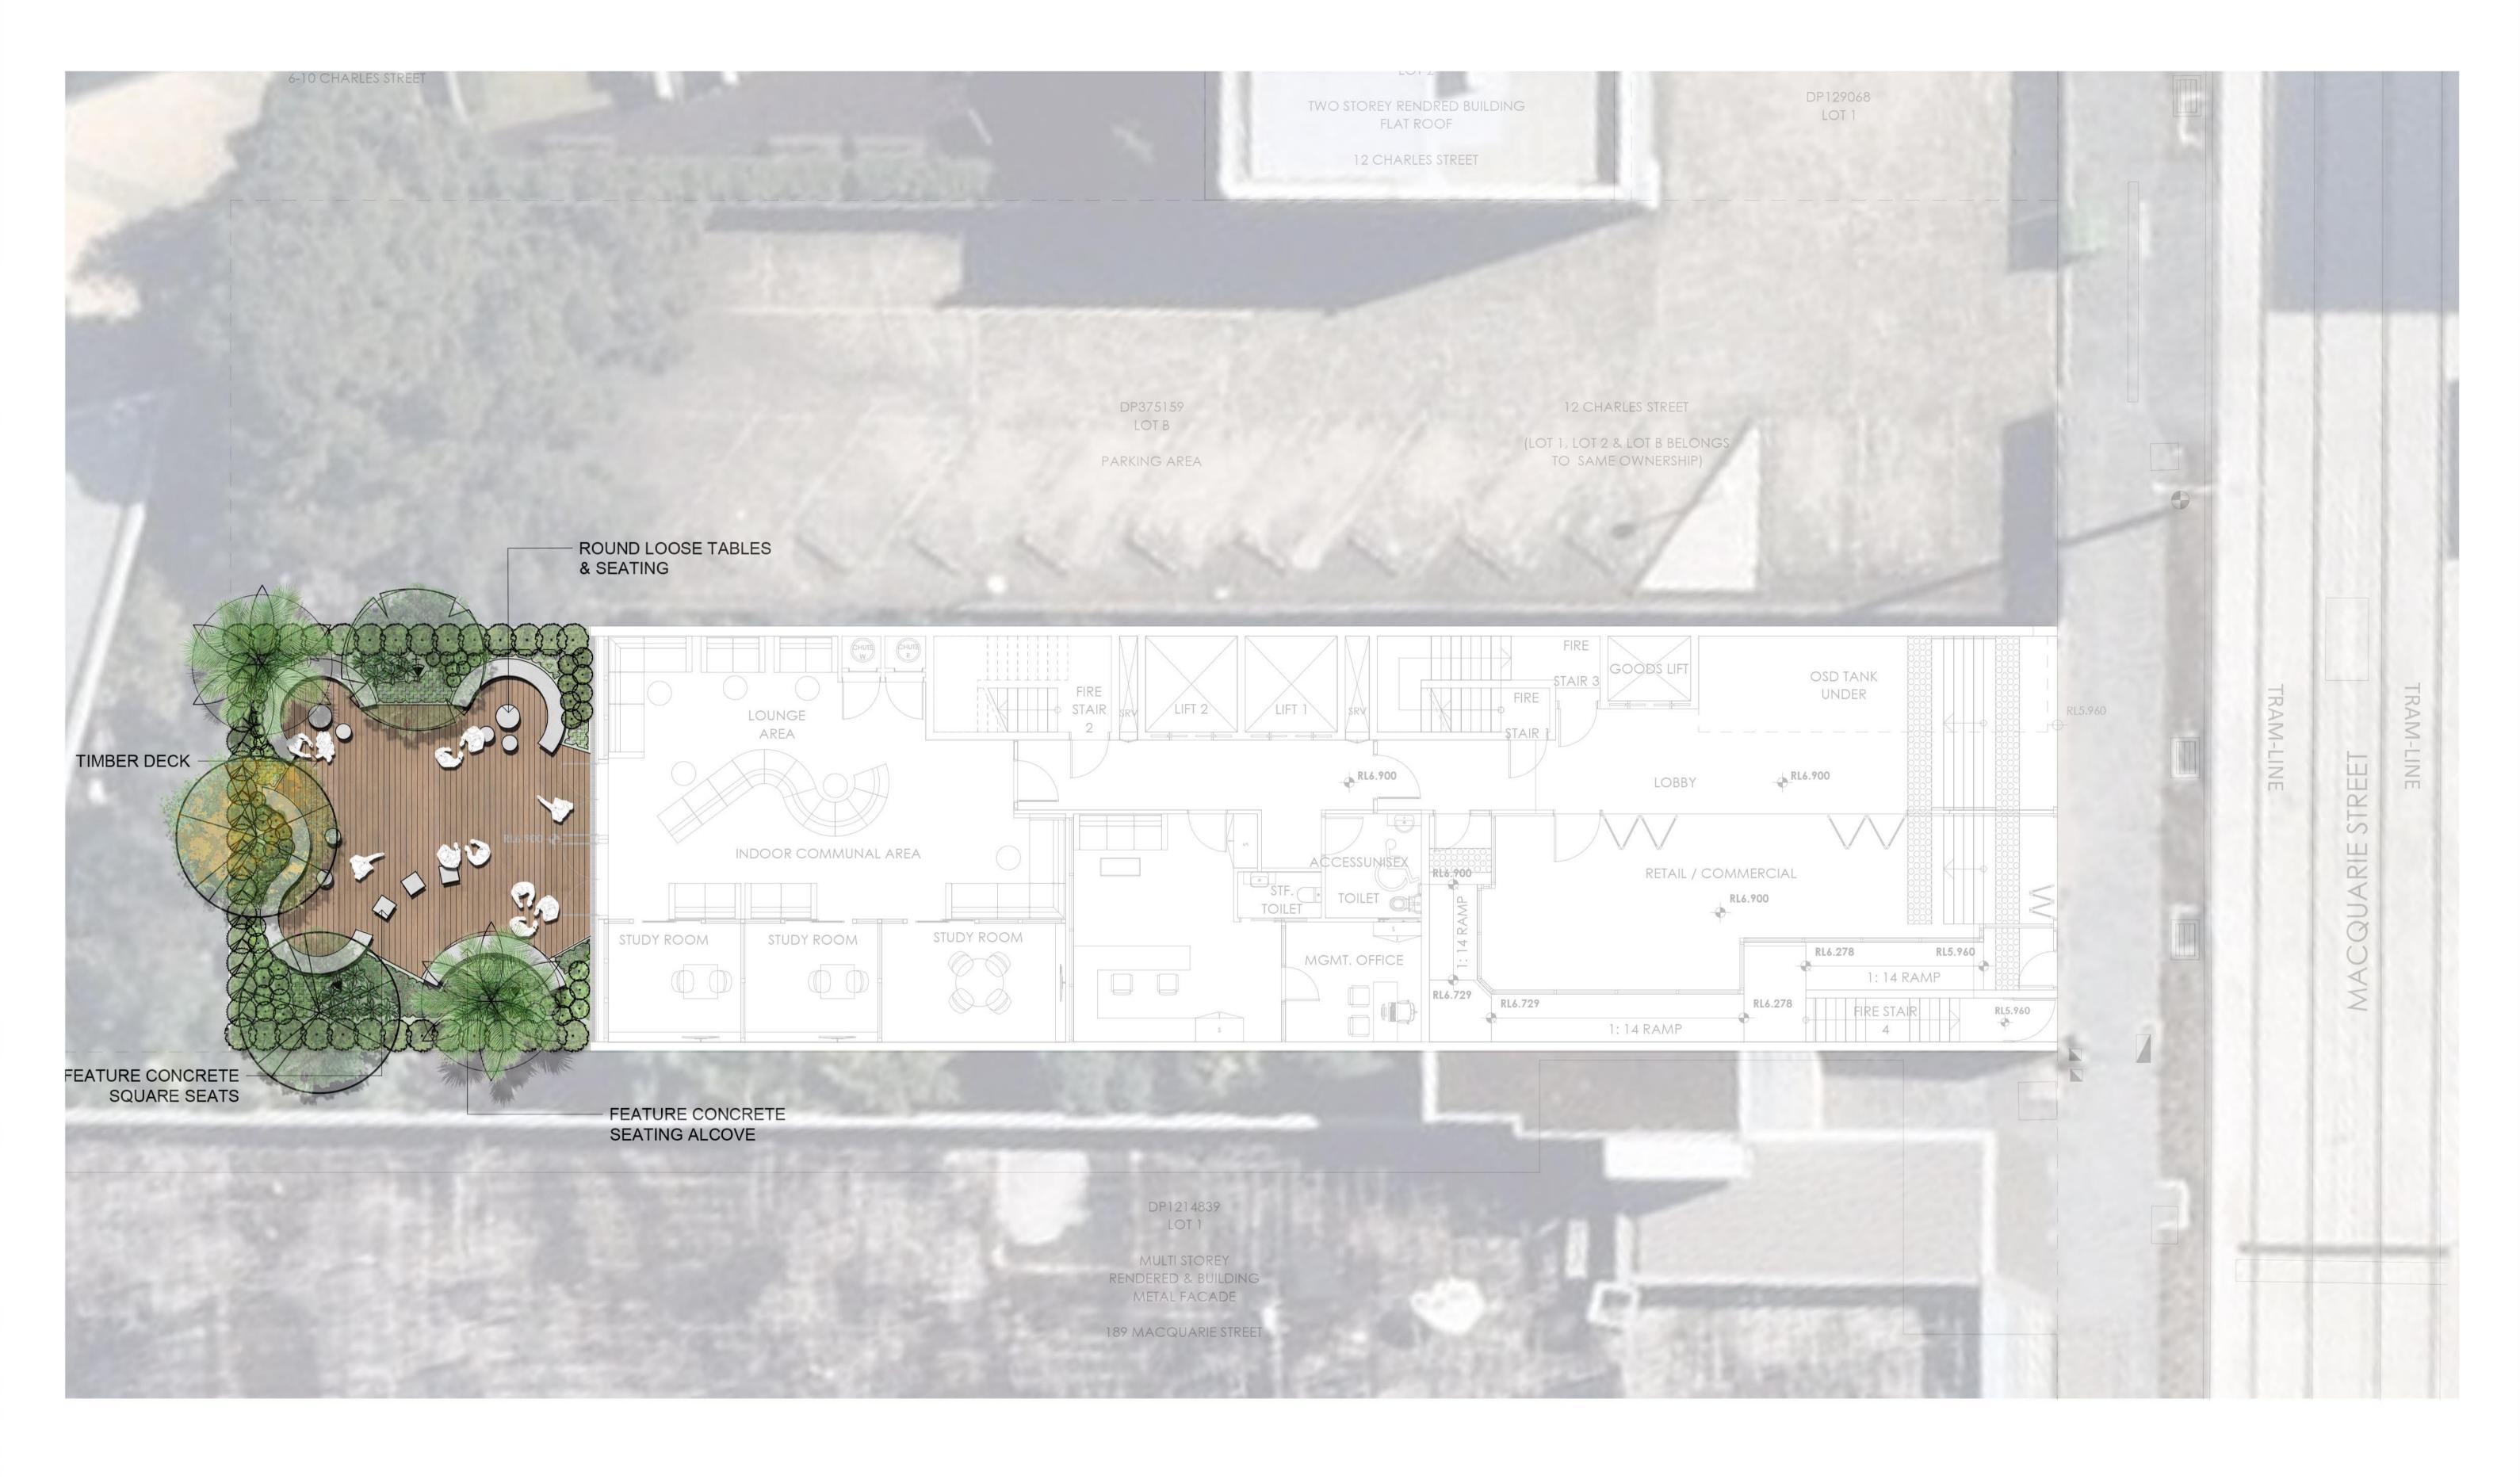

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B Preliminary A Preliminary Issue Revision Description


LEGEND

MJW RS 11.10.22

BS RS 16.09.22


Drawn Check Date

Proposed groundcover planting

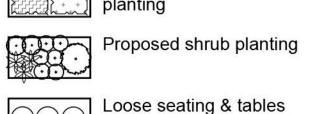


Proposed trees Timber decking

Concrete seating alcove

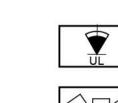

Tree up lighting

Feature square

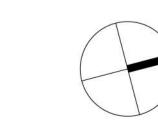

RAPISARDA INVESTMENTS

Landscape Architects Level 1, 3-5 Baptist Street Redfern NSW 2016


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Student Accommodation 183 Macquarie Street Parramatta NSW

Landscape Colour Plan **Ground Floor**

PRELIMINARY Scale: 1:75 @ A1 Job Number: SS22-5030 C101 B



Drawn Check Date

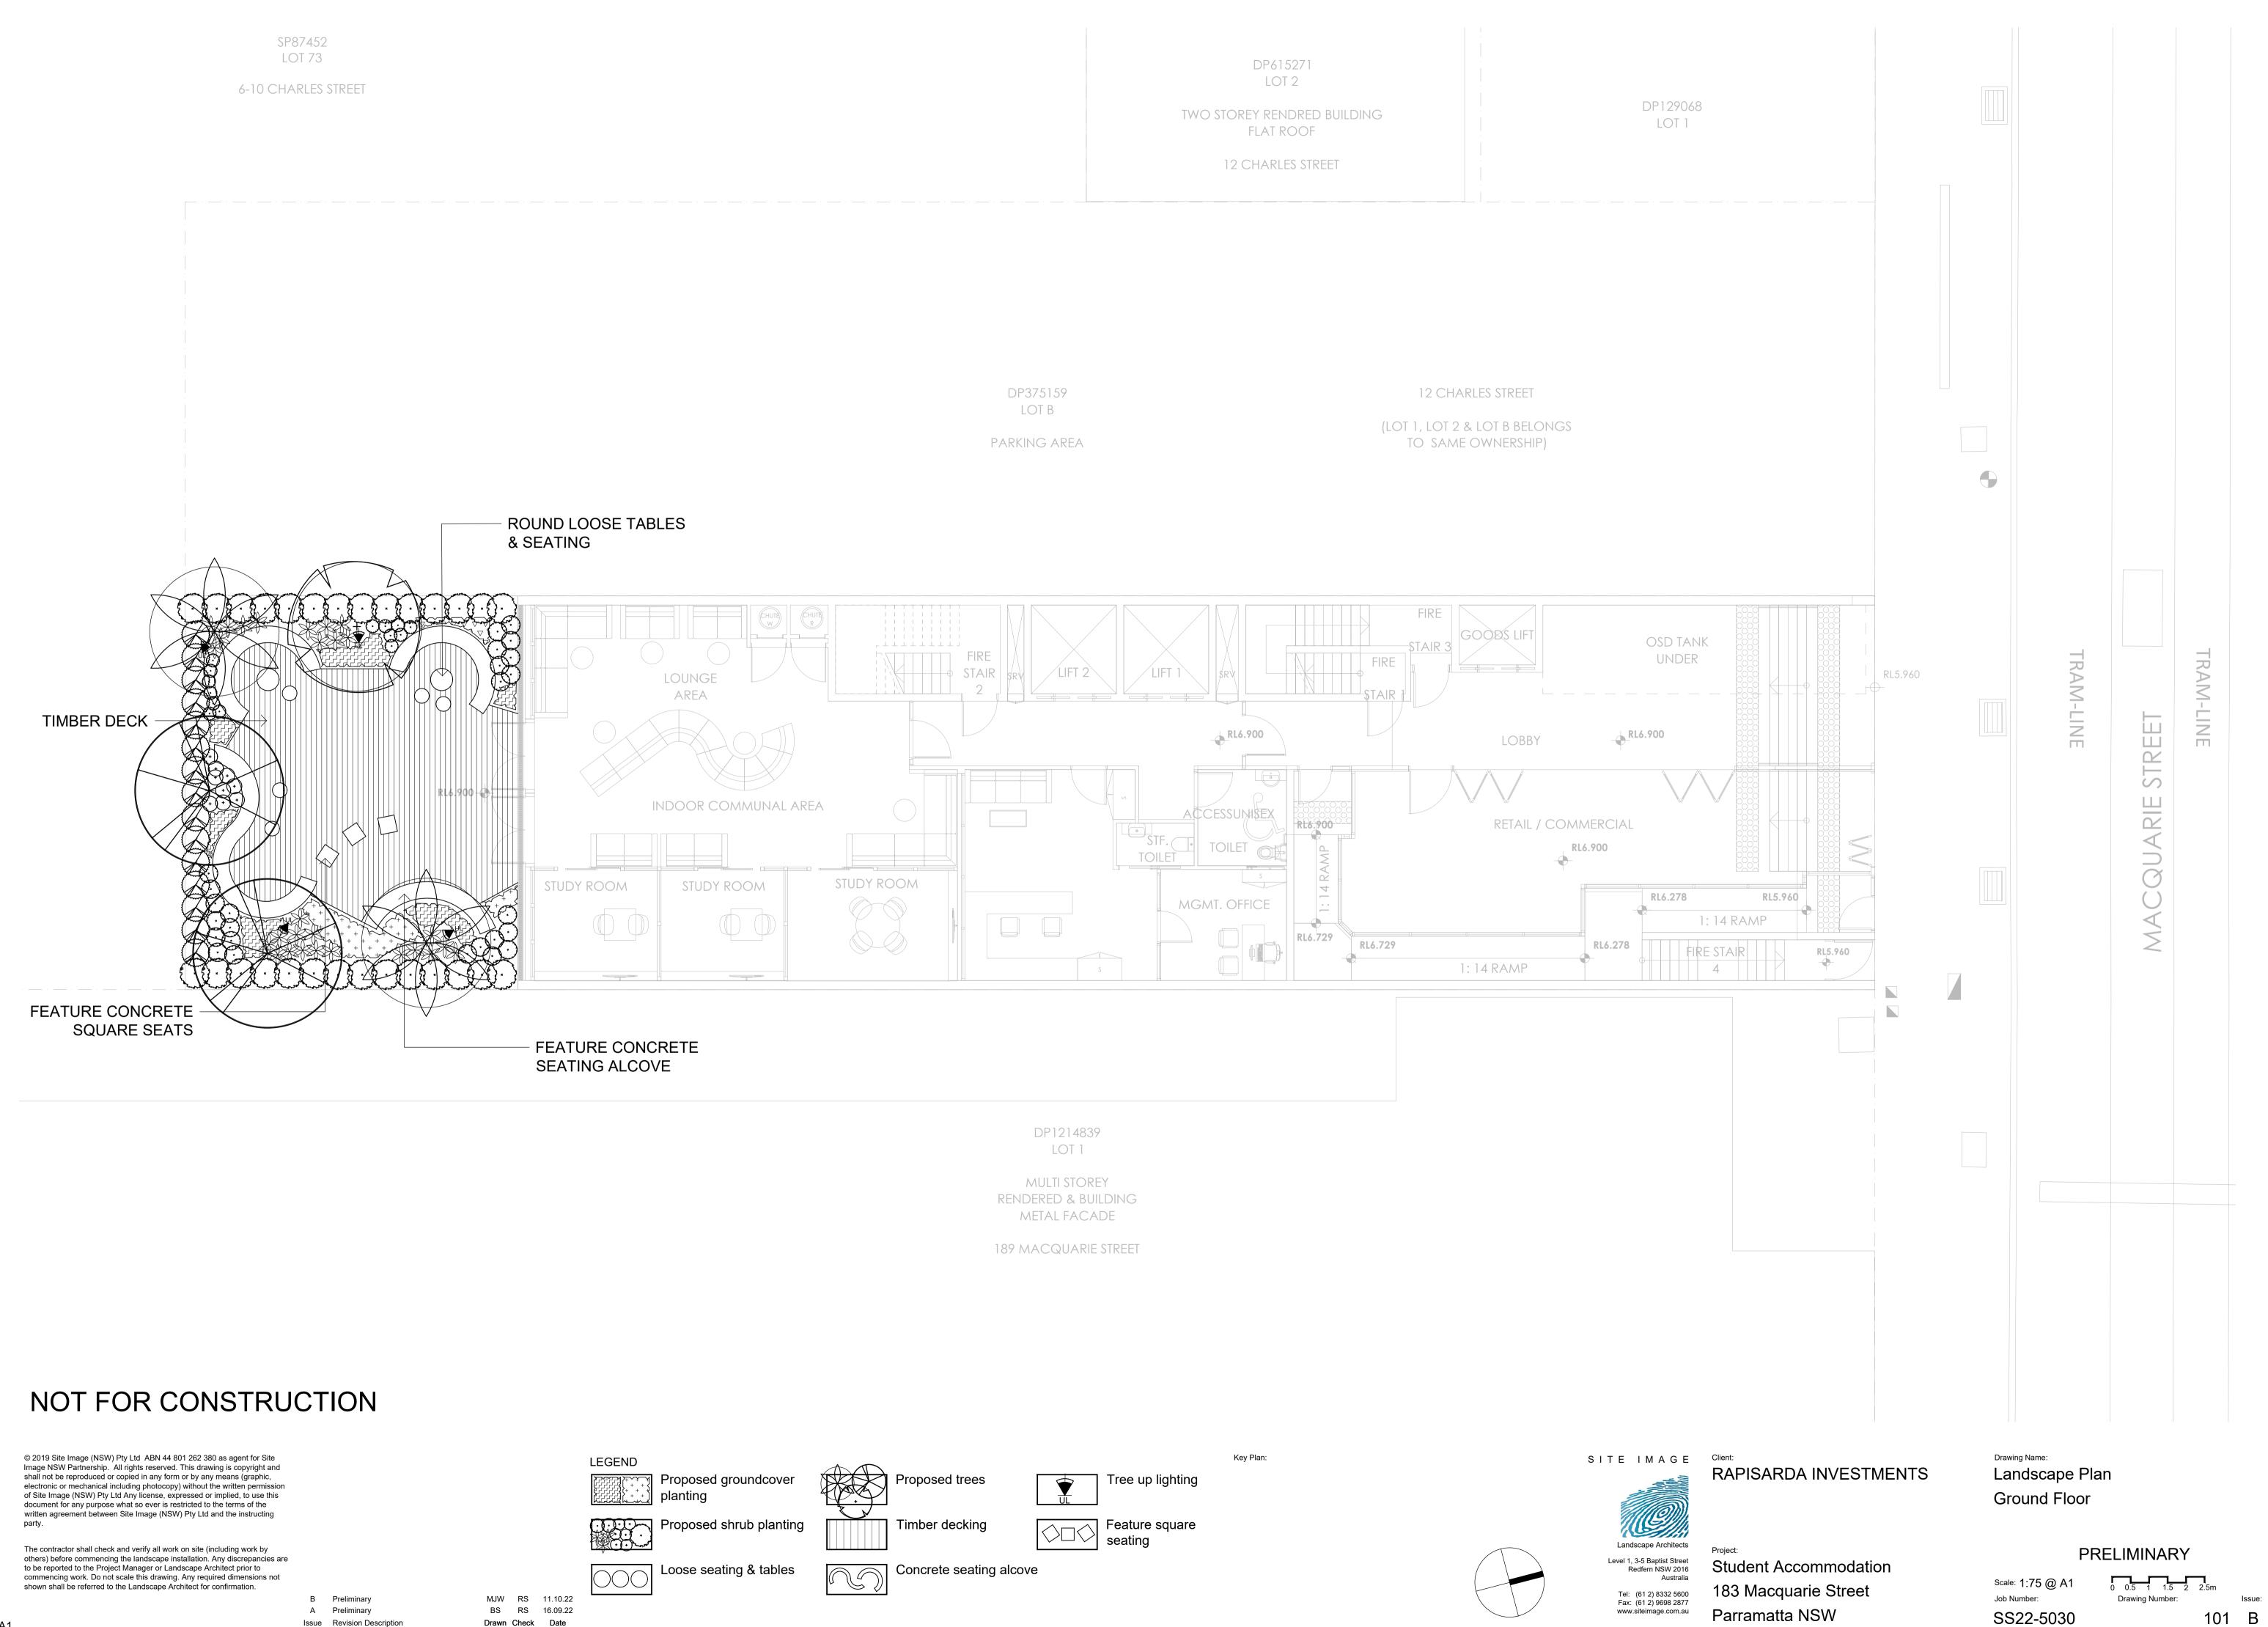Issue Revision Description

Precast concrete cylinder seating extend the informal seating nodes. Draffin 'Wandin' range concrete bases are segmented bases and timber tops that can form the range of curved forms as shown. LED strip lighting along the base



Lush 'tropical' planting of bamboo, tree ferns and small canopy trees will provide a sense of enclosure, with feature understorey planting providing a green setting for seating. Uplighting to planting will create a pleasant outdoor night area for gathering.

Landscape Design Imagery























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Loose seating & tables



Concrete seating alcove






RAPISARDA INVESTMENTS

183 Macquarie Street Parramatta NSW

Landscape Plan Ground Floor- Indicative materials & Design Character

PRELIMINARY

Scale: 1:50 @ A1 SS22-5030 102 B

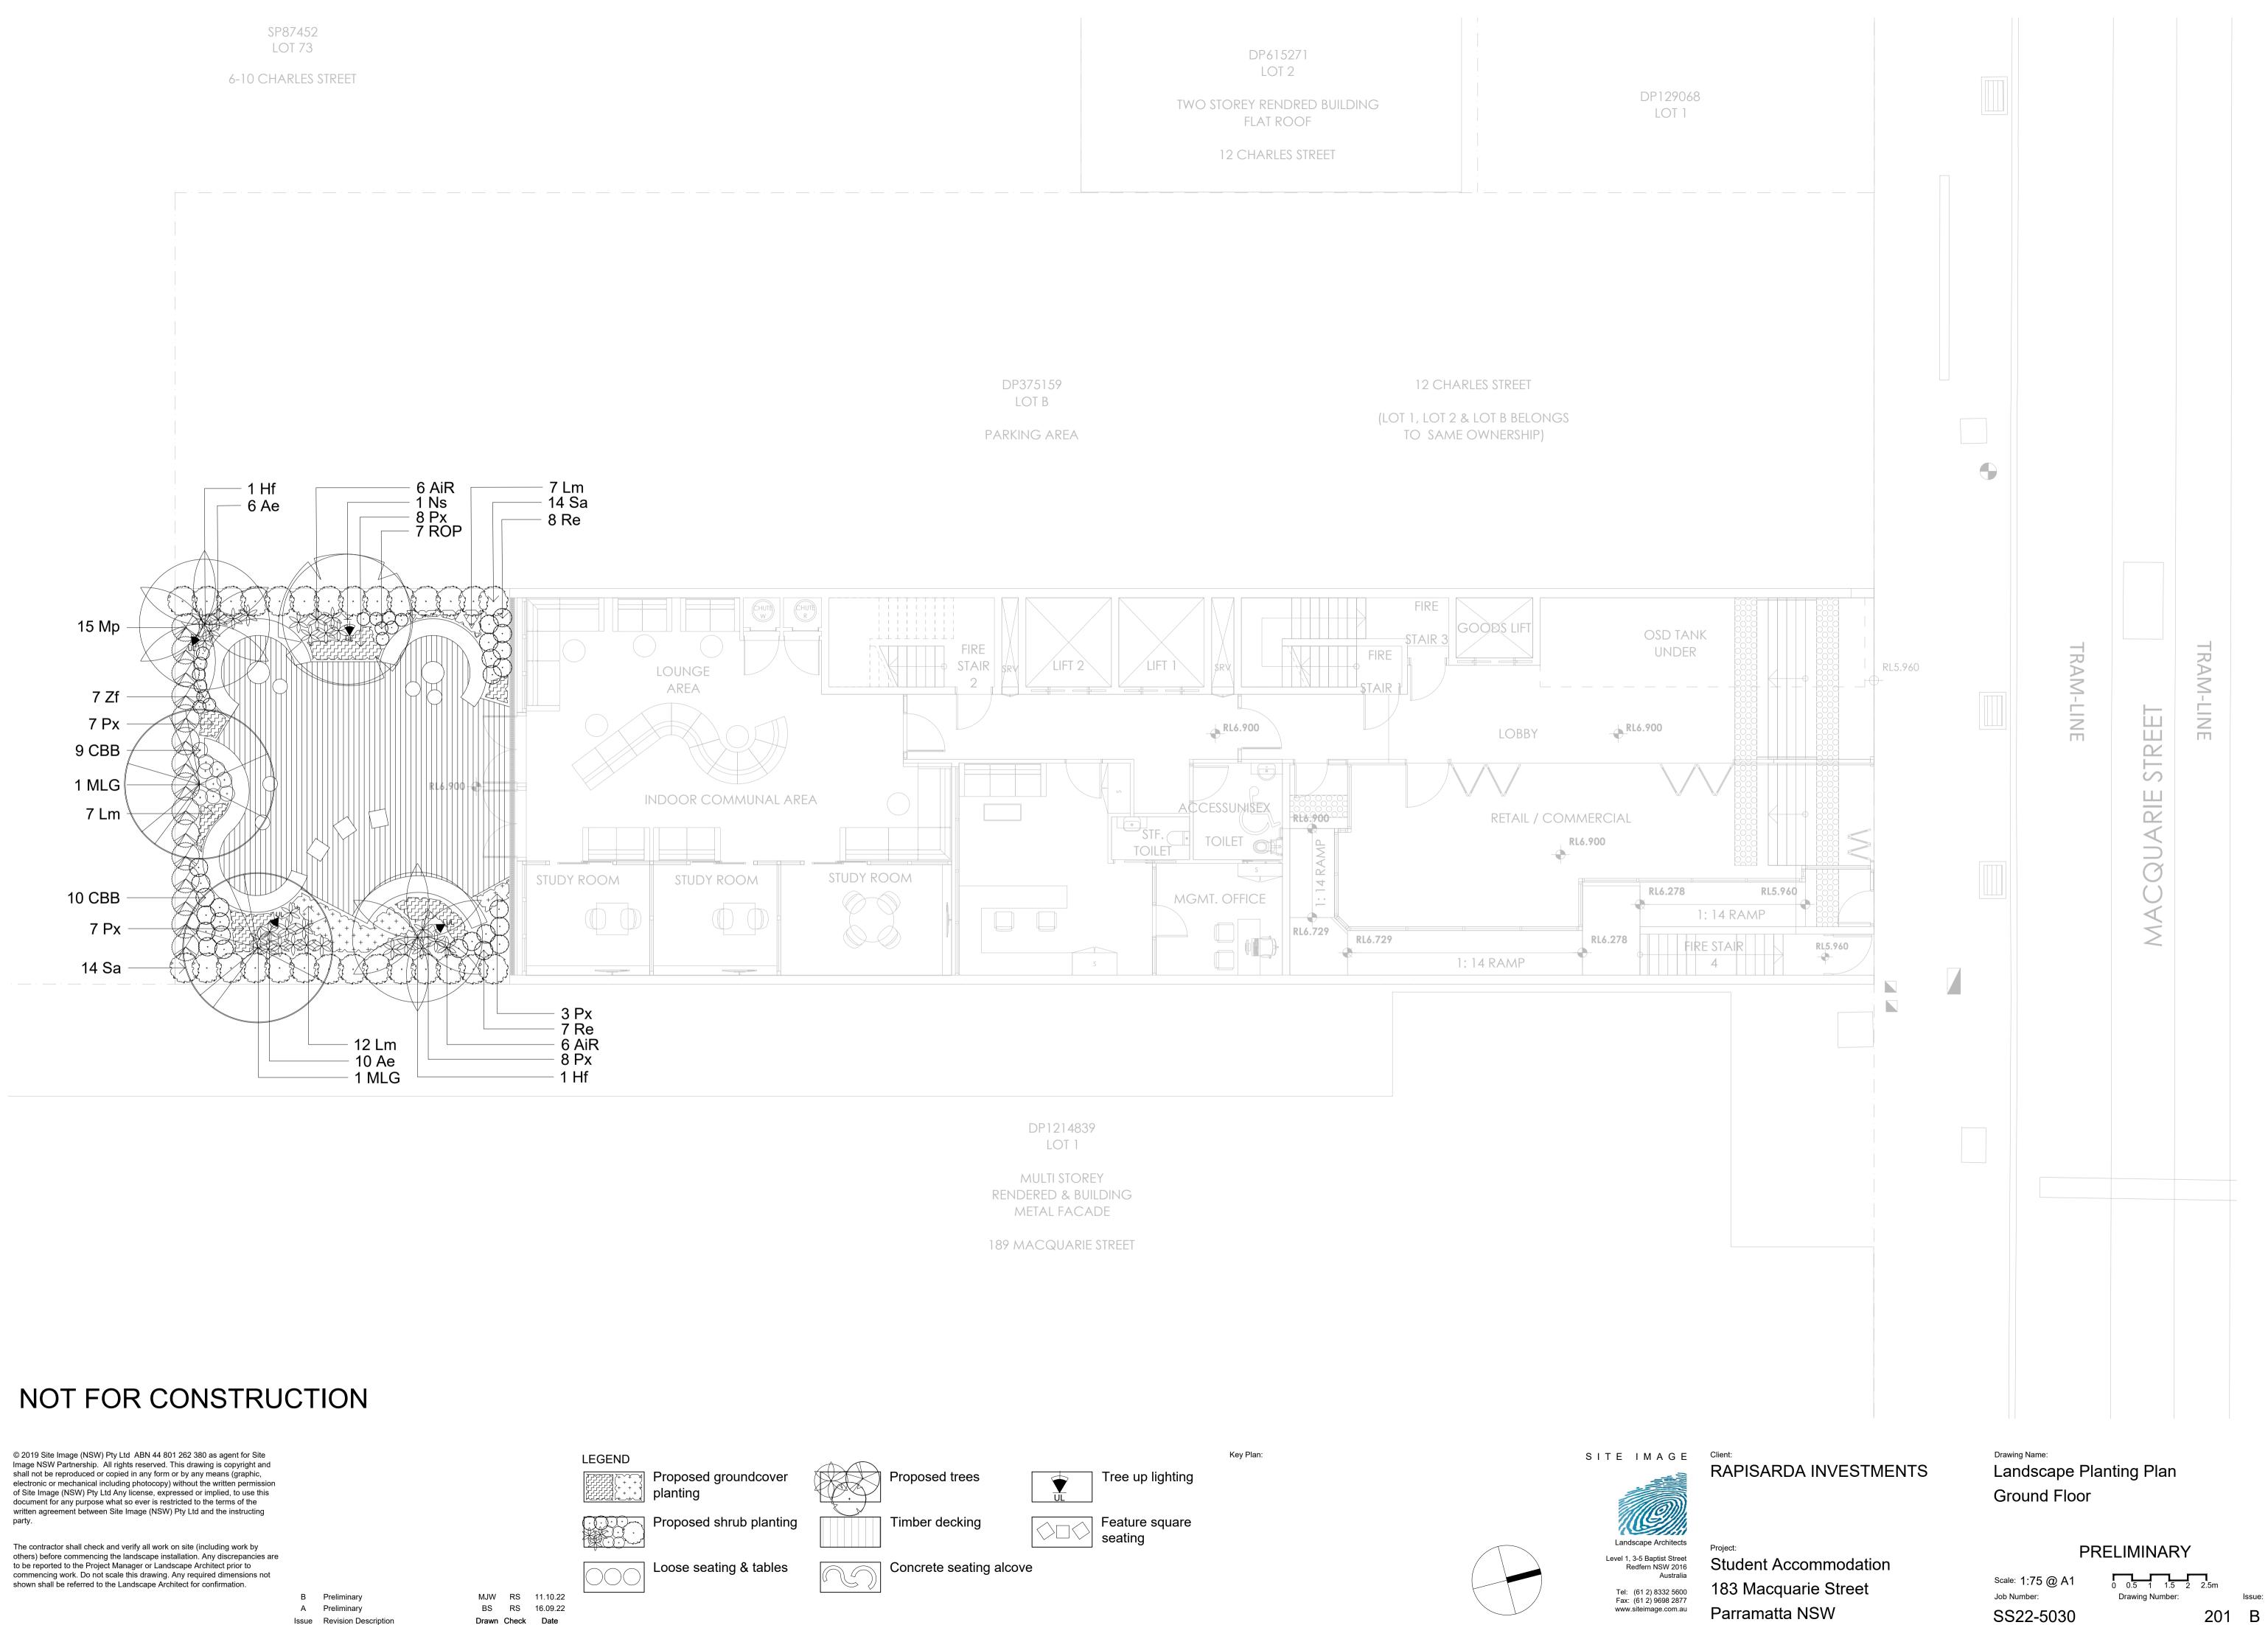

Drawn Check Date

Issue Revision Description

LANDSCAPE SPECIFICATIONS

GENERAL NOTES

All plans and details included in the project documents shall be read in conjunction with this specification. All structural and civil works components of the landscape design shall be referenced to engineers' details and specifications. Read this specification in conjunction with the plant and materials schedules on the drawings. If in doubt about any detail or if conflicts are found in the documents, seek advice.

Workmanship and Materials

The whole of the landscape works shall be carried out by a competent, trained and qualified landscape contractor who is experienced in horticultural practices, landscape construction and planting techniques. The landscape contractor shall hold a current Building Contractors License and/or be a financial member of LNA Landscape Association NSW & ACT or equivalent organisations in other states.

EXISTING TREES AND SHRUBS

Trees and Shrubs to be Retained and Protected

Identify and mark trees and shrubs to be retained using a suitable non-injurious, easily visible and removable means of identification. Protect from damage the trees and shrubs to be retained, including those beyond the site area, both above and below the ground. If a tree becomes damaged during the works or it is proposed to perform work on a tree, give written notice immediately and obtain instructions.

Work Near Trees and Shrubs

Keep the area of the drip-line free from construction material and debris. Do not place bulk materials and harmful materials under foliage canopies or near trees. Do not place spoil from excavations against tree trunks. Prevent wind-blown building materials, such as cement, from covering trees and other plants. Do not remove topsoil from, or add topsoil to, the area within the drip-line of trees.

EARTHWORKS

Excavation, Trimming and Filling

Except as otherwise noted in the contract, bulk excavation is excluded from the landscape works. After the completion of bulk excavation by others, trim and fill the excavated ground surfaces to achieve design levels to accommodate finish materials as detailed. Prepare the sub-grade surface as required for the various finished ground treatments.

Sub-soil Drainage

Keep the excavated works drained and free of standing water. Allow to supply and install sub-soil drainage pipes as required for the new works to ensure that all gardens are well drained. Connect the sub-soil drainage pipes to the nearest downstream stormwater pits. Include pipe filter socks and course sharp aggregate backfilling of trenches

HARDWORKS

Furniture, Handrails, Balustrades

Supply and install the scheduled items in accordance with the manufacturer's recommendations, as detailed and in the locations shown on plan. Provide all footings and fixings required for the items to be stable and in accordance with applicable codes and standards.

Garden Walls, Fences, Edging

Construct garden walls, fences, and edging as shown on plan, as detailed and of the material scheduled. Refer to engineer's details for structural retaining walls, concrete stairs, concrete strength, reinforcing and joint placement.

Continuous, Unit and Loose Pavement

Install the scheduled material pavement to the locations shown on plan. Ensure that all subgrade/subsurface works are complete prior to commencing paving. Confer with the engineer to ensure the structural integrity of the subgrade. Ensure that the base course under paved surfaces is a continuous plane offering a constant depth of bedding material not exceeding 50mm. If laying unit pavers in a cement mortar bed on a concrete sub-base ensure that joints in paving match the location of joints in the concrete. Refer to engineer's details for heavy duty slabs, concrete stairs, concrete strength, reinforcing, and joint type and placement.

SOFTWORKS

Site Soil Testing

Where site soil is to be retrieved from site and stored on site for reuse, undertake at least two (2) soil tests in locations as advised by the Project Manager or as shown on the plans. Provide results and recommendations regarding soil additives for the benefit of healthy plant growth and to adjust the soil components to achieve an appropriate planting medium for successful plant development.

Excavate and/or fill all garden beds to bring the top of subsoil to at least 300mm below finished design soil levels. Excavate all turf areas to bring the subsoil to at least 100mm below finished design levels. In all areas shape the subsoil to fall to subsoil drains where applicable. Do not excavate within the drip line of trees and shrubs to be retained. Cultivate or rip the subsoil to a further depth of 100mm before placing top soil. Remove stones of size exceeding 25mm, clods of earth exceeding 50mm, and weeds, rubbish or other deleterious material brought to the surface during cultivation. Do not disturb services or existing tree roots. If necessary cultivate these areas by hand. During cultivation, thoroughly mix in materials required to be incorporated into the subsoil, as recommended in the soil testing results and to manufacturer's recommendations. Trim the surface to design levels again after cultivation.

Topsoil

Import topsoil for the garden and turf areas, unless the topsoil can be provided from material recovered from the site, as recommended in the soil testing results. Spread the topsoil on the prepared subsoil and grade evenly, compact lightly and uniformly in 150mm layers. Avoid differential subsidence and excess compaction and produce a finished topsoil surface which has the following characteristics:

- Finished to design levels, allowing for mulch or turf, which is to finish flush with adjoining hard surfaces such as paths and edges;
- Smooth and free from inorganic matter, stones or clods of soil;
- Graded to drain freely, without ponding, to catchment and/or sub-soil drains; Graded evenly to adjoining surfaces; and
- Ready for planting.

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Compost

Provide, in accordance with AS 4454, well rotted vegetative material or animal manure, free from harmful chemicals, inorganic matter, grass, weeds and the reproductive parts of unwanted plants.

Provide proprietary fertilisers, delivered to the site in sealed containers marked to show manufacturer or vendor, weight, fertiliser type, N:P:K ratio, recommended uses, application rates and safety procedures. Apply appropriate fertiliser suited to the provenance of plants (indigenous or exotic) included in the design.

Supply plants in accordance with the landscape design drawings and schedules, which have the following characteristics: Large healthy root systems, with no evidence of root curl, restriction or

- damage; • Vigorous, well established, free from disease and pests, of good form
- consistent with the species/variety; Hardened off, not soft or forced, and suitable for planting in the natural climatic conditions prevailing at the site in full sun, partial shade or full shade
- Grown in final containers for not less than twelve weeks;
- Trees, unless required to be multi-stemmed, shall have a single leading shoot;
- Containers shall be free from weeds and of appropriate size in relation to the specified plant size.

Following excavation of the planting hole, place and spread 15gms of wetting agent pre-mixed with one (1) litre of water. Place the plant correctly orientated to north or for best presentation. Backfill the planting holes with specified topsoil mixture. Lightly tamp and water to eliminate air pockets. Ensure that the backfill soil is not placed over the top of the root ball and that the root ball is not higher than the soil in which it is planted. Apply fertiliser, as specified around the plants in the soil at the time of planting.

Embankment Stabilisation

Where necessary and shown on the drawings prevent soil erosion or soil movement by stabilising embankments as follows. As a minimum this should be on slopes steeper than or equal to 1:3 gradient. Stabilise embankments using biodegradable fibre reinforced heavy weight jute fabric. Lay fabric from top to bottom of slope. Install in accordance with manufacturer's specification, including 300 x 300mm anchor trench at top and bottom of slope, backfilled with soil over the fabric and compacted into the trenches. Using U-shaped galvanised steel pegs at 1000 mm centres generally and 250mm centres at edge overlaps, secure the fabric to the prepared soil surface. Plant through the fabric after it is installed.

Root Barrier

Supply and install root control barriers to all new tree plantings adjacent to walls, paths, kerbs and all service trenches, where their proximity poses a threat to the stability of the built infrastructure. Install in accordance with manufacturer's recommendations.

Unless noted otherwise, mulch shall be approved proprietary recycled wood fibre or pine bark material. Place mulch in all garden beds to a depth of 75mm after all specified plants are installed. Keep mulch clear of all plant stems and rake to an even plane, flush with the surrounding surfaces evenly graded between design surface levels. Over fill to allow mulch to settle to the specified depth.

Stakes and Ties

Stakes shall be durable hardwood, straight, free of knots and twists, pointed at one end, in the following quantities and sizes for each of the various plant pot

- Plants >25 It: 1 off 38 x 38 x 1200mm;
- Semi-advanced plants >75 lt: 2 off 50x50x 1800mm; Advanced plants >100 It: 3 off 50 x 50 x 2400mm

Turf shall be delivered to site as 25mm minimum thick cut rolls. Obtain turf from a specialist grower of cultivated turf. Turf shall have an even thickness, free from weeds and other foreign matter. Deliver turf to the site within 24 hours of being cut and lay it within 24 hours of delivery. Prevent it form drying out between cutting and laying. Lay the turf in the following manner:

- In stretcher pattern, joints staggered and close butted;
- Parallel long sides of level areas, with contours on slopes; and • To finish flush, after lightly tamping, with adjacent finished surfaces and design
- Species: Stenotaphrum secundatum Sir Walter Soft-leaf Buffalo.

IRRIGATION

Scope: Unless otherwise noted or instructed irrigate all planted areas shown on plans including planters, tubs, gardens, turf and the like.

The irrigation system shall be an automatic permanent system, with an irrigation controller self operated via a soil moisture sensor. The system shall be calibrated to deliver the optimum rate and volume of water appropriate to the type of plants in the design. The system shall be adjustable and fully serviceable. The layout of the entire irrigation system shall focus on delivering the required amount of water to maintain healthy and vigorous growth. The irrigation system shall be such that, component theft, vandalism, over-spray and wetting of paths shall be reduced to a minimum or completely eliminated by the use of drip, pop-up sprinklers and judiciously placed fixed spray emitters. Generally do not use fine mist emitters that provide a drifting mist that may wet paths and the buildings unless specifically required by the design.

LANDSCAPE MAINTENANCE

The Landscape Contractor shall rectify defects during installation and that become apparent in the works under normal use for the duration of the contract Defects Liability Period. Unless contracted otherwise, the Landscape Contractor shall maintain the contract areas by the implementation of industry accepted horticultural practices for 52 weeks from Practical Completion of the works. The landscape maintenance works shall include, but not be limited to:

MJW RS 11.10.22

- Replacing failed plants;
- Pruning;
- Insect and pest control;

LEGEND

 Fertilising; Maintaining and removing stakes and ties;

Maintaining mulch;

 Mowing and top dressing; Irrigation and watering;

 Erosion control; and Weeding and rubbish removal.

Maintenance Log Book Implement and keep a maintenance log book recording when and what maintenance work has been undertaken and what materials, actions and decisions have been used, implemented and concluded to keep the landscape always looking its best. Enter data daily and review information every 2 weeks. Observe trends and develop a maintenance regime around seasonal and observed event occurrences.

Maintenance Activities

During the defects maintenance period schedule the following activities to occur

- Plant replacement Replace plants that have failed to mature, die or are damaged. Replacement plants shall be in a similar size and quality and identical species or variety to the plant that has failed. Replacement of plants shall be at the cost of the landscape contractor unless advised otherwise. If the cause of the failure is due to a controllable situation then correct the situation prior to replacing plants. Observe and replace failed plants within 2
- **Pruning** Prune dead wood, broken limbs, dead or infected foliage and as needed to develop strong, healthy plants to achieve the shape and form expected of the plant type. Observe daily and prune plants on a needs basis. **Insect, disease and pest control -** Avoid spraying:
- if ever possible; in wet weather or if wet weather is imminent;
 - if target plants are still wet after rain;
- in windy weather; and if non-target species are too close.

Immediately report to the Project Manager any evidence of intensive weed infestation, insect attack or disease amongst plant material. Submit all proposals to apply chemicals and obtain approval before starting this work. When approved, spray with herbicide, insecticide, fungicide as appropriate in

accordance with the manufacturers' recommendations. Observe daily and act as necessary to control any infestation or disease. Record in the logbook all relevant details of spraying activities including:

- Product brand / manufacturer's name, Chemical / product name,
- Chemical contents
- Application quantity and rate, Date of application and location,
- Results of application, and
- Use approval authority.
- Fertilising Fertilise gardens with a proprietary slow release fertiliser applied in accordance with the manufacturer's directions and recommendations. Apply 6-12 monthly. Record in the logbook all relevant details of fertilising including:
- Product brand / manufacturer's name,
- Fertiliser / product name,
- Application quantity and rate, and Date of application and location.
- Stakes and ties Adjust and replace as required to ensure plants remain correctly staked. Remove those not required at the end of the planting establishment period (Defects Liability Period). Inspect and act at least every 2 weeks.
- Maintaining mulch Maintain the surface in a clean, tidy and weed free condition and reinstate the mulch as necessary to ensure correct depth as specified. Observe weekly and replenish mulch as required.
- Mowing and top dressing Mow the turf to maintain a grass height of between 30-50mm. Do not remove more than one third of the grass height at any one time. Remove grass clippings from the site after each mowing. To dress to a maximum of 10mm to fill depressions and hollows in the surface. Mow weekly/fortnightly in warmer months. Mow monthly or as required in
- cooler months. Top dress at approximately 6 monthly intervals. Irrigation and watering - Maintain the irrigation system to sure that each individual plant receives the required amount of water to maintain healthy and vigorous growth. Adjust and calibrate as required. Provide additional watering, if necessary but inspect irrigation weekly and make repairs as
- necessary. Erosion control - Where necessary, maintain the erosion control fabric in a tidy and weed free condition and reinstate as necessary to ensure control measures are effective where deemed necessary. Inspect every 2 weeks and act to repair any damage as soon as possible.
- Weeding and rubbish removal During the plant establishment period remove by hand, rubbish and weed growth that may occur or re-occur throughout all planted, mulched and paved areas. The contractor shall target weeds that are capable of producing a major infestation of unwanted plants by seed distribution. Whenever possible, time weed removal to precede flowering and seed set. Constant observation and removal of weeds is

SS22-5	030 183 Macquarie Street, Parrar	natta NSW.				
Plant Sc	hedule					
Symbol	Botanical Name	Common Name	Mature	Mature	Pot Size	Qty
			Height (m.)	Spread (m.)		
	Trees					
Hf	Howea forsteriana	Kentia Palm	20	5	3m clear trunk height	2
MLG	Magnolia grandiflora 'Little Gem'	Dwarf Magnolia	5	3	200L	2
Ns	Nyssa sylvatica	Black Tupelo	11	6	200L	1
	Accents & Shrubs					
Ae	Aspidistra elatior	Cast Iron Plant	0.4	0.2	200mm	16
AiR	Alcantarea imperialis 'Rubra'	Giant Bromeliad	1.2	1.2	300mm	12
Мр	Murraya panniculata	Orange jessamine	3.0	2.0	300mm	15
Re	Rhapis excelsa	Lady Palm	2.0	1.0	1.2m high	15
ROP	Raphiolepsis 'Oriental Pearl'	Oriental Pearl	1	1	200mm	7
Sa	Syzygium australe 'Resilience'	Lilly Pilly	3	2	300mm	28
Zf	Zamia furfuracea	Cardboard Plant	0.5	0.5	200mm	7
	Grasses & Groundcovers					
CBB	Crassula 'Bluebird'	Jade plant	0.5	0.5	300mm	19
Lm	Liriope muscari	Evergreen Giant	6/m2	0.5 x 0.5	150mm	26
Px	Philodendron Xanadu	Xanadu	5/m2	0.8 x 1.0	150mm	33

Key Plan:

SITE IMAGE

RAPISARDA INVESTMENTS

Level 1, 3-5 Baptist Street Redfern NSW 2016 Tel: (61 2) 8332 5600 Fax: (61 2) 9698 2877

Landscape Architects

Student Accommodation 183 Macquarie Street Parramatta NSW

Landscape Specification / Indicative Planting Schedule


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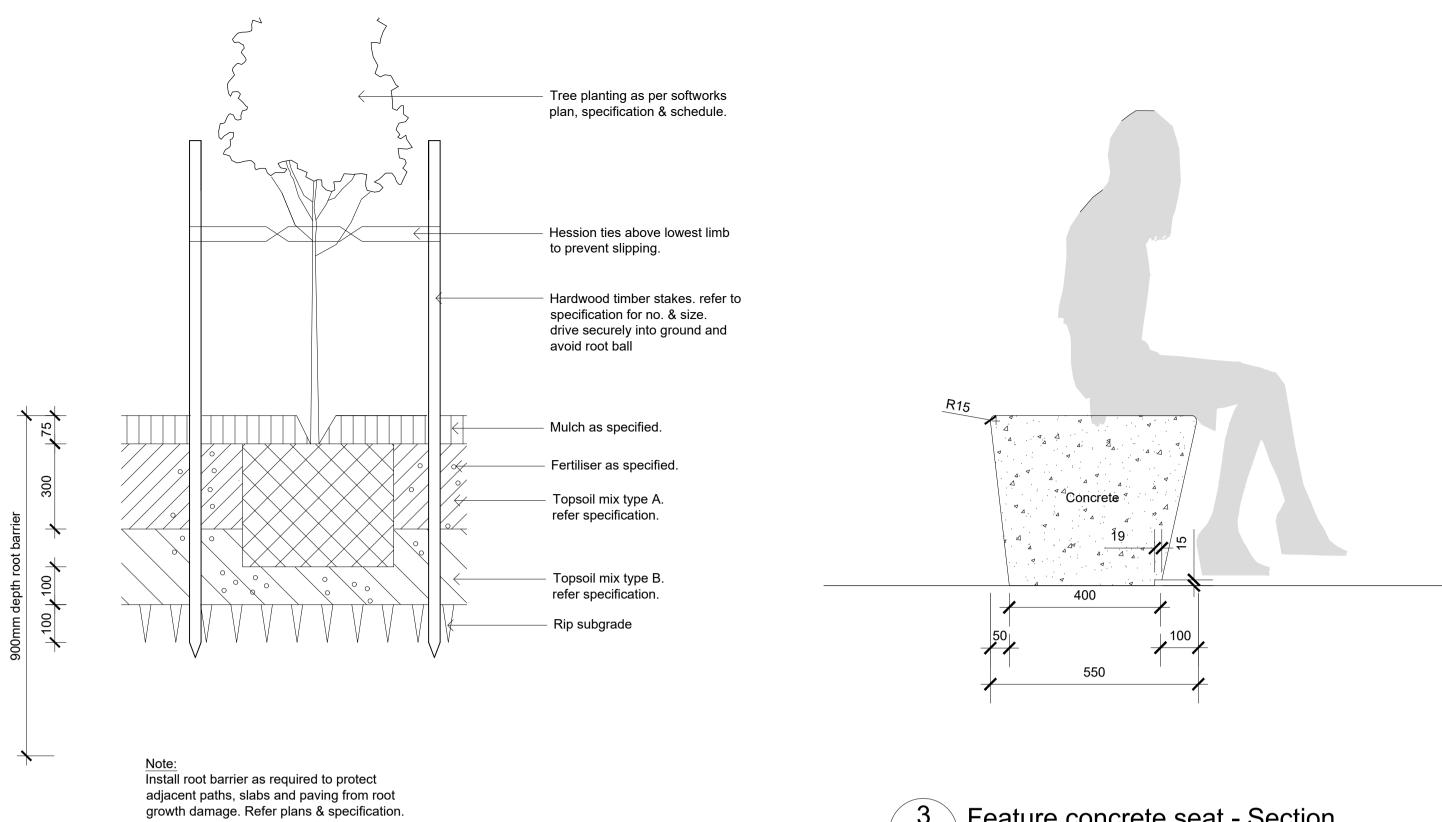
PRELIMINARY Drawing Number: 501 B

SS22-5030

Issue Revision Description Drawn Check Date

B Preliminary A Preliminary BS RS 16.09.22




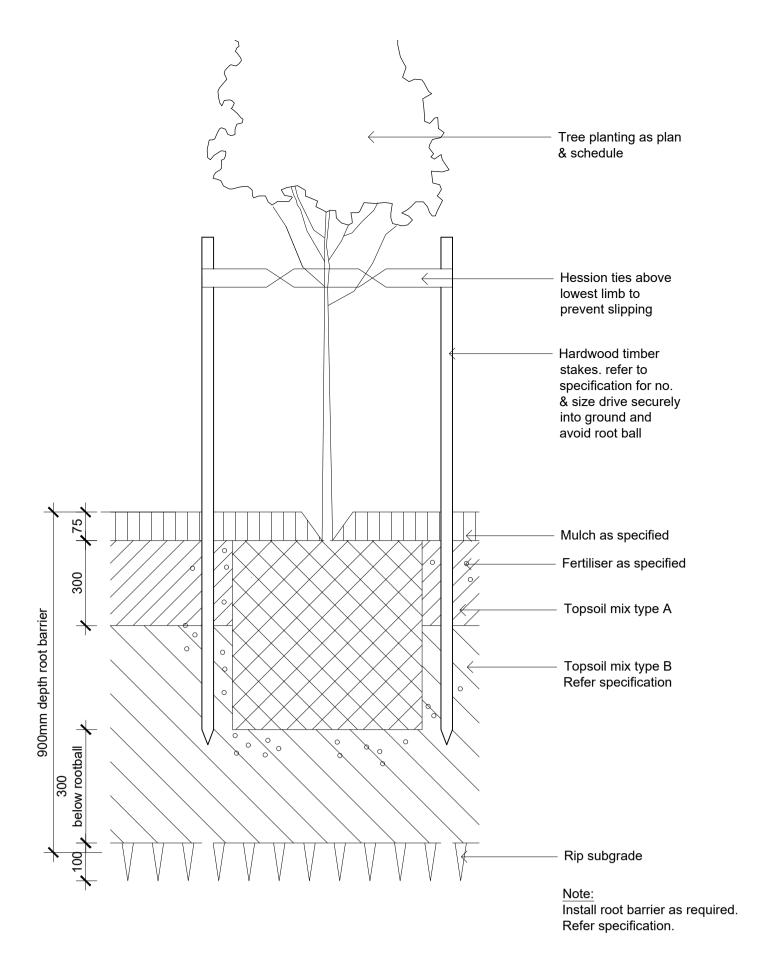


2 Detail 25-75L Tree Planting on Grade 502 1:10

Feature concrete seat - Section 502 1:10


Detail 75-200L Tree Planting on Grade 502 1:10

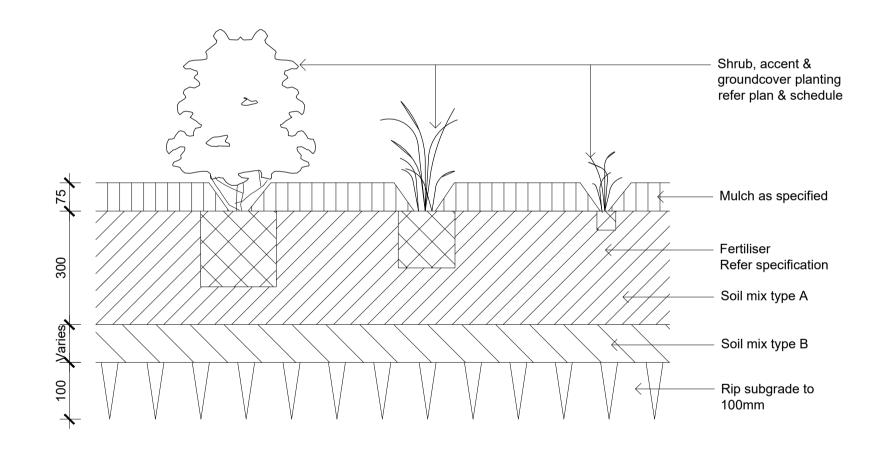

Detail Shrub Accent & Groundcover Planting on Grade 502 1:10

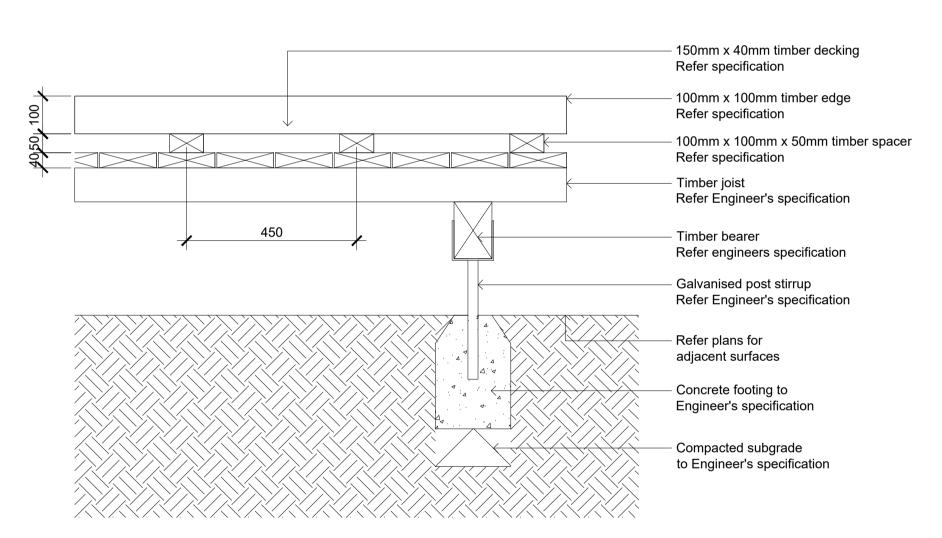

RAISED TIMBER DECK - SECTION AA 502 SCALE 1:10

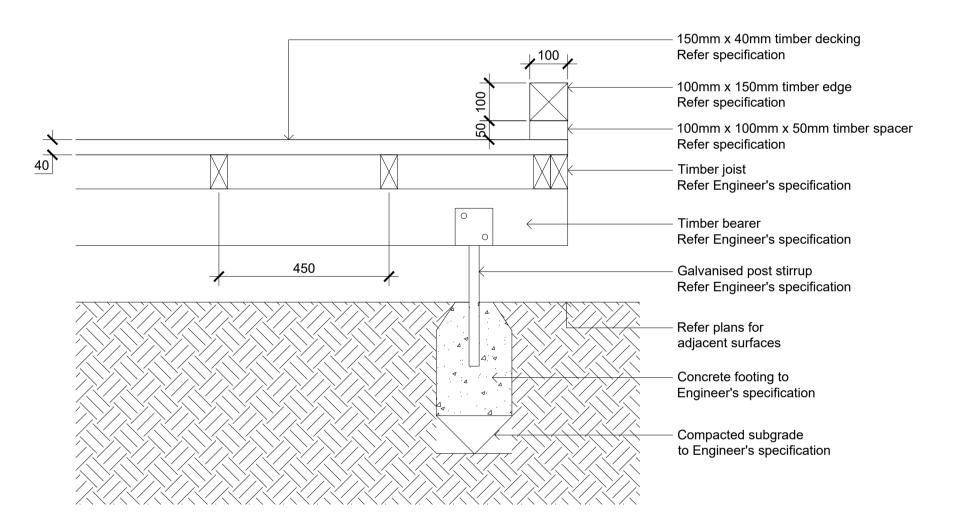

RAISED TIMBER DECK - SECTION BB 502 SCALE 1:10

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MJW RS 11.10.22 BS RS 16.09.22 Drawn Check Date

LEGEND

Key Plan:



RAPISARDA INVESTMENTS

Landscape Details

Student Accommodation 183 Macquarie Street

PRELIMINARY Job Number: Drawing Number:

502 B

Tel: (61 2) 8332 5600 Fax: (61 2) 9698 2877 Parramatta NSW SS22-5030 Issue Revision Description