
# 2-4 BOUNDARY ST & 85 RAILWAY ST, PARRMATTA PROPOSED RESIDENTIAL FLAT BULIDING

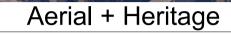












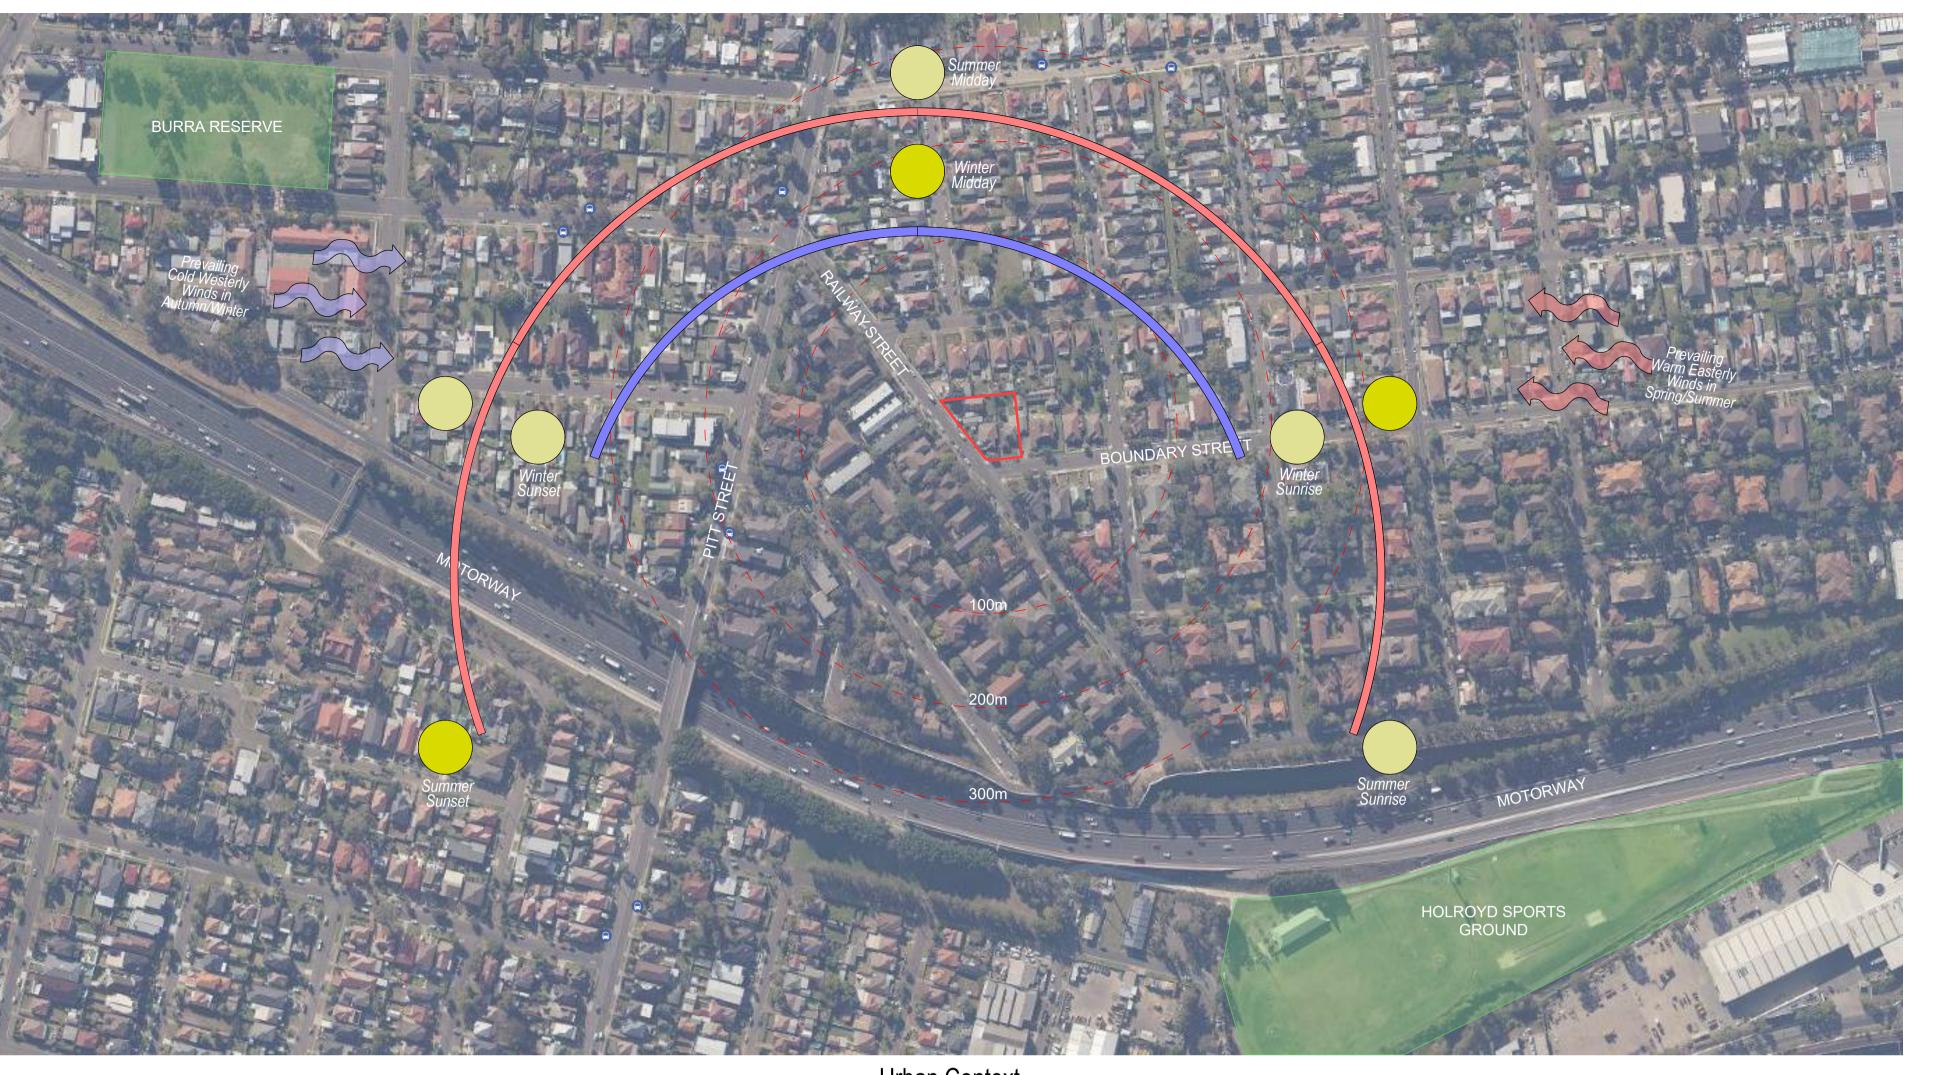



**Local Context** 



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PAGE| SCALE A1 | 1:1

CLIENT
INFINITY IDEAS PTY LTD

PROJECT RESIDENTIAL FLAT BUILDING

ADDRESS
2-4 BOUNDARY ST & 85 RAILWAY ST, PARRMATTA


LOCAL COUNCIL

CITY OF PARRAMATTA COUNCIL

DRAWING SITE ANALYSIS

PROJECT NUMBER DRAWN BY: MT DESIGNED BY: AW ISSUED FOR: DA



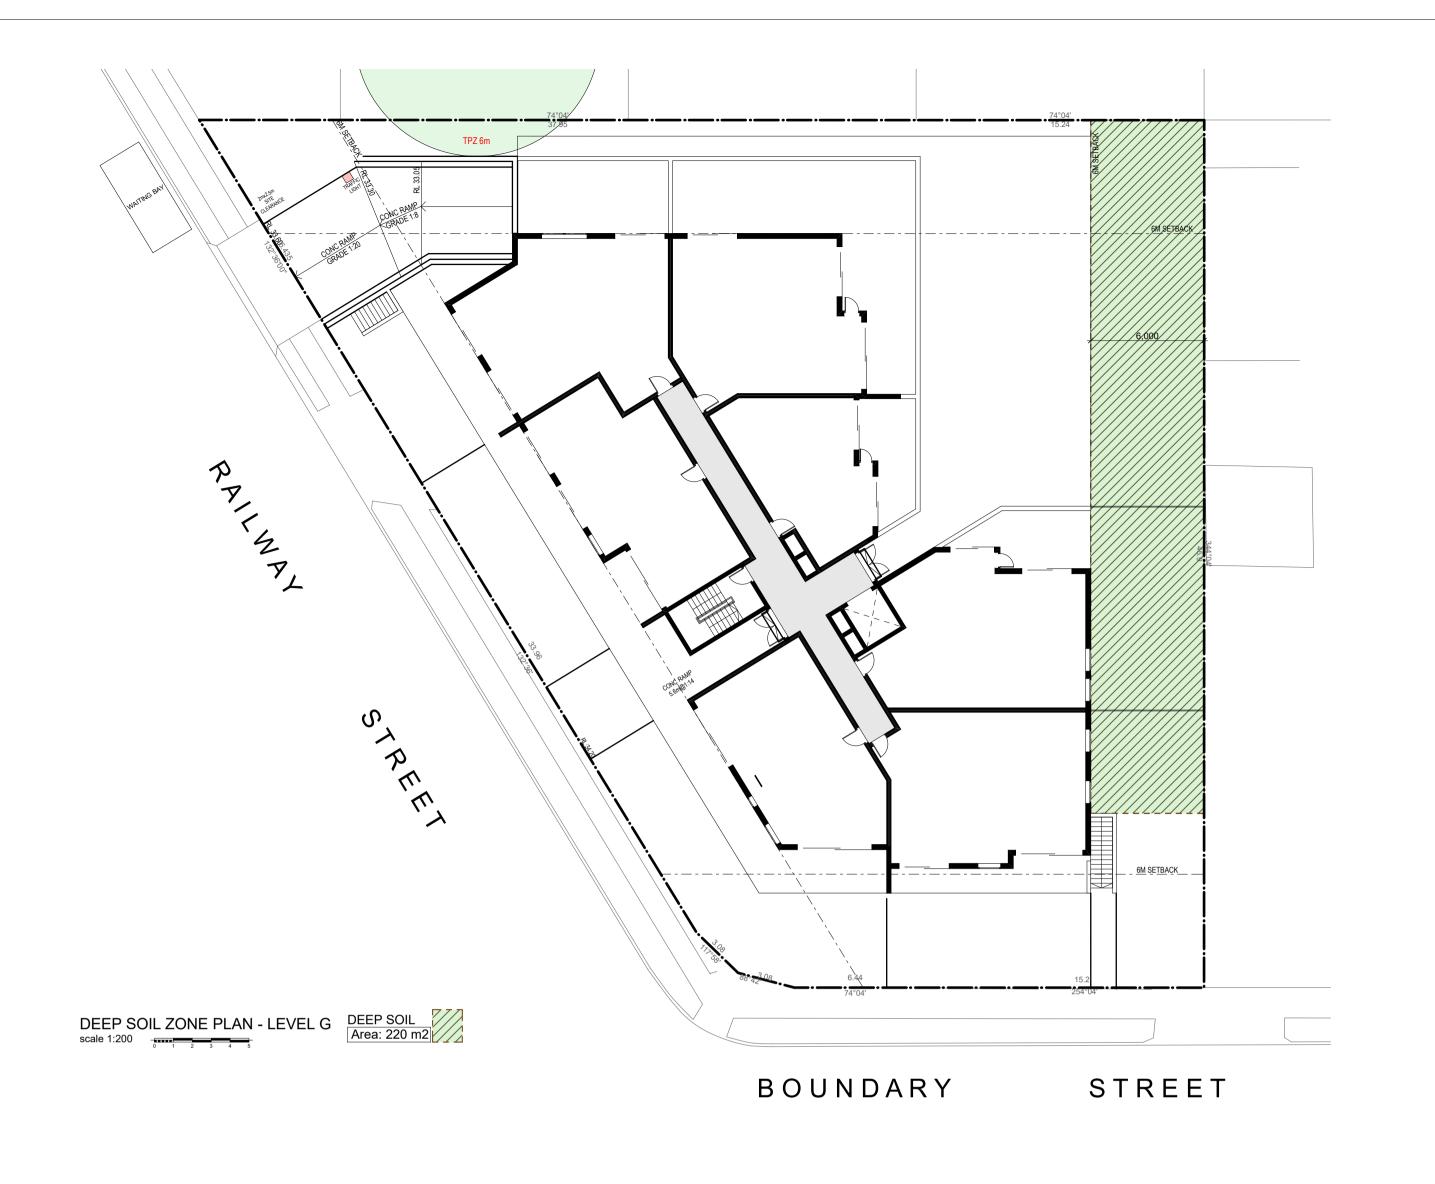



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	AMENDMENTS					
REV	DATE	DESCRIPTION				
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В	22/06/2022	SUBMITTED ADDITIONAL INFORMATION				



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PROJECT
RESIDENTIAL FLAT BUILDING


2-4 BOUNDARY ST & 85 RAILWAY ST,

PARRMATTA LOCAL COUNCIL

CITY OF PARRAMATTA COUNCIL DRAWING SITE ZONES SHEET 2

DATE: PROJECT NUMBER DRAWN BY: MT DESIGNED BY: AW ISSUED FOR: DA



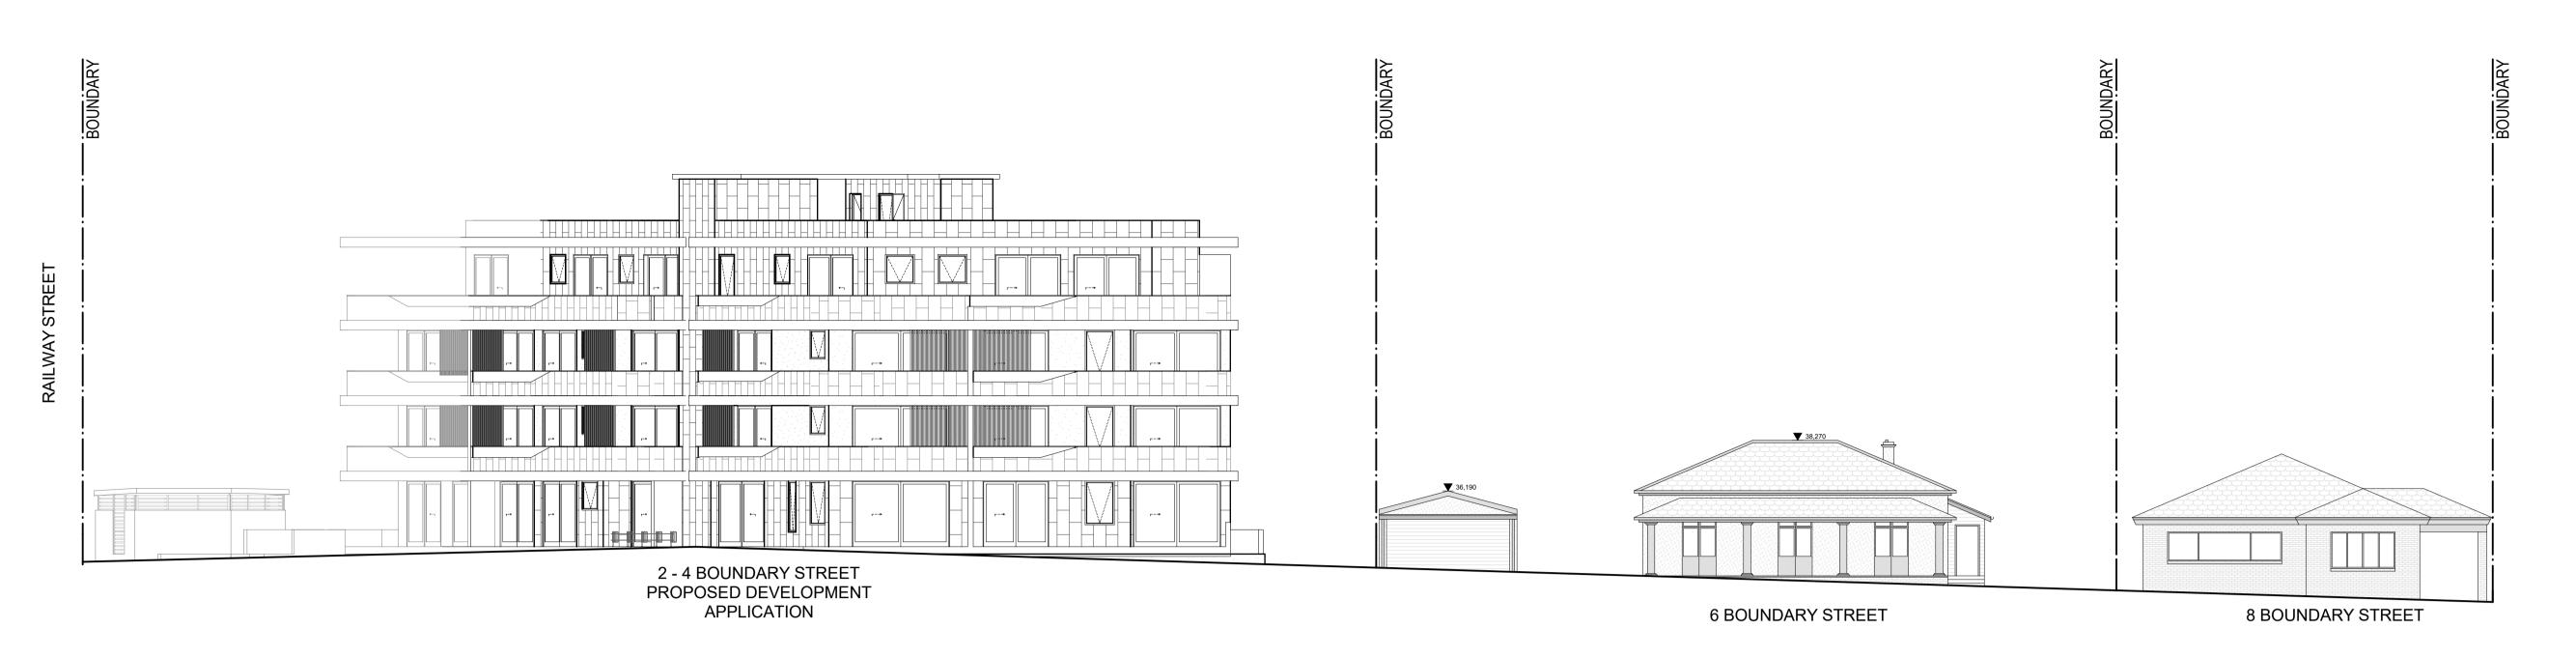

BOUNDARY STREETSCAPE scale 1:150

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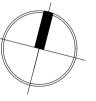
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DESCRIPTION

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A1 | 1:150

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PROJECT
RESIDENTIAL FLAT BUILDING

2-4 BOUNDARY ST & 85 RAILWAY ST, PARRMATTA

LOCAL COUNCIL CITY OF PARRAMATTA COUNCIL

DRAWING STREETSCAPE

DATE: PROJECT NUMBER DRAWN BY: MT DESIGNED BY: AW

DRAWING NUMBER

ISSUED FOR: DA

#### **CALCULATIONS**

SITE DETAILS

2-4 BOUNDARY ST & 85 RAILWAY ST, PARRMATTA

DP 202700 Lot 2 DP 202700 Lot 6 DP 16496

Site Area

1,793.6m<sup>2</sup>

#### COMPLIANCE

CATEGORY	REQUIREMENT	PROPOSAL
Zoning	R4 Residential High Density	
FSR	1.2:1 = 2,152.32m <sup>2</sup>	2,152
Max Height	14m	4 Storeys
Communal Open Space	ADG 25% min, 448.4m <sup>2</sup>	497
Landscaping	30% min, 538.08m <sup>2</sup>	609
Deep Soil	07% min, 142.73m <sup>2</sup> 15% min, 269,04m <sup>2</sup>	220
Parking	31 Spaces Residential 6.25 Visitor	31 Resident Spaces
	37.25 Spaces	7 Visitor Spaces
Solar Access	70% of units, 18 Units	76%, 19 Units
Natural Ventilation	60% of units, 15 Units	76%, 19 Units

GROSS FLOOR AREA					
LEVEL	AREA (m2)				
GROUND	565				
LEVEL 1	578				
LEVEL 2	578				
LEVEL 3	432				
	•				

TOTAL GFA	
	AREA (m
	2.17

>		· ·	 •
	<b>UNIT BREAK</b>	<b>KDOWN</b>	
	<b>UNIT TYPE</b>		QUANTI
	1 Bed		
$\geq$	2 Bed		
	3 Bed		
	2 Bed		


#### **TOTAL UNITS** QUANTITY


ADG - COMMUNAL	OPEN SPACE
NAME	AREA (m
COMMUNAL OPEN SPACE	49
	-


ADG - DEEP SOIL	
NAME	AREA (
DEEP SOIL	

AREA (m2
609

CONTENTS				
PAGE NO.	DRAWING DESCRIPTION			
0000	VISUALISATION			
0001	CALCULATIONS			
0002	BASIX COMMITMENTS			
0003	SITE ANALYSIS			
0004	DEMOLITION PLAN			
0005	SEDIMENTATION CONTROL PLAN			
0006	SITE PLAN			
0007	SITE ZONES SHEET 1			
8000	SITE ZONES SHEET 2			
0009	STREETSCAPE			
1001	BASEMENT PLAN			
1002	GROUND FLOOR			
1003	LEVEL 1			
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1005	LEVEL 3			
1006	ROOF PLAN			
2001	ELEVATIONS			
2002	ELEVATIONS			
3001	SECTIONS			
4001	WINDOW & DOOR SCHEDULE			
4002	ADAPTION DETAILS			
4003	SOLAR DIAGRAMS			
4004	SOLAR DIAGRAMS			
4005	CROSS VENTILATION DIAGRAMS			
4006	CROSS VENTILATION DIAGRAMS			
4007	STRATA PLAN			
4008	STRATA PLAN			
4009	DIMENSIONED FLOOR PLANS			
4010	DIMENSIONED FLOOR PLANS			
4011	SHADOW DIAGRAMS			
4012	DETAILS			
4013	3D HEIGHT PLANE			

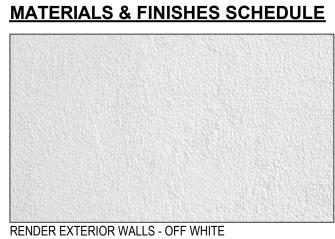

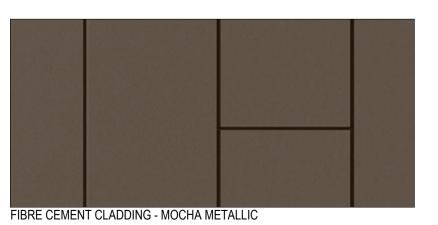

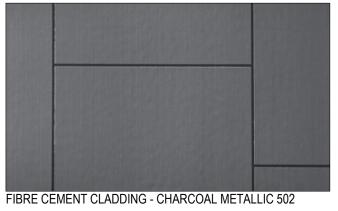

**UNIT SCHEDULE** 

3 Bed

99 L3

Unit G01

Unit G02

Unit G03

Unit G04

Unit G05

Unit G06

Unit G07

Unit 101

Unit 102

Unit 103

Unit 104

Unit 105

Unit 106

Unit 107

Unit 201

Unit 202

Unit 203

Unit 204

Unit 205

Unit 206

Unit 207

Unit 301

Unit 302

Unit 304

Unit 303



E	DULE			POS SCI	POS SCHEDULE			
	UNIT TYPE	AREA (m2)	Floor (Story)	UNIT	POS	AREA (m2)	ADG (m2)	
	2 Bed	81	GROUND	Unit G01	COURTYARD	57	15m2	
	2 Bed	77	GROUND	Unit G02	COURTYARD	84	15m2	
	1 Bed	50	GROUND	Unit G03	COURTYARD	18	15m2	
	2 Bed	81	GROUND	Unit G04	COURTYARD	84	15m2	
	2 Bed	80	GROUND	Unit G05	COURTYARD	71	15m2	
	1 Bed	67	GROUND	Unit G06	COURTYARD	119	15m2	
	2 Bed	70	GROUND	Unit G07	COURTYARD	81	15m2	
	2 Bed	81	L1	Unit 101	BALCONY	21	10m2	
	2 Bed	77	L1	Unit 102	BALCONY	26	10m2	
	1 Bed	50	L1	Unit 103	BALCONY	16	8m2	
	2 Bed	81	L1	Unit 104	BALCONY	20	10m2	
	2 Bed	80	L1	Unit 105	BALCONY	17	10m2	
	2 Bed	78	L1	Unit 106	BALCONY	21	10m2	
	2 Bed	70	L1	Unit 107	BALCONY	17	10m2	
	2 Bed	81	L2	Unit 201	BALCONY	21	10m2	
	2 Bed	77	L2	Unit 202	BALCONY	26	10m2	
	1 Bed	50	L2	Unit 203	BALCONY	16	8m2	
	2 Bed	81	L2	Unit 204	BALCONY	20	10m2	
	2 Bed	80	L2	Unit 205	BALCONY	17	10m2	
	2 Bed	78	L2	Unit 206	BALCONY	21	10m2	
	2 Bed	70	L2	Unit 207	BALCONY	17	10m2	
	3 Bed	101	L3	Unit 301	BALCONY	83	12m2	
	3 Bed	104	L3	Unit 302	BALCONY	46	12m2	
	2 Bed	97	L3	Unit 303	BALCONY	38	12m2	
_				• -		_		

BALCONY

Unit 304

INTERNAL STORAGE SCHEDULE					
UNIT	NAME	LOCATION	VOLUME (m3)		
Unit G01	STR.	Internal	6		
Unit G02	STR.	Internal	4		
Unit G03	STR.	Internal	3		
Unit G04	STR.	Internal	6		
Unit G05	STR.	Internal	5		
Unit G06	STR.	Internal	3		
Unit G07	STR.	Internal	5		
Unit 101	STR.	Internal	6		
Unit 102	STR.	Internal	4		
Unit 103	STR.	Internal	3		
Unit 104	STR.	Internal	6		
Unit 105	STR.	Internal	5		
Unit 106	STR.	Internal	4		
Unit 107	STR.	Internal	5		
Unit 201	STR.	Internal	6		
Unit 202	STR.	Internal	4		
Unit 203	STR.	Internal	3		
Unit 204	STR.	Internal	6		
Unit 205	STR.	Internal	5		
Unit 206	STR.	Internal	4		
Unit 207	STR.	Internal	5		
Unit 301	STR.	Internal	5		
Unit 302	STR.	Internal	9		
Unit 303	STR.	Internal	5		
Unit 304	STR.	Internal	4		

NAL STORAGE SCHEDULE				EXTERNA	L STORAGE	SCHEDULE	
	NAME	LOCATION	VOLUME (m3)	UNIT	NAME	LOCATION	VOLUME (m3)
	STR.	Internal	6	Unit G01	Storage	External	4
	STR.	Internal	4	Unit G02	Storage	External	4
	STR.	Internal	3	Unit G03	Storage	External	4
•	STR.	Internal	6	Unit G04	Storage	External	4
,	STR.	Internal	5	Unit G05	Storage	External	4
,	STR.	Internal	3	Unit G06	Storage	External	4
•	STR.	Internal	5	Unit G07	Storage	External	4
	STR.	Internal	6	Unit 101	Storage	External	4
	STR.	Internal	4	Unit 102	Storage	External	4
	STR.	Internal	3	Unit 103	Storage	External	4
	STR.	Internal	6	Unit 104	Storage	External	4
	STR.	Internal	5	Unit 105	Storage	External	4
	STR.	Internal	4	Unit 106	Storage	External	4
	STR.	Internal	5	Unit 107	Storage	External	3
	STR.	Internal	6	Unit 201	Storage	External	5
	STR.	Internal	4	Unit 202	Storage	External	5
	STR.	Internal	3	Unit 203	Storage	External	5
	STR.	Internal	6	Unit 204	Storage	External	10
	STR.	Internal	5	Unit 205	Storage	External	5
	STR.	Internal	4	Unit 206	Storage	External	5
	STR.	Internal	5	Unit 207	Storage	External	9
	STR.	Internal	5	Unit 301	Storage	External	6
	STR.	Internal	9	Unit 302	Storage	External	19
	STR.	Internal	5	Unit 303	Storage	External	21
	STR.	Internal	4	Unit 304	Storage	External	16



Nominated	Architect
Adriaan Winton	NSW Architects Registration Board 5347
Unit 43 / 2 Slough Avenue Silverwater, NSW 2128	Phone: 02 9648 8848
admin@idraft.com.au	www.idraft.com.au

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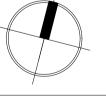
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	AMENDMENTS						
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В	14/09/2022	SUBMITTED ADDITIONAL INFORMATION					



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PAGE| SCALE A1

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PROJECT
RESIDENTIAL FLAT BUILDING

2-4 BOUNDARY ST & 85 RAILWAY ST, PARRMATTA


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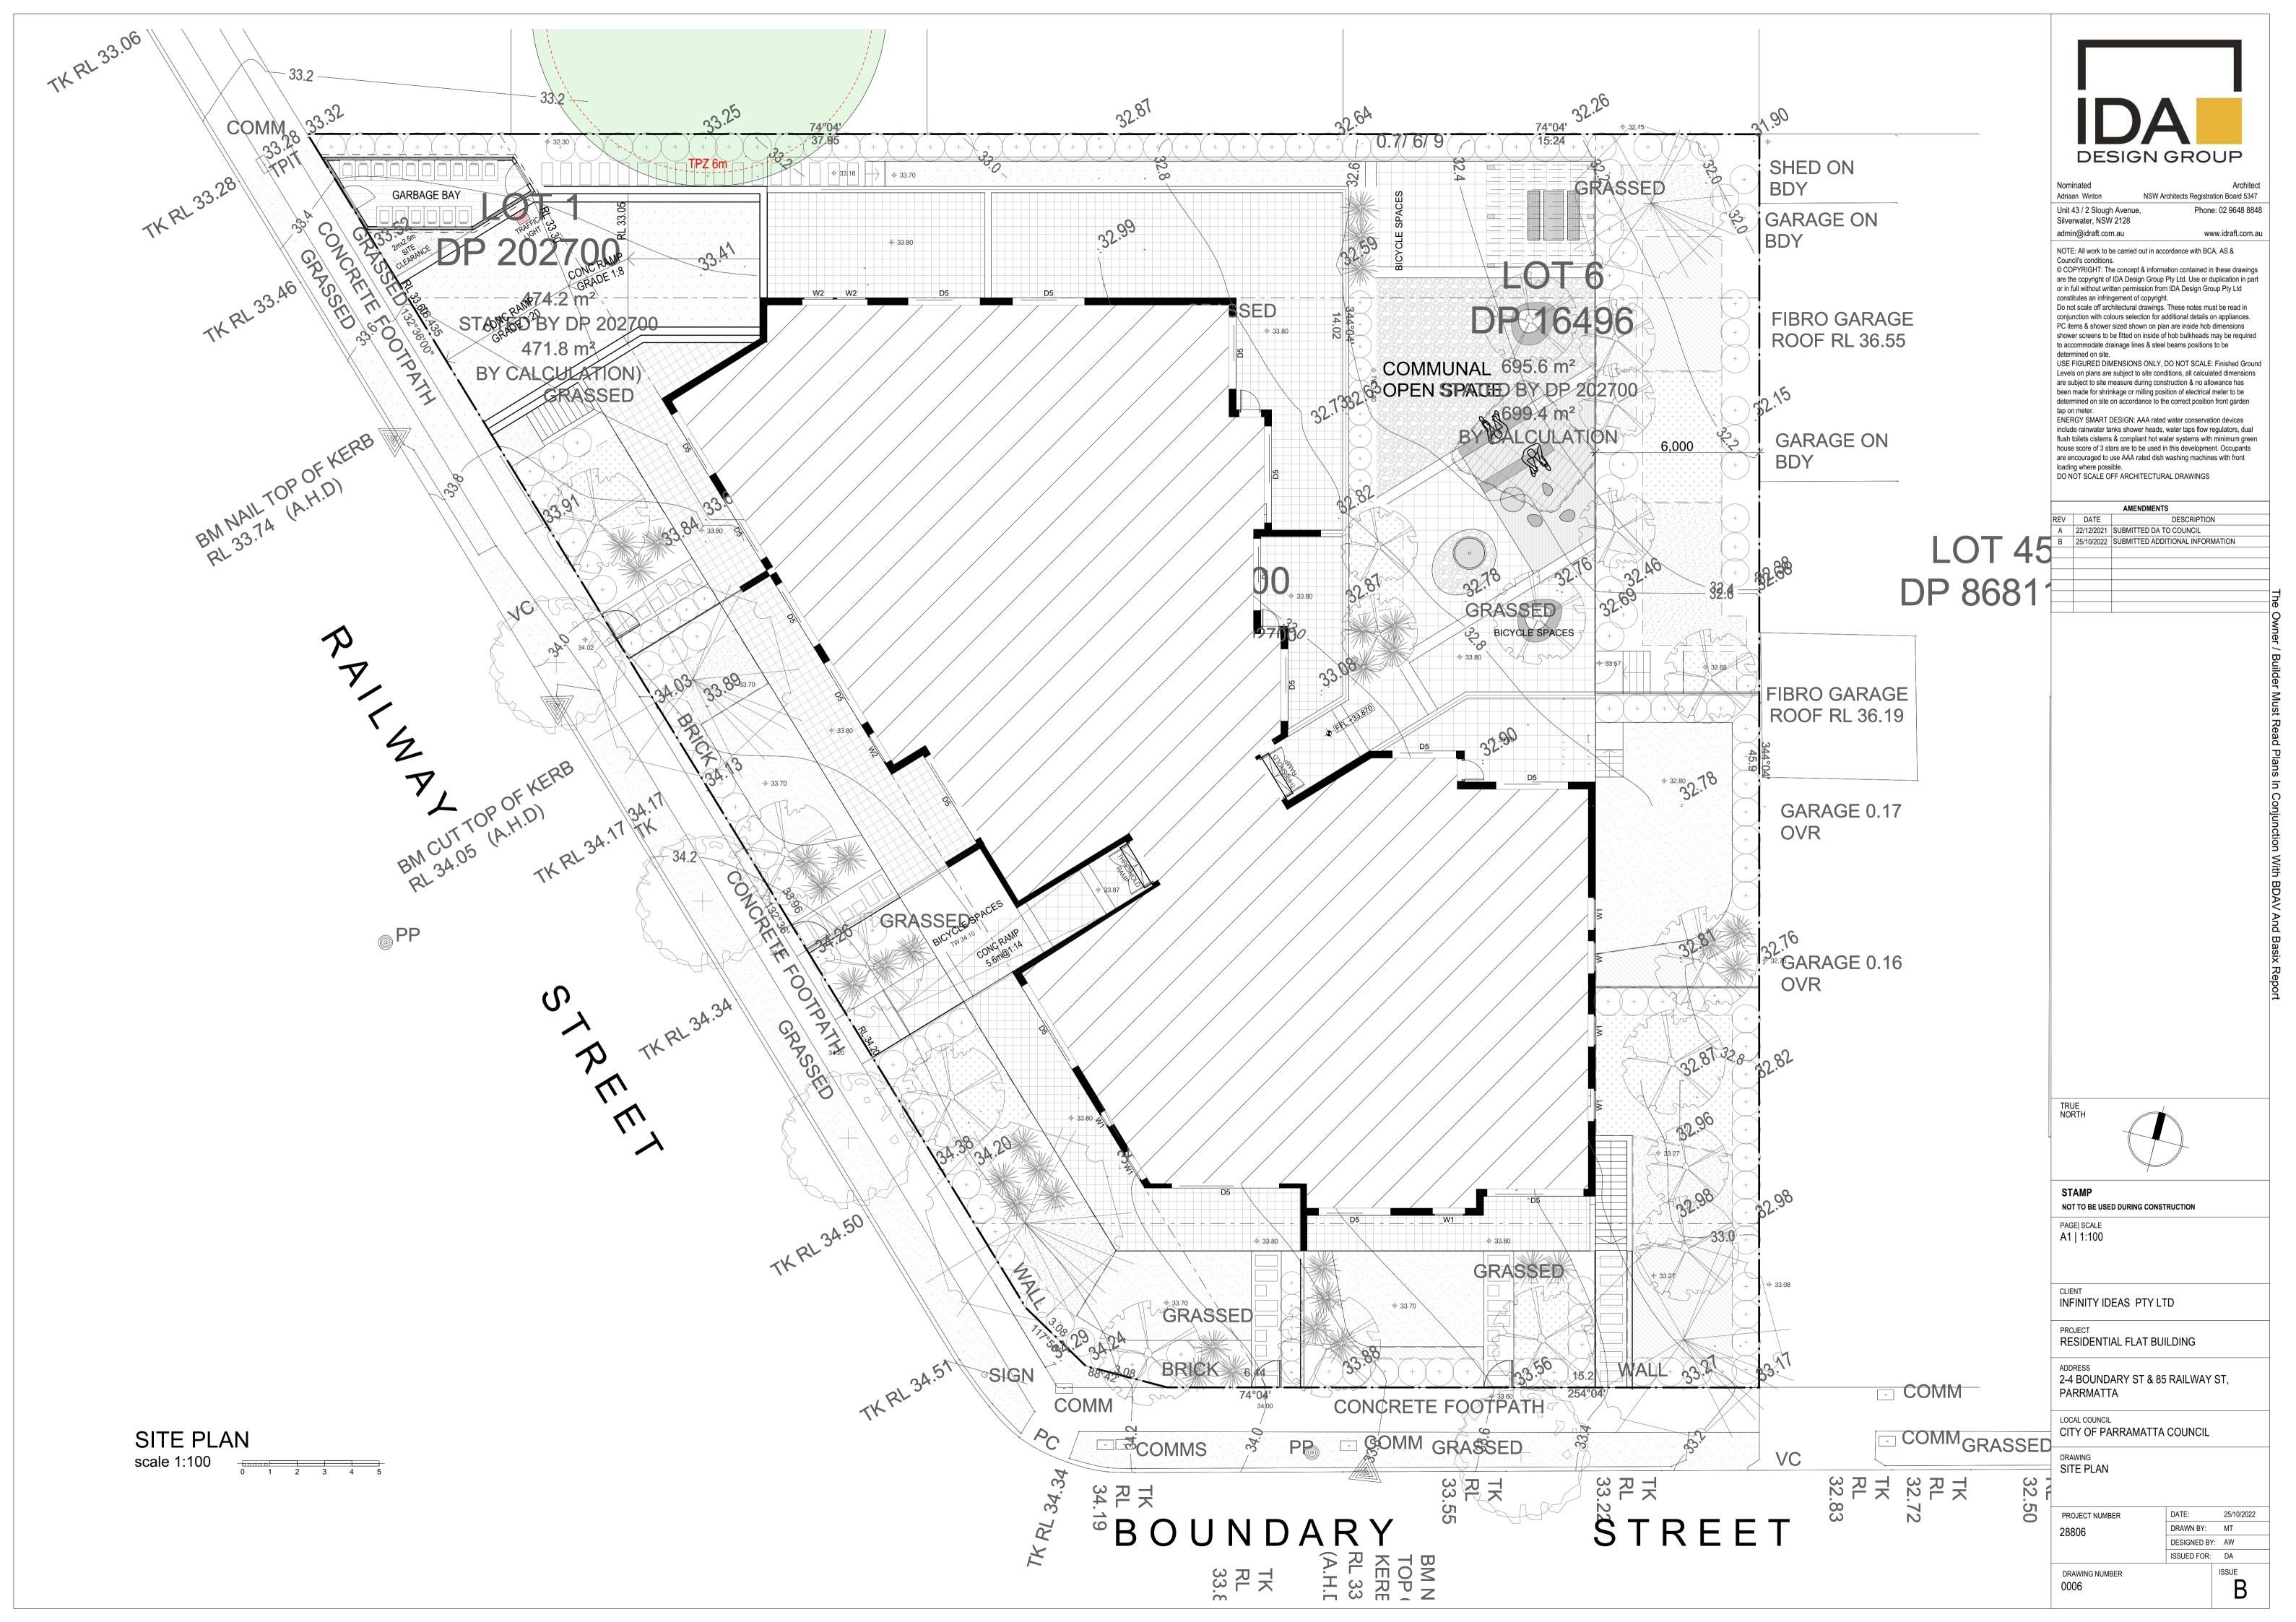
DRAWING CALCULATIONS

PROJECT NUMBER	DATE:	14/09/2022
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20000	DESIGNED BY	r: AW
	ISSUED FOR:	DA
DRAWING NUMBER		ISSUE

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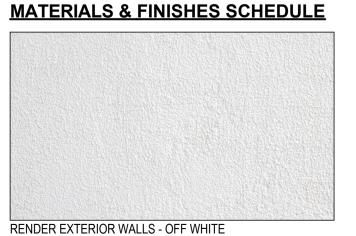







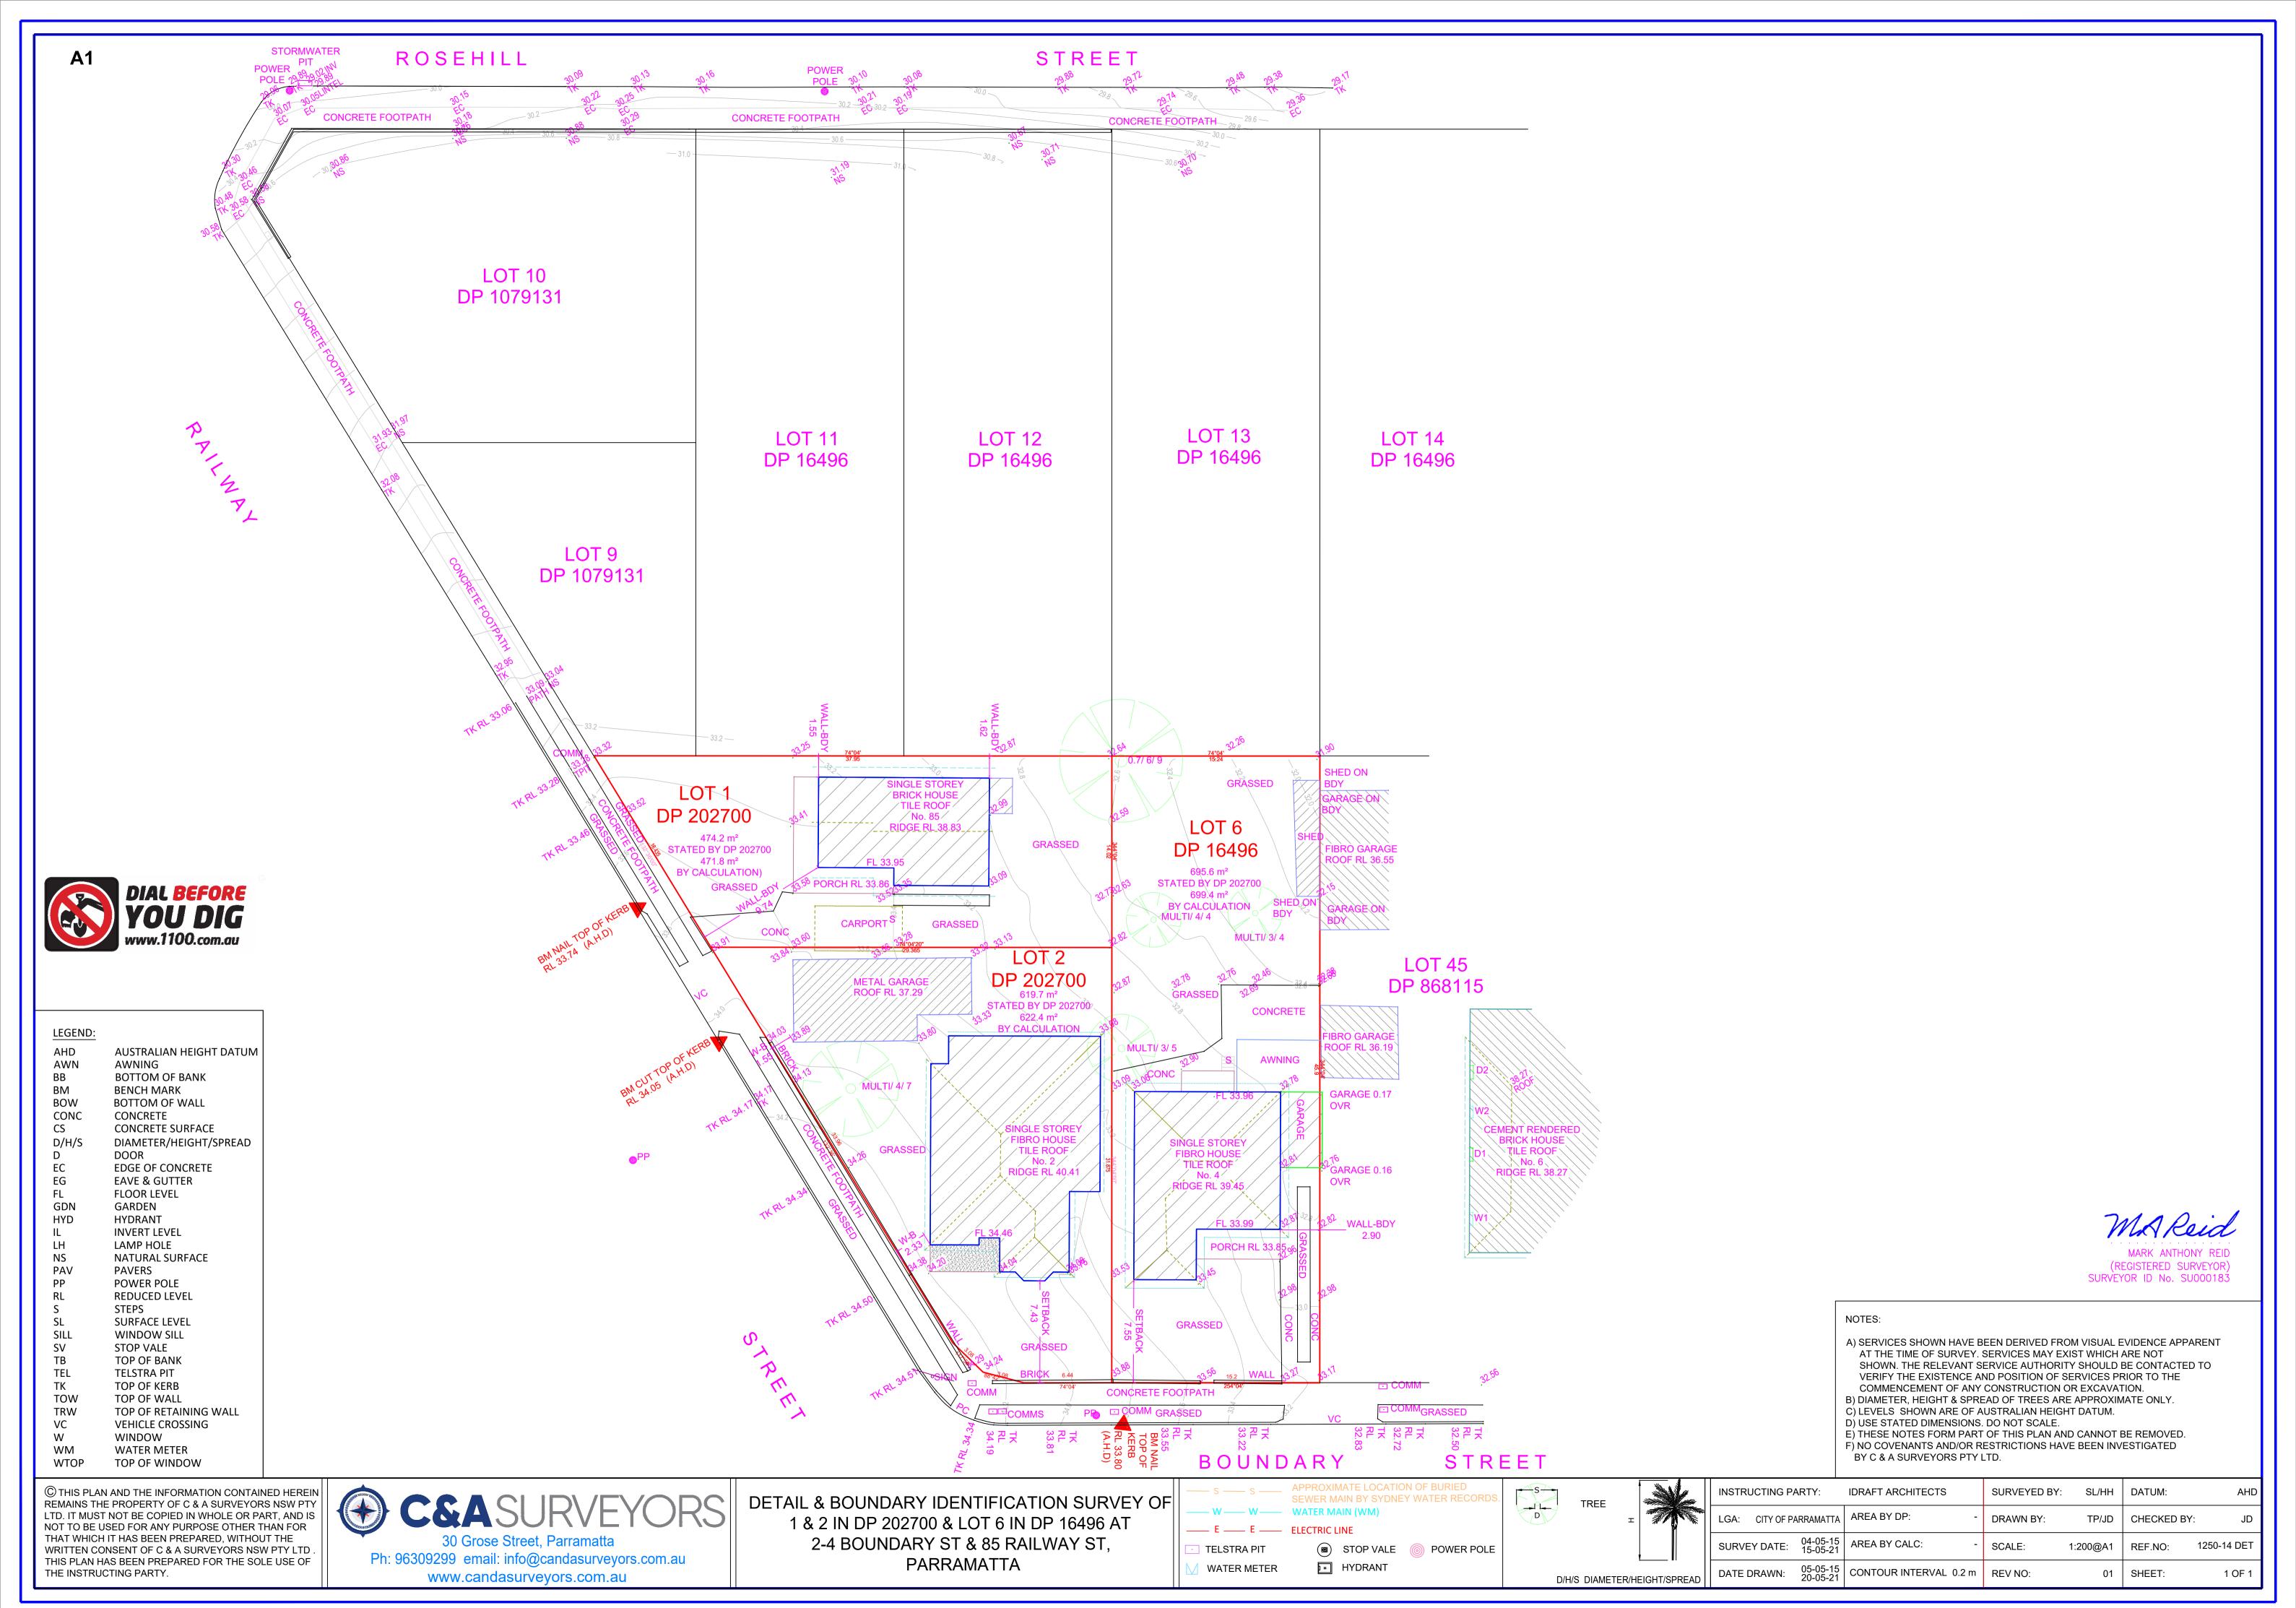







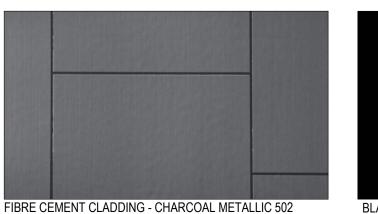





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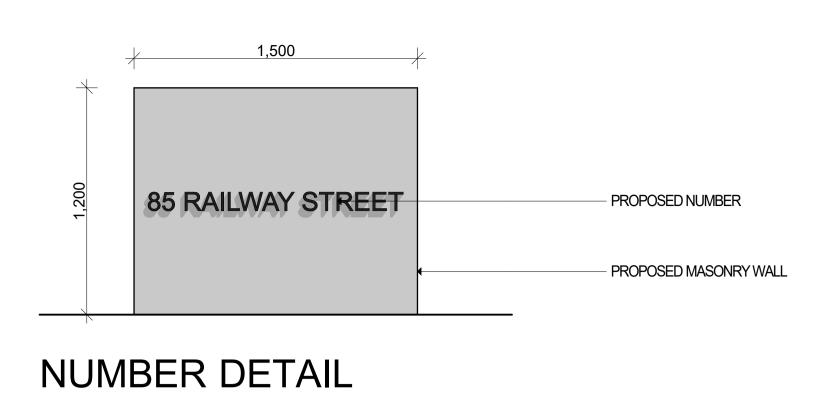
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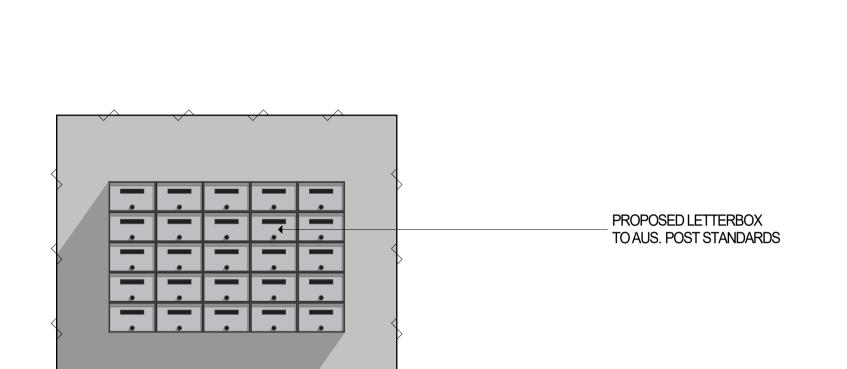
CITY OF PARRAMATTA COUNCIL

**ELEVATIONS** 


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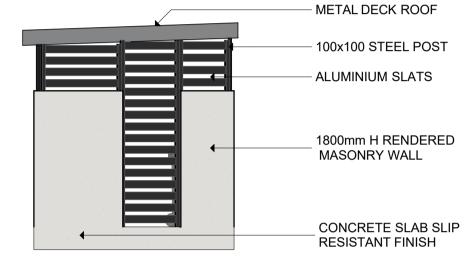






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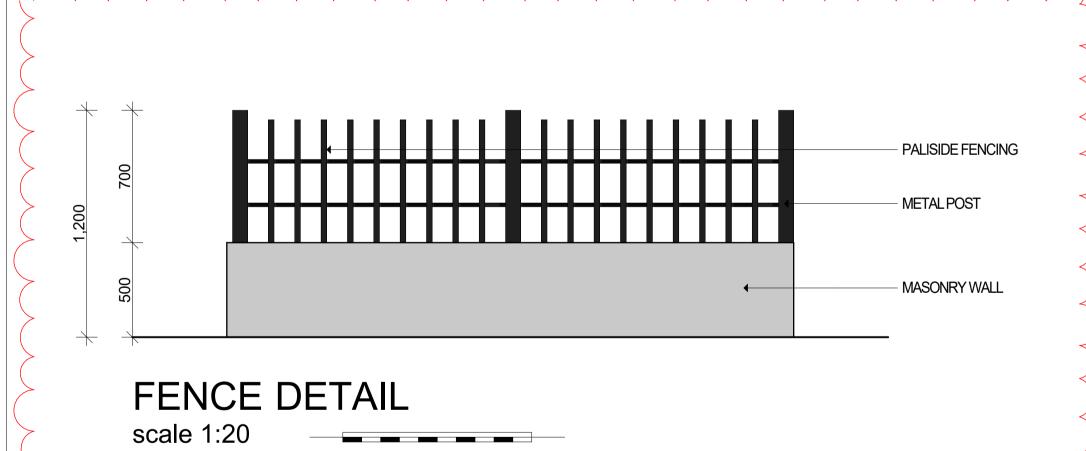


Garbage Bay Detail Elevation scale 1:50

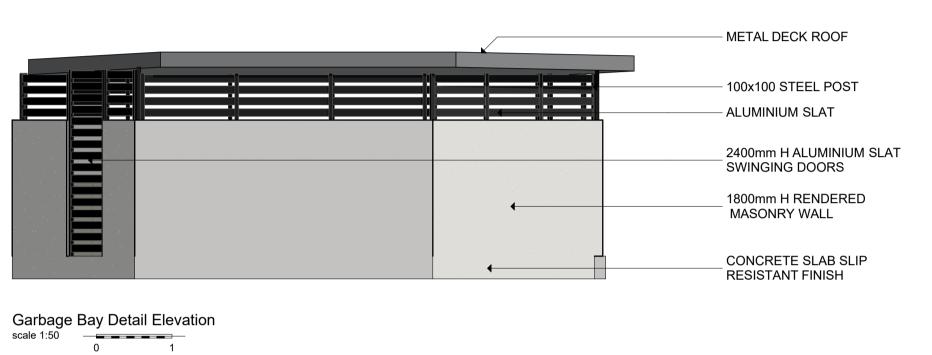
#### LETTERBOX DETAIL

scale 1:20

scale 1:20



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flush toilets cisterns & compliant hot water systems with minimum green house score of 3 stars are to be used in this development. Occupants are encouraged to use AAA rated dish washing machines with front

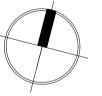DESCRIPTION

to accommodate drainage lines & steel beams positions to be

NSW Architects Registration Board 5347

Phone: 02 9648 8848

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Adriaan Winton

determined on site.

tap on meter.

Unit 43 / 2 Slough Avenue,

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2-4 BOUNDARY ST & 85 RAILWAY ST, PARRMATTA

LOCAL COUNCIL

CITY OF PARRAMATTA COUNCIL

DRAWING DETAILS

PROJECT NUMBER	DATE:	14/09/2
28806	DRAWN BY:	MT
20000	DESIGNED BY	r: AW
	ISSUED FOR:	DA
22		ICCLIE



WINDOW SCHEDUL	.E				
ID	W1	W2	W3	W4	W5
NAME	W Awning 15				
QUANTITY	19	2	31	7	4
HEIGHT	1,800	1,800	1,800	1,800	750
WIDTH	2,400	900	1,200	1,800	2,400
HEAD HEIGHT	2,700	2,700	2,700	2,700	2,700
SILL HEIGHT	900	900	900	900	1,950
PLAN		<u>—</u>			
ELEVATION					

DOOR SCHEDULE									
ID	D1	D2	D3	D4	D5	D6	D7	D8	D9
NAME	D2 Sliding 15	D2 Sliding 15	D2 Sliding 15	D2 Sliding 15	D2 15				
QUANTITY	14	5	1	6	4	11	6	6	1
HEIGHT	2,700	2,700	2,700		2,700	2,700	2,700	2,700	
WIDTH	3,500	2,100	3,200	3,330	2,700	4,000	2,400	3,830	1,700
PLAN	г—— I	<u> </u>	I		ı ————————————————————————————————————		г— <u>—</u> і		
ELEVATION	<b>←</b> -¬		r→	→		r→	r-→		



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BODY (	CORPORATE	NO:	CONSENT NO:				
REV	DATE	DESCRI	PTION	DP NAME	REG N		
	I						



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PROJECT
RESIDENTIAL FLAT BUILDING


ADDRESS
2-4 BOUNDARY ST & 85 RAILWAY ST, PARRMATTA

LOCAL COUNCIL CITY OF PARRAMATTA COUNCIL

DRAWING
WINDOW & DOOR SCHEDULE

PROJECT NUMBER	DATE:	22/12/2021
28806	DRAWN BY:	MT
20000	DESIGNED BY:	AW
	ICCLIED FOR	Β.4



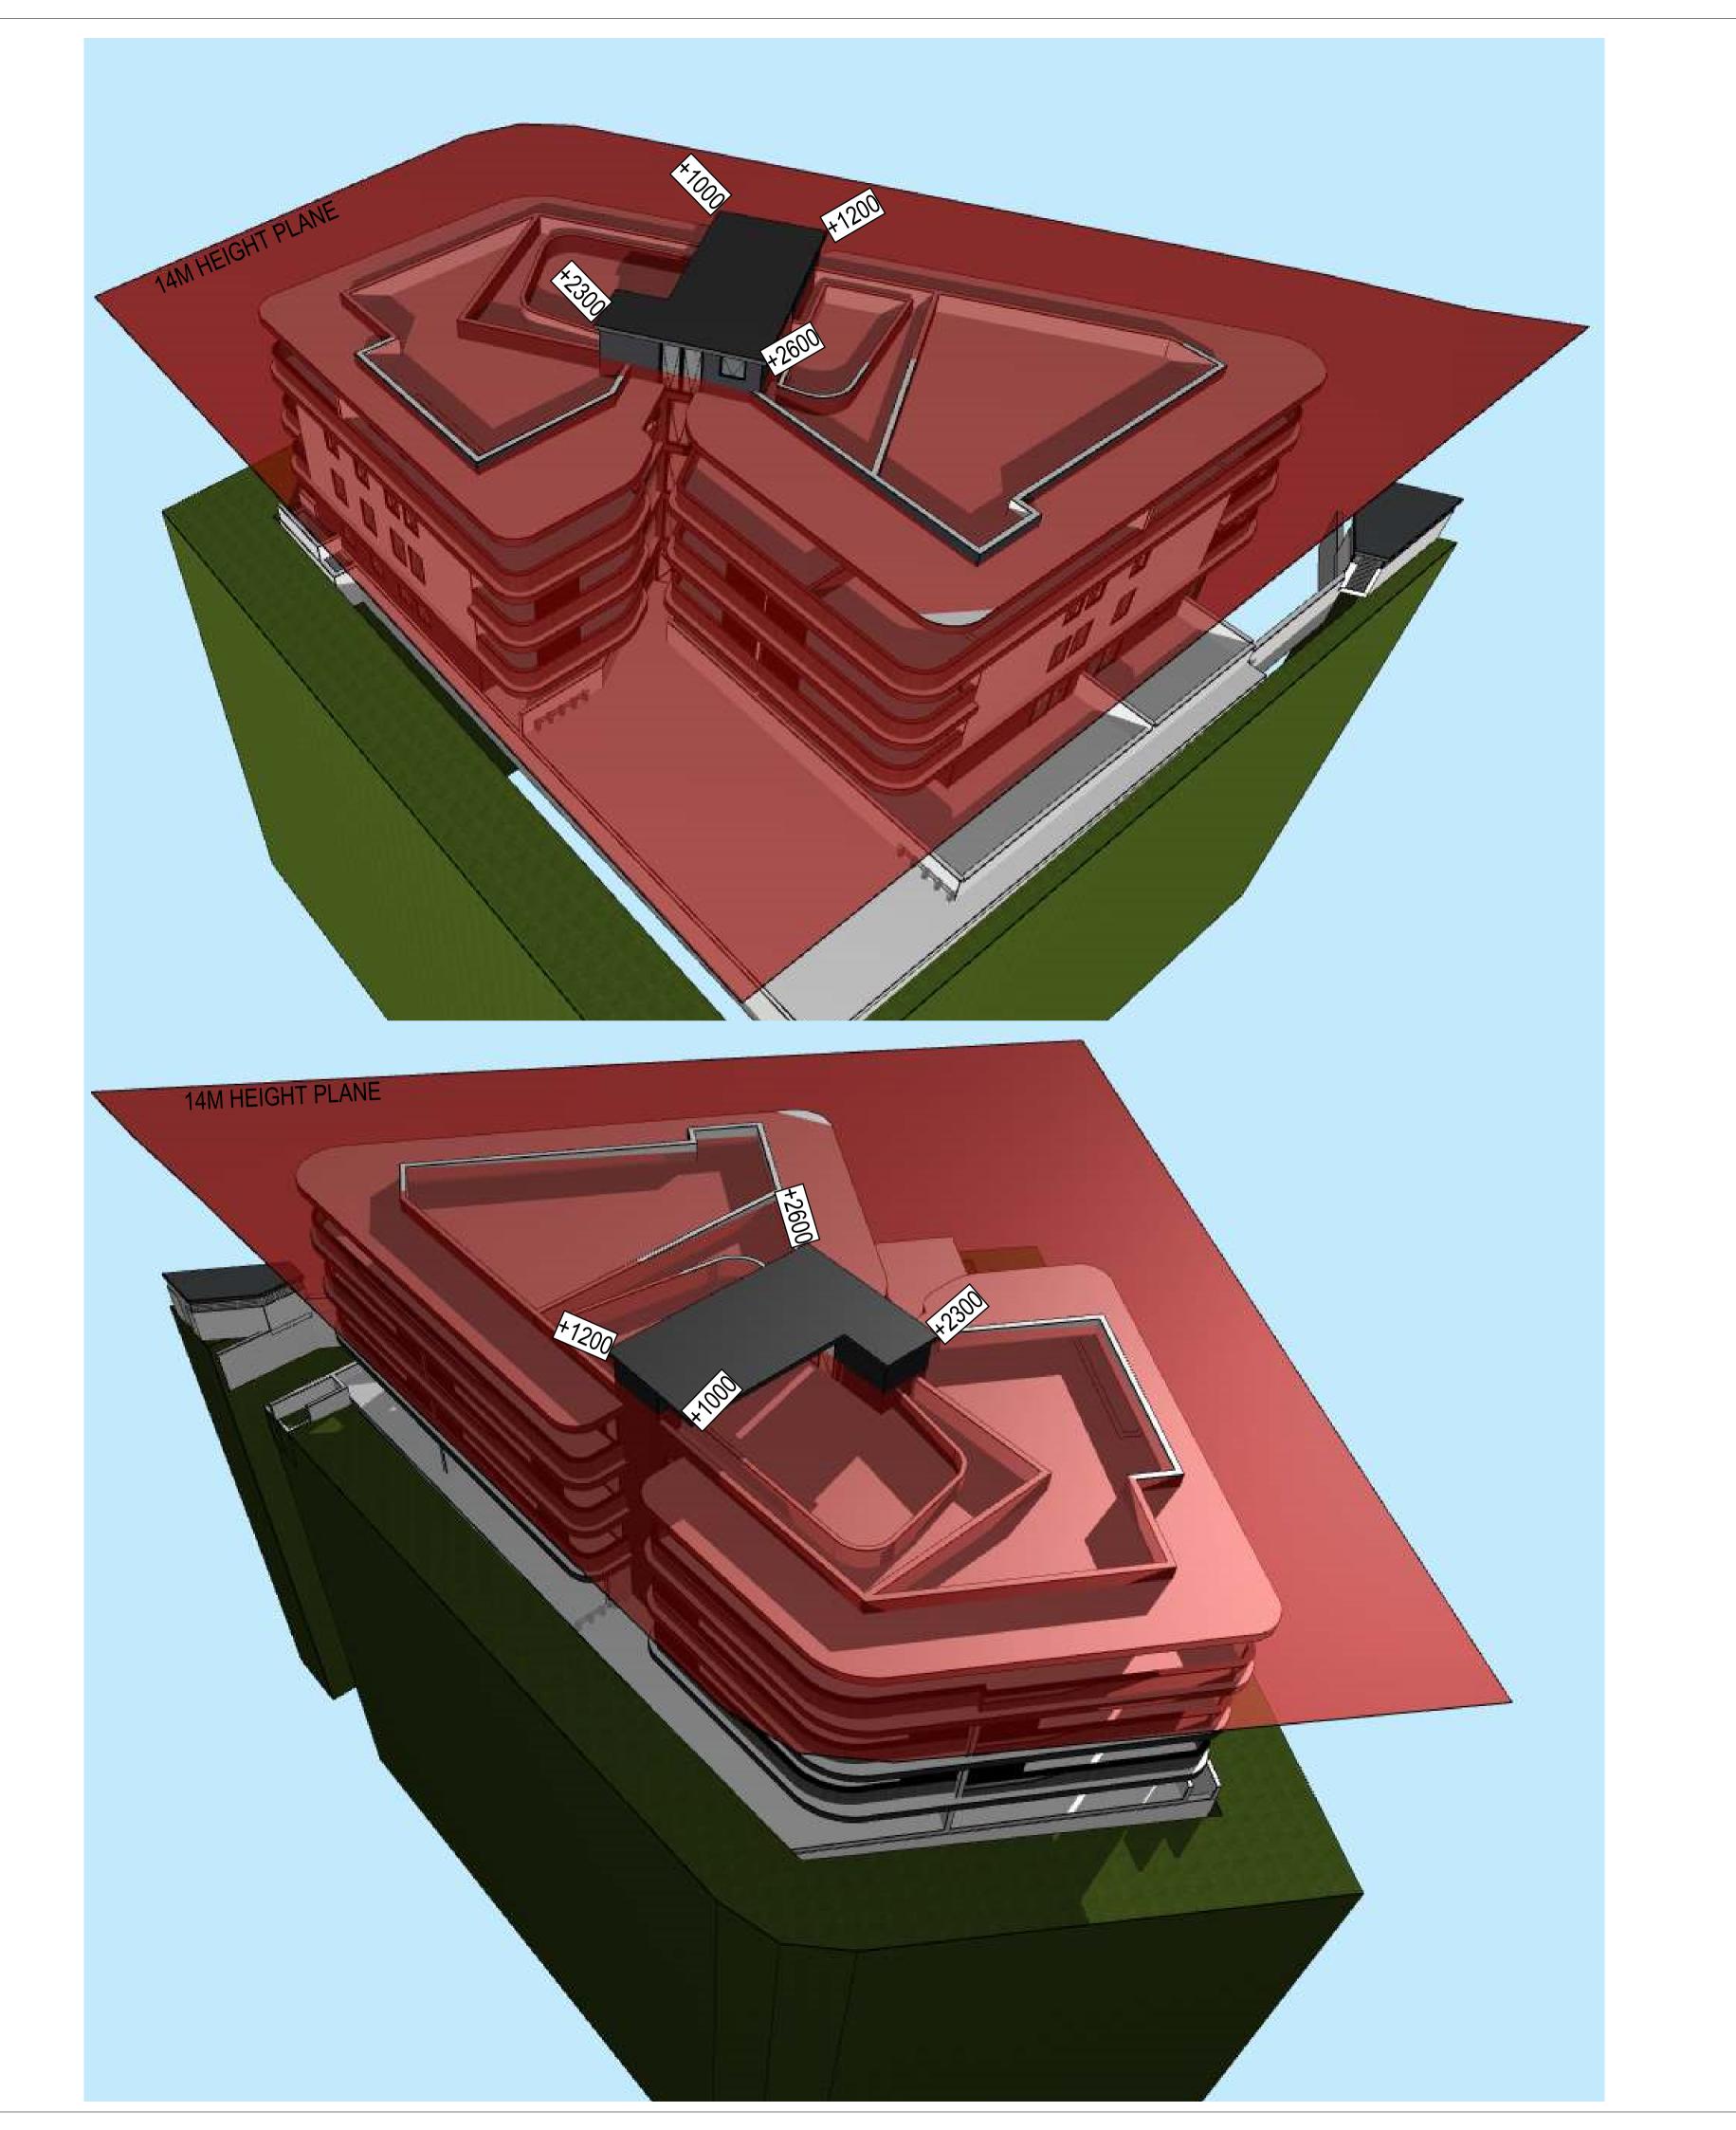



NSW Architects Registration Board 5347 Adriaan Winton Phone: 02 9648 8848

Unit 43 / 2 Slough Avenue, Silverwater, NSW 2128 admin@idraft.com.au www.idraft.com.au

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PROJECT RESIDENTIAL FLAT BUILDING

ADDRESS
2-4 BOUNDARY ST & 85 RAILWAY ST, PARRMATTA

LOCAL COUNCIL CITY OF PARRAMATTA COUNCIL

DRAWING
3D HEIGHT PLANE

PROJECT NUMBER DATE: DRAWN BY: MT DESIGNED BY: AW ISSUED FOR: DA




## SCHEDULE OF FEATURES FOR ADAPTABLE HOUSING


#### ADAPTABLE HOUSE CLASS C


All essential features incorporated.


	DRAWINGS	CLAU	
	Provision of drawings showing the housing unit in its pre-adaption and post-adaption stages SITING		2.3
	A continuous accessible path of travel from street frontage and vehicle parking to entry		
	complying with AS1428.1		3.3.2
	LETTERBOXES IN ESTATE DEVELOPMENTS		
1	Letterboxes to be on hard standing area connected to accessible pathway		3.8
	PRIVATE CAR ACCOMMODATION		
4	Carparking space or garage min. area 6.0m x 3.8m		3.7.2
20	ACCESSIBLE ENTRY Accessible entry	4.3.1	
22	Accessible entry to be level (i.e. max. 1:40 slope)	4.3.1	
23	Threshold to be low-level	4.3.2	
24	Landing to enable wheelchair manoeuvrability		4.3.2
25	Accessible entry door to have 850mm min clearance		4.3.1
27	Door lever handles and hardware to AS 1428.1		4.3.4
	INTERIOR GENERAL		
32	Internal doors to have 820 mm min clearance	427	4.3.3
33 34	Internal corridors min. width of 1000mm  Provision for compliance with AS 1428 1 for door approaces	4.3.7	4.3.7
, -,	Provision for compliance with AS 1428.1 for door approaces  LIVING ROOM & DINING ROOM		т.ט.1
36	Provision for circulation space of min 2250mm diameter		4.7.1
38	Telephone adjacent to GPO		4.7.4
11	Potential illumination level min 300 lux	4.10	
	KITCHEN		
12	Minimum width 2.7m (1550mm clear between bences)		4.5.2
.3	Provision for circulation at doors to comply with AS 1428.1	4.5.1	
4	Provision for benches planned to include at least one worksurface of 800mm length,		155
<b>!</b> 5	adjustable in height from 750mm to 850mm or replaceable. refer to Figure 4.8 Refrigerator adjacent to work surface		4.5.5 4.5.5
16	Kitchen sink adjustable to heights from 750mm to 850mm or replacable		4.5.6
17	Kitchen sink bowl max 150mm deep		4.5.6
48	Tap set capstan or lever handles or lever mixer		4.5.6 (e)
19	Tap set located within 300mm of front of sink		4.5.6 (e)
51	Cooktops to include either front or side controls with raised cross bars		4.5.7
52	Cooktops to include isolationg switch		4.5.7
3	Worksurface min 800mm length adjacent to cooktop at same height		4.5.7
54 59	Oven located adjacent to an adjustable height or replaceable work surface		4.5.8
59 50	GPOs to comply with AS 1428.1. At least one double GPO with 300mm of front of worksurface GPO for refrigerator to be easily reachable when the refrigerator is in its operating position		4.5.11 4.5.11
50 51	Slip-resistant floor surface		4.5.4
	MAIN BEDROOM		
62	At least one bedroom of area sufficient to accommodate queen size bed and wardrobe and		
	circulation space requirements of AS 1428.2		4.6.1
	BATHROOM		
75	Provision for bathroom area to comply with as 1428.1		4.4.1
'6	Slip-resistant floor surface		4.4.2
'7 '8	Shower recess - no hob. Minimum size 1160 x 1100 to comply with AS 1428.1.  Shower area waterproofed to AS 3740 with floor to fall to waste		4.4.4 (f) 4.4.4 (f)
'8 '9	Recessed soap holder	4.4.4 (f)	` '
30	Shower taps positioned for easy reach to access side of shower sliding track	⊤. <b>न.न</b> (I)	4.4.4 (f)
32	Provision for adjustable, detachable hand held shower rose mounted on a slider grabrail or fixed h	ook	\-/
	(plumbing and wall-strengthening provision)		4.4.4 (h)
3	Provision for grabrail in shower to comply with AS 1428.1	4.4.4 (h	•
86	Tap sets to be capstan or lever handles with single outlet	4.4.4 (c	•
88	Provision for washbasin with clearance to comply withAS 1428.1		4.4.4 (g)
90	Double GPO beside mirror		4.4.4 (d)
92	TOILET Provision of either 'visitable toilet' or accessible toilet		4.4.3
)2 )3	Provision to comply with AS 1428.1		4.4.3
94	Location of WC pan at correct distance from fixed walls		4.4.3
)5	Provision for grab rail zone.		4.4.4 (h)
6	Slip resistant floor surface (Vitreous tiles or similar).		4.4.2
	LAUNDRY		
8	Circulation at doors to comply with AS 1428.1		4.8
9	Provision for adequate circulation space in front of or beside appliances (min 1550 mm depth)	4011	4.8
100	Provision for automatic washing machine  Where elethes line is provided an accessible path of travel to this	4.8 (e)	19(0)
102 105	Where clothes line is provided an accessible path of travel to this  Double GPO	4.8 (g)	4.8 (a)
108	Slip-resistant floor surface	-⊤.∪ (y <i>)</i>	4.9.1
. 33	DOOR LOCKS		
	Door hardware operable with one hand, located 900-1100mm above floor.		4.3.

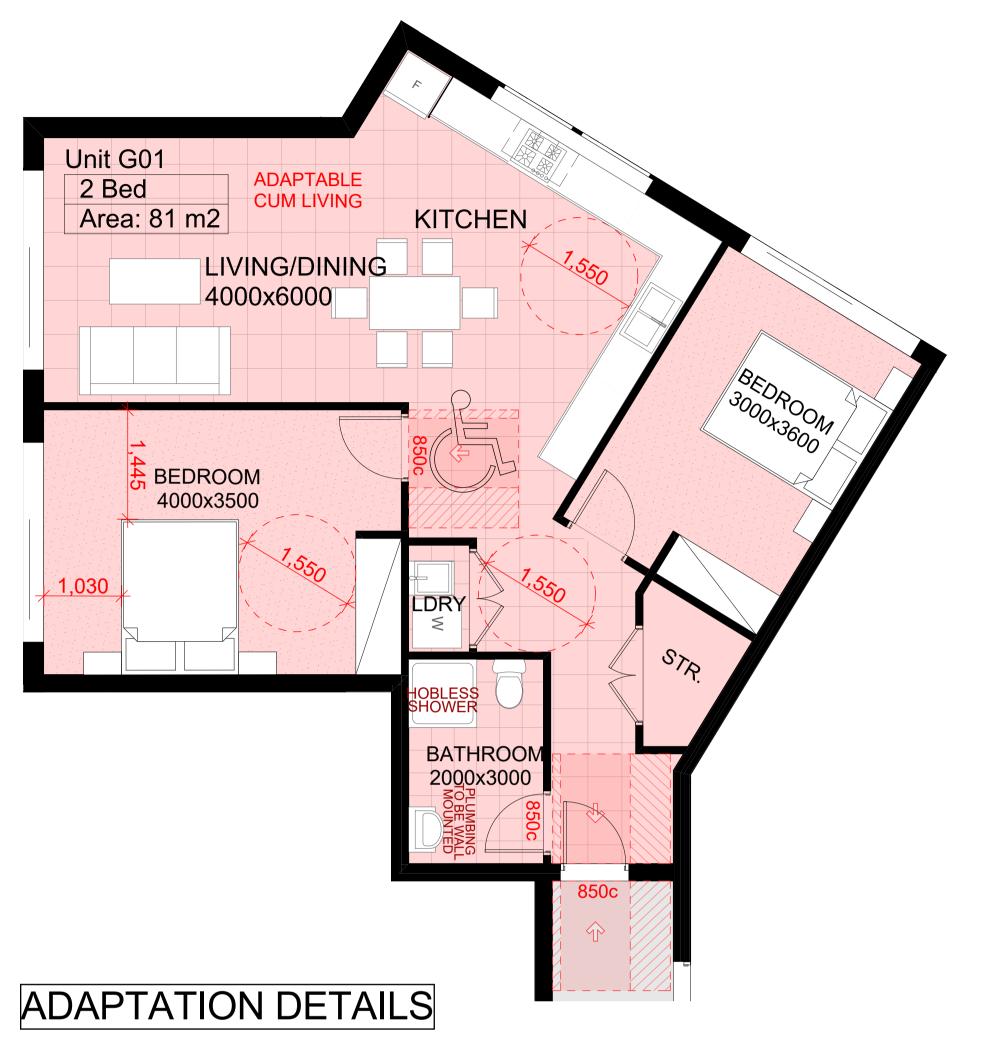



ADAPTABLE UNITS REQUIRED 10% - 2.5 UNITS ADAPTABLE UNITS PROVIDED 10% - 3 UNITS (UNIT G01, UNIT 101, UNIT 201)

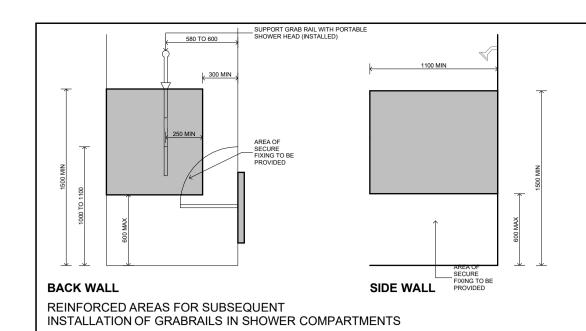

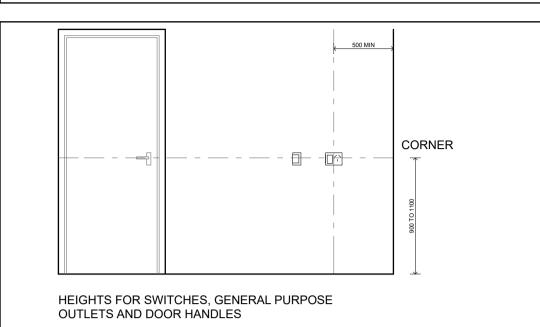

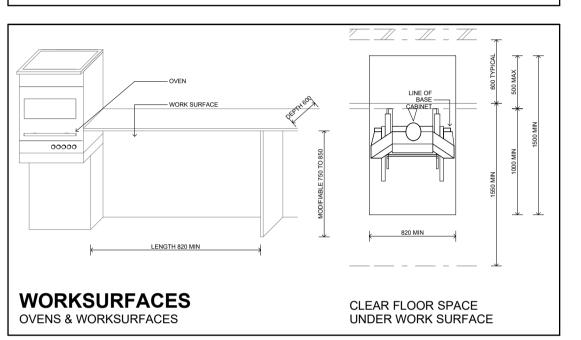

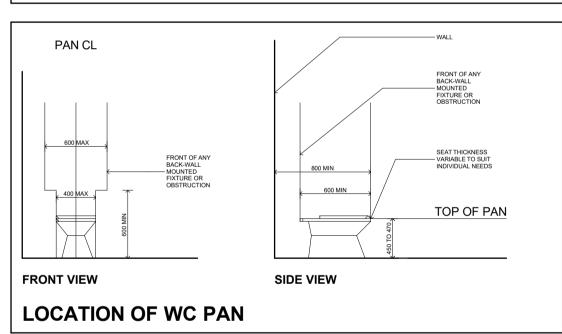

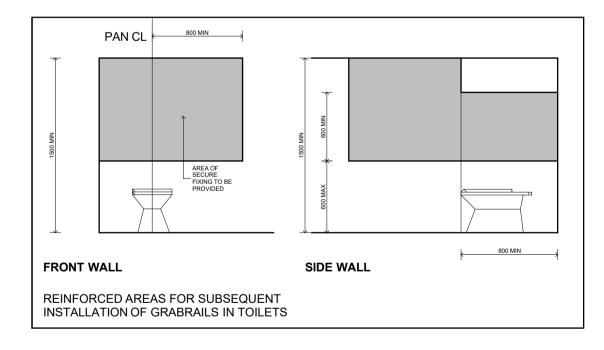



Adriaan Winton NSW Architects Registration Board 5347 Unit 43 / 2 Slough Avenue, Phone: 02 9648 8848 Silverwater, NSW 2128 admin@idraft.com.au www.idraft.com.au

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include rainwater tanks shower heads, water taps flow regulators, dual flush toilets cisterns & compliant hot water systems with minimum green house score of 3 stars are to be used in this development. Occupants are encouraged to use AAA rated dish washing machines with front loading where possible.

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				1	REV	DATE	DESCRIPTION
	$\uparrow$				Α	22/12/2021	SUBMITTED DA TO COUNCIL
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INFINITY IDEAS PTY LTD

RESIDENTIAL FLAT BUILDING

2-4 BOUNDARY ST & 85 RAILWAY ST, PARRMATTA

CITY OF PARRAMATTA COUNCIL

ADAPTION DETAILS

PROJECT NUMBER DRAWN BY: DESIGNED BY: AW ISSUED FOR: DA





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PROJECT
RESIDENTIAL FLAT BUILDING

ADDRESS
2-4 BOUNDARY ST & 85 RAILWAY ST, PARRMATTA

CITY OF PARRAMATTA COUNCIL

DRAWING SOLAR DIAGRAMS

PROJECT NUMBER DRAWN BY: MT DESIGNED BY: AW ISSUED FOR: DA

DRAWING NUMBER

SOLAR ACCESS REQUIRED - 70% SOLAR ACCESS PROVIDED - 76%

19 ROOMS

18 ROOMS





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CITY OF PARRAMATTA COUNCIL

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NSW Architects Registration Board 5347 Phone: 02 9648 8848

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CITY OF PARRAMATTA COUNCIL

DRAWING CROSS VENTILATION DIAGRAMS

PROJECT NUMBER DRAWN BY: MT

DESIGNED BY: AW

DRAWING NUMBER

15 ROOMS

19 ROOMS

CROSS VENT REQUIRED - 60%

CROSS VENT PROVIDED - 76%

ISSUED FOR: DA





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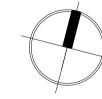
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ADDRESS
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PARRMATTA

CITY OF PARRAMATTA COUNCIL

DRAWING CROSS VENTILATION DIAGRAMS

15 ROOMS

CROSS VENT REQUIRED - 60%

CROSS VENT PROVIDED - 76%

PROJECT NUMBER DRAWN BY: MT DESIGNED BY: AW ISSUED FOR: DA

19 ROOMS DRAWING NUMBER





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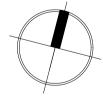
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	AMENDMENTS						
REV	DATE	DESCRIPTION					
Α	22/12/2021	SUBMITTED DA TO COUNCIL					
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ADDRESS
2-4 BOUNDARY ST & 85 RAILWAY ST,
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LOCAL COUNCIL CITY OF PARRAMATTA COUNCIL

DRAWING STRATA PLAN

PROJECT NUMBER DATE: DRAWN BY: MT DESIGNED BY: AW ISSUED FOR: DA

DRAWING NUMBER 4007

В





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В	22/06/2022	SUBMITTED ADDITIONAL INFORMATION					

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LOCAL COUNCIL CITY OF PARRAMATTA COUNCIL

DRAWING STRATA PLAN

PROJECT NUMBER	DATE:	22/06/2022
28806	DRAWN BY:	MT
20000	DESIGNED BY:	AW
	ISSUED FOR:	DA



# 2-4 BOUNDARY STREET & 85 RAILWAY STREET, PARRAMATTA PROPOSED RESIDENTIAL DEVELOPMENT

STORMWATER CONCEPT PLANS



### LOCALITY PLAN

DRAWING INDEX						
Drawing No.	DESCRIPTION					
000	COVER SHEET PLAN					
101	STORMWATER CONCEPT PLAN BASEMENT LEVEL SHEET 1 OF 2					
102	STORMWATER CONCEPT PLAN BASEMENT LEVEL SHEET 2 OF 2					
103	STORMWATER CONCEPT PLAN					
104	SITE PLAN					
105	WSUD CATCHMENT PLAN					
106	OSD & WSUD DETAILS & CALCULATIONS SHEET 1 OF 2					
107	OSD & WSUD DETAILS & CALCULATIONS SHEET 2 OF 2					
108	MISCELLANEOUS DETAILS SHEET					

NOT FOR CONSTRUCTION

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В	COUNCIL COMMENTS	21/06/2022	AGN	JSF	
Α	ISSUE FOR DEVELOPMENT APPLICATION	20/12/2021	JTF	JSF	
ssue	Description	Date	Design	Checked	
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d All

Architect
Idraft Architecs
Pty Ltd
Unit 43,2 Slough Avenue,
Silverwater NSW 2128
PHONE: 02 9648 8848
Email:pierre@idraft.com.au
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City of Parramatta
Council

Level 4, 470 Church Street,
Parramatta NSW 2150
PO BOX 3579 Parramatta 2124

Parramatta NSW 2150
PO BOX 3579 Parramatta 2124


Possible Company: Telford Consulting Pty Ltd

2-4 BOUNDARY STREET &
85 RAILWAY STREET, PARRAMATTA
PROPOSED RESIDENTIAL DEVELOPMENT
STORMWATER CONCEPT PLANS
DEVELOPMENT APPLICATION

COVER SHEET PLAN

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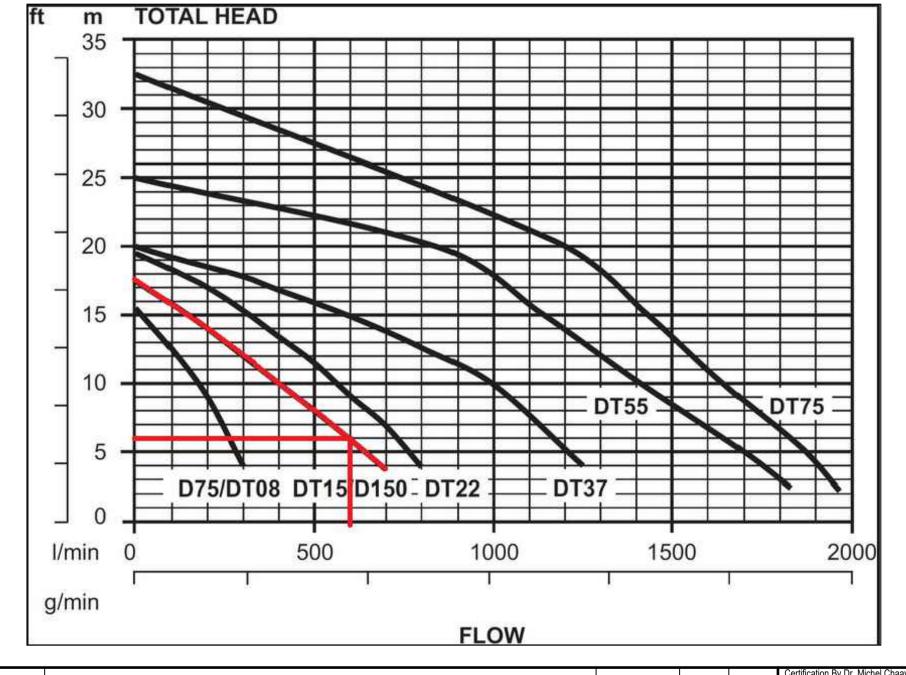
# CLASS C (HEAVY DUTY) HEEL PROOF HINGED GALVANIZED MILD STEEL GRATE FRAME FITTED WITH CHILDPROOF LOCKING DEVICES CLASS C (HEAVY DUTY) HEEL PROOF HINGED GALVANIZED MILD STEEL GRATE FRAME FITTED WITH CHILDPROOF LOCKING DEVICES NOTE: 1- FOR ALL THE STRUCTURAL DETAILS, REFER TO STRUCTURAL ENGINEER'S PLAN


FOR ALL THE STRUCTURAL
DETAILS, REFER TO
STRUCTURAL ENGINEER'S PLAN.
ALL THE AG LINES BEHIND
BASEMENT WALLS TO BE
CONNECTED TO PUMP-OUT SUMF
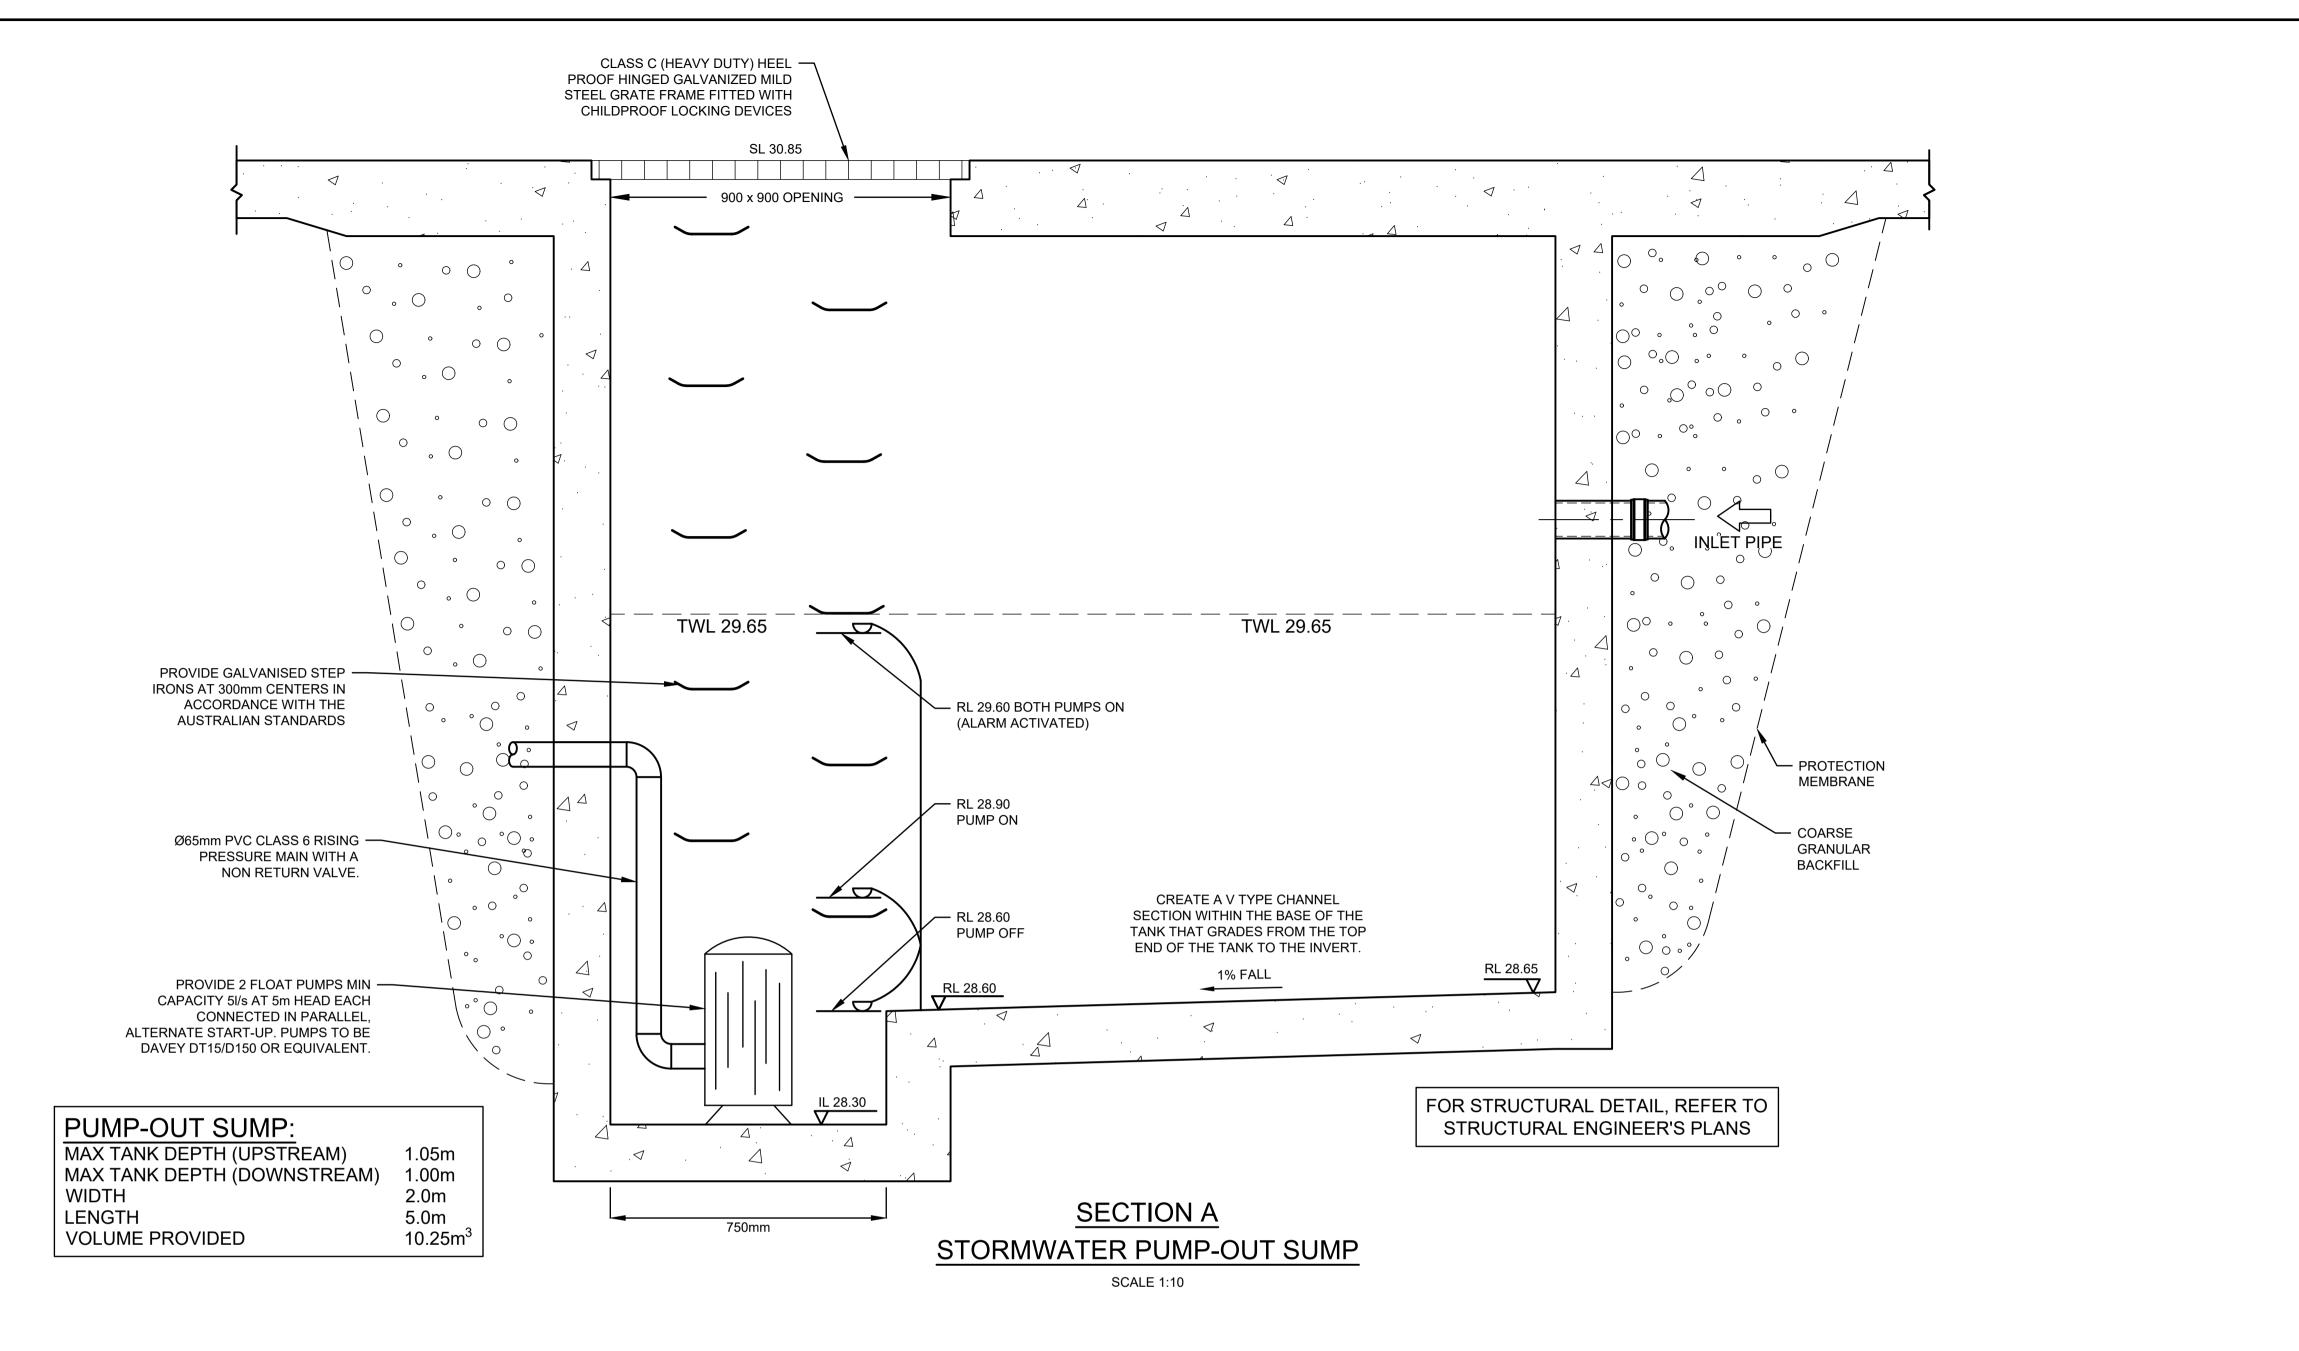
# PUMP-OUT SUMP DETAIL PLAN VIEW

# PUMP STORAGE VOLUME CALCULATION

- $I_{100, 3hours} = 47.1 \text{ mm/hour}$
- PUMP STORAGE CATCHMENT AREA: A = 86.9 m<sup>2</sup> = 0.00869 ha
- Q = C x I x A / 360 WHERE C = 1.0 (REFER TO AS3500.3.5.4.6 (a))
  - = 1.0 x 47.1 x 0.00869 / 360 = 0.00137 m<sup>3</sup>/s
- = 1.137 L/s
- THEREFORE, THE PUMP HOLDING TANK VOLUME IS:
- $V = 0.001137 \times 2 \times 3600$
- = 8.186 m<sup>3</sup>
   TOTAL REQUIRED VOLUME IS 8.186m<sup>3</sup>
- TOTAL REQUIRED VOLUME IS 8.1861 TOTAL PROVIDED VOLUME IS 10.25m<sup>3</sup>



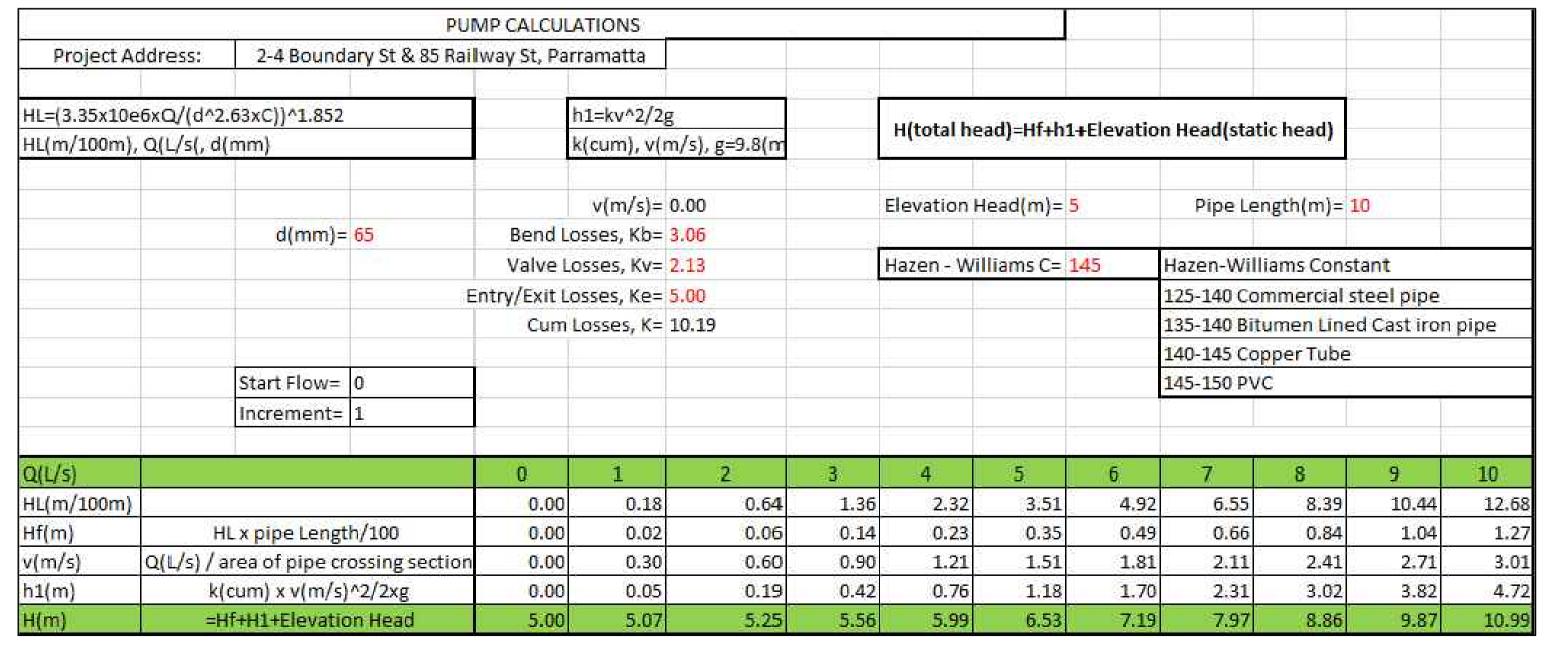

# UNDERGROUND PUMP - OUT SUMP STAGED STORAGE CALCULATIONS

DEPTH (mm)	AREA (m²)	CUMULATIVE VOLUME (m³)
0	10.00	0
100	10.00	0.75
200	10.00	1.75
300	10.00	2.75
400	10.00	.3.75
500	10.00	4.75
600	10.00	5.75
700	10.00	6.75
800	10.00	7.75
900	10.00	8.75
1000	10.00	9.75
1050	10.00	10.25

NOT FOR CONSTRUCTION

| Certification | Certificatio

F Ked

Architect
Idraft Architecs
Pty Ltd
Unit 43,2 Slough Avenue,
Silverwater NSW 2128
PHONE: 02 9648 8848
Email:pierre@idraft.com.au
www.idraft.com.au
www.idraft.com.au

Scale

0 200 400 600mm

SCALE 1:10 @ A1

0 1 2 3 m

SCALE 1:50 @ A1

Level 4, 470 Church Street,
Parramatta NSW 2150
PO BOX 3579 Parramatta 2124

Parramatta Parramatta 2124


Parramatta Parramatta 2124

Phone: 02 7809 4931

Company: Telford Consulting Pty Ltd

2-4 BOUNDARY STREET &
85 RAILWAY STREET, PARRAMATTA
PROPOSED RESIDENTIAL DEVELOPMENT
STORMWATER CONCEPT PLANS
DEVELOPMENT APPLICATION

STORMWATER CONCEPT PLAN
BASEMENT LEVEL

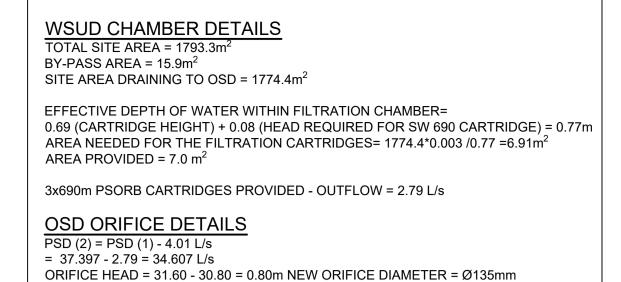

#### **ORIFICE CALCULATIONS:** $Q = C \times A \times (2 \times g \times h)^{0.5}$ SO: $A = Q / (C \times sqrt(2 \times g \times h))$ $= 0.034607 / (0.61 \times \text{sqrt}(2 \times 9.81 \times 0.80))$ $= 0.01432 \text{ m}^2$ THEREFORE: $= sqrt(4 \times A / pi)$ $= sqrt(4 \times 0.01432 / 3.14159)$

= 135 mm

#### **GENERAL NOTES**

- 1. INLET AND OUTLET PIPING SHALL BE SPECIFIED BY SITE CIVIL ENGINEER (SEE PLANS) AND PROVIDED BY CONTRACTOR. STORMFILTER IS PROVIDED WITH OPENINGS AT INLET AND OUTLET LOCATIONS.
- 2. IF THE PEAK FLOW RATE, AS DETERMINED BY THE SITE CIVIL ENGINEER, EXCEEDS THE PEAK HYDRAULIC CAPACITY OF THE PRODUCT, AN UPSTREAM BYPASS STRUCTURE IS REQUIRED. PLEASE CONTACT STORMWATER360 FOR OPTIONS.
- 3. THE FILTER CARTRIDGE(S) ARE SIPHON-ACTUATED AND SELF-CLEANING. THE STANDARD DETAIL DRAWING SHOWS THE MAXIMUM NUMBER OF CARTRIDGES. THE ACTUAL NUMBER SHALL BE SPECIFIED BY THE SITE CIVIL ENGINEER ON SITE PLANS OR IN DATA TABLE BELOW. PRECAST STRUCTURE TO BE CONSTRUCTED IN ACCORDANCE WITH AS3600.
- 4. FOR SHALLOW, LOW DROP OR SPECIAL DESIGN CONSTRAINTS, CONTACT STORMWATER360 FOR DESIGN OPTIONS.
- 5. ALL WATER QUALITY PRODUCTS REQUIRE PERIODIC MAINTENANCE AS OUTLINED IN THE O&M GUIDELINES. PROVIDE MINIMUM CLEARANCE FOR MAINTENANCE ACCESS.
- 6. STRUCTURE AND ACCESS COVERS DESIGNED TO MEET AUSTROADS T44 LOAD RATING WITH 0-2m FILL MAXIMUM.
- 7. THE STRUCTURE THICKNESSES SHOWN ARE FOR REPRESENTATIONAL PURPOSES AND VARY REGIONALLY
- 8. ANY BACKFILL DEPTH, SUB-BASE, AND OR ANTI-FLOTATION
- PROVISIONS ARE SITE-SPECIFIC DESIGN CONSIDERATIONS AND SHALL BE SPECIFIED BY SITE CIVIL ENGINEER.


SYSTEM HYDRAULIC DROP

CARTRIDGE FLOW RATE


STORMFILTER CARTRIDGE


FILTRATION UNIT

9.. STORMFILTER BY STORMWATER360: SYDNEY (AU) PHONE: (02) 9525 5833, BRISBANE (AU) PHONE: (07) 3272 1872.

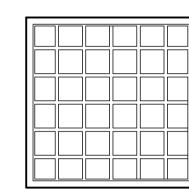

900 x 900 ACCESS COVER

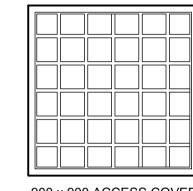

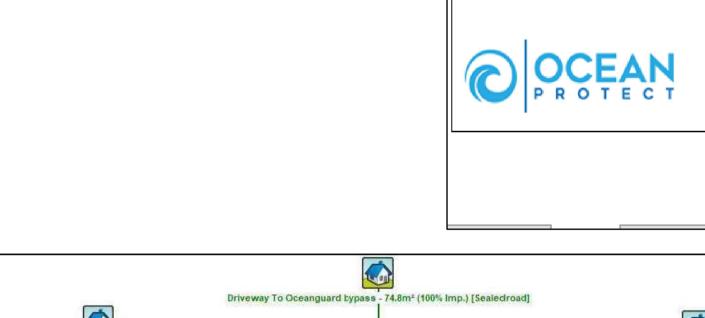

CITY OF PARRAMATTA COUNCIL

**On-Site Detention Calculation Sheet** 

2-4 Boundary St & 85 Railway St, Parramatta DP No. 202700

**UPRCT** 

0.179

38.56

42.14

0.171

95.22

225.79

219.05

37.40 0.800

37.397

0.700

34.982

36.189

211.930

232

39.63

Joe Frangie

101-107

where d = Restrictor Disc Diameter

The equation below defines the relationship between the diameter of the orifice plate,

StormFilter Flow Calculator - Psorb Media

Q = (0.111d^2.06h^0.5)/60

21-Jun-22

41.45 105%

D.A. No.

NOTE:

TWL

USE 135mm ORIFICE

DIAMETER. REFER TO

ORIFICE CALCULATIONS

TEL2021316.SW.DA

Albert Nasseh

02 7809 4931

Location:

Designer:

OSD Area: Front Lot

Basic Storage Volume

Area of Site to Storage

Volume/PSD Adjustment

Calculated Orifice Diameter

Head for high early discharge

Average Discharge per Hectare

Maximum discharge

High Early Discharge

Final Site Storage Ratio

Site Storage Volume

Volume Provided

Checked By:

Cartridge Name

Total Q at head

Δh (m)

Cartridge Quantity

Date Checked:

OSD Plan Number:

the flow rate through the cartridge and head.

∆h = head

0.82

2.79

Mean Discharge

Storage per ha of contributing area

Maximum Head to Orifice Centre


Basic Discharge

Percentage of Site

PSD for site

Phone:

Site Area

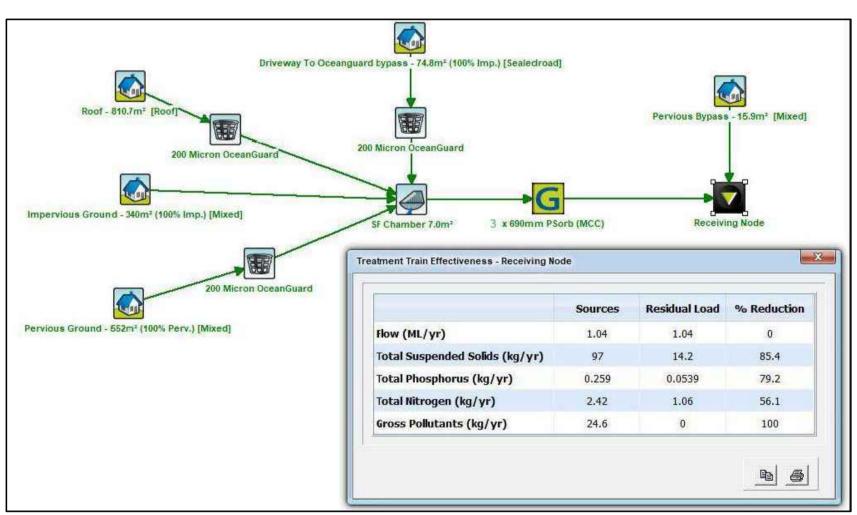

MUSIC MODEL & RESULTS

#### STORMFILTER DESIGN TABLE

- STORMFILTER TREATMENT CAPACITY VARIES BY NUMBER OF FILTER CARTRIDGES INSTALLED AND BY REGION SPECIFIC INTERNAL FLOW CONTROLS. CONVEYANCE CAPACITY IS RATED AT 80L/S.
- ALL PARTS PROVIDED AND INTERNAL ASSEMBLY BY STORMWATER360 AUSTRALIA UNLESS OTHERWISE NOTED.

CARTRIDGE HEIGHT
SYSTEM HYDRAULIC DROP
TREATMENT BY MEDIA SURFACE AREA L/S/m2
CARTRIDGE FLOW RATE

Email : info@telfordcivil.com.au Phone: 02 7809 4931

2-4 BOUNDARY STREET & 85 RAILWAY STREET, PARRAMATTA PROPOSED RESIDENTIAL DEVELOPMEN STORMWATER CONCEPT PLANS **DEVELOPMENT APPLICATION** As Shown

UNDERGROUND OSD/WSUD TANK DETAIL

**PLAN VIEW** 

SCALE 1:25

OSD & WSUD DETAILS & CALCULATIONS SHEET 1 OF 2

2021316

NOT FOR CONSTRUCTION

106

CLASS A (LIGHT DUTY) HEEL

PROOF HINGED GALVANIZED MILD STEEL GRATE FRAME FITTED WITH SECURITY LOCKING DEVICES

**OUTLET PIPE** 

IL 30.68

0.9m

3mm S.S ORIFICE PLATE

OSD WEIR RL 31.60

OSD WEIR RL 31.50

**EPOXY & DYNABOLTED TO PIT** 

WALL WITH MACHINED ORIFICE

CLASS A (LIGHT DUTY) HEEL PROOF HINGED GALVANIZED MILD

SECURITY LOCKING DEVICES

STEEL GRATE FRAME FITTED WITH

**INLET PIPE** 

INLET PIPE

STORMFILTER

CARTRIDGE FILTRATION UNIT

STORMFILTER

CARTRIDGE DETAIL

CLASS A (LIGHT DUTY) HEEL

SECURITY LOCKING DEVICES

A. A. A. A. A.

TO SOFFIT

WSUD WEIR RL 31.72 —

OSD

STORAGE

OSD

STORAGE

PROOF HINGED GALVANIZED MILD

STEEL GRATE FRAME FITTED WITH

2.85m

**TREATMENT** 


**CHAMBER** 

0 0.2 0.4 0.6 0.8 1.0 1.2m SCALE 1:25 @ A1 Level 4, 470 Church Street, Parramatta NSW 2150 PO BOX 3579 Parramatta 2124 Company: Telford Consulting Pty Ltd

COUNCIL COMMENTS 21/06/2022 | AGN | JSF ISSUE FOR DEVELOPMENT APPLICATION JTF | JSF 20/12/2021 Issue Description Date Design Checked





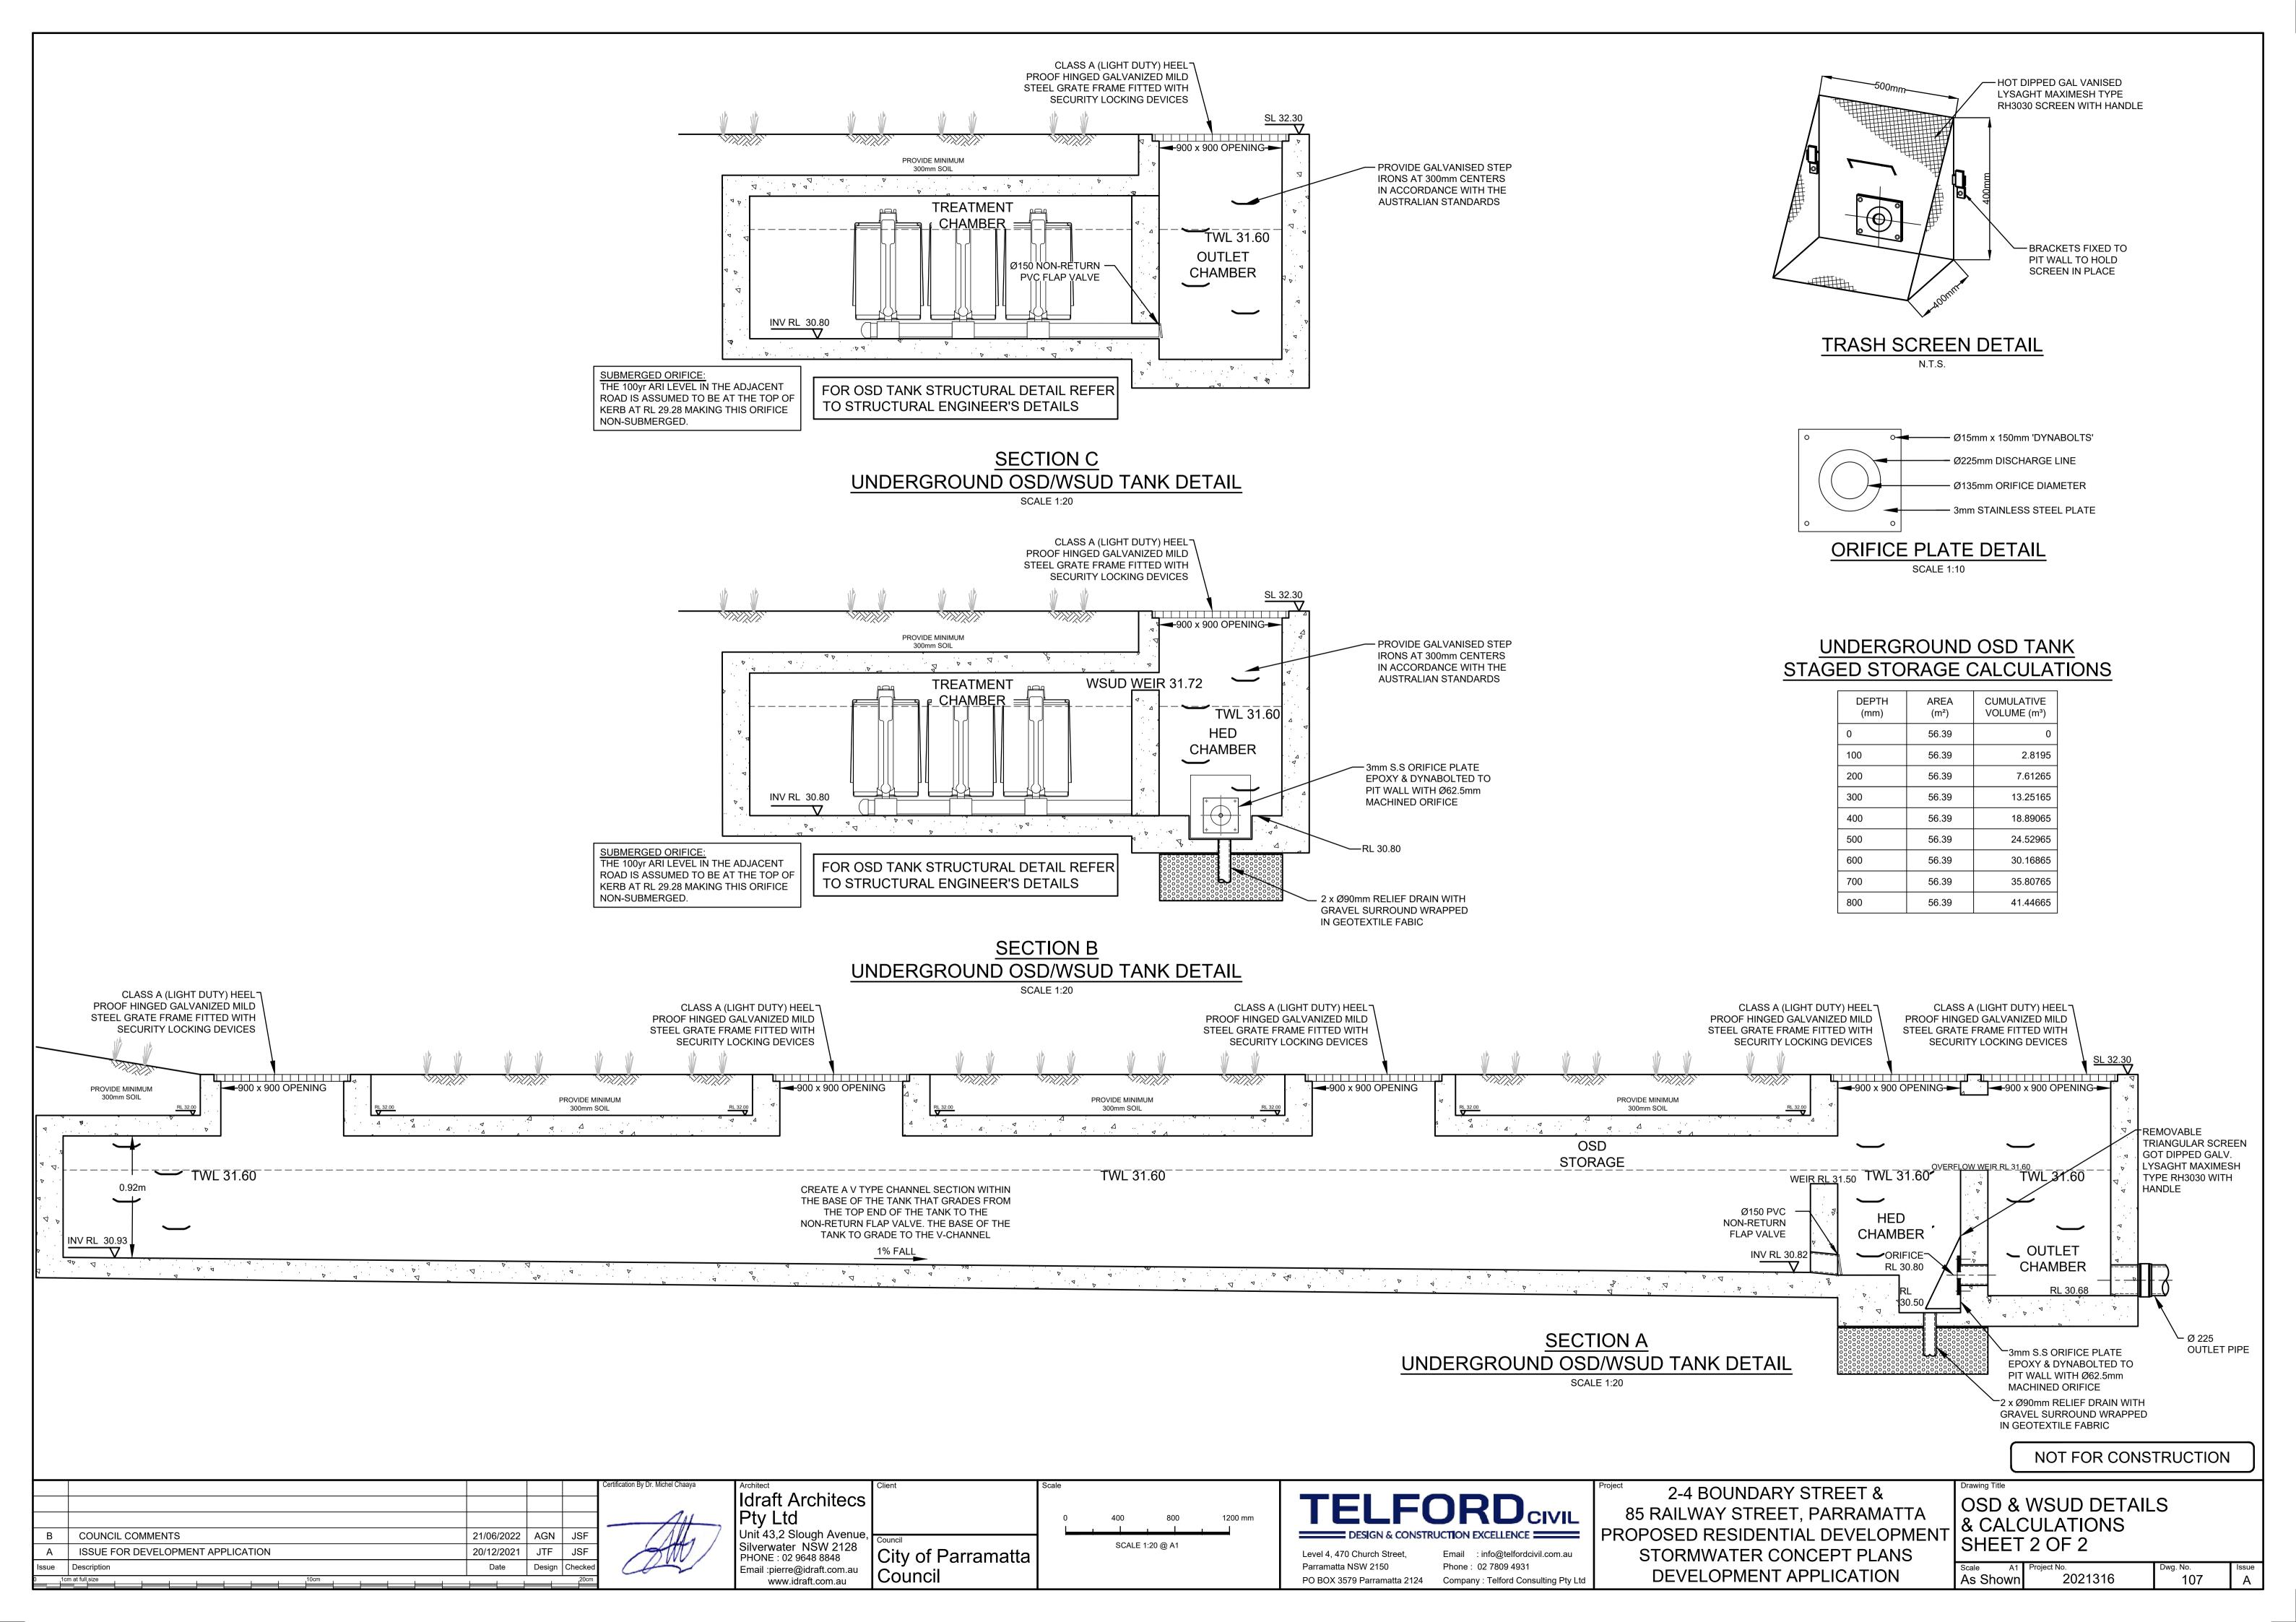


#### SEDIMENT & EROSION NOTES

- I. IMMEDIATELY FOLLOWING SETTING OUT OF THE WORKS, BUT PRIOR TO COMMENCEMENT OF ANY CLEARING OR EARTHWORKS, THE CONTRACTOR AND SUPERINTENDENT SHALL WALK THE SITE TO NOMINATE THE LOCATIONS AND TYPES OF SEDIMENT AND EROSION CONTROL MEASURES TO BE ADOPTED. THESE MEASURES SHALL BE IMPLEMENTED PRIOR TO ANY CLEARING OR EARTHWORKS AND MAINTAINED UNTIL THE WORKS ARE COMPLETED AND NO LONGER POSE AN EROSION HAZARD,
- UNLESS OTHERWISE APPROVED BY THE SUPERINTENDENT.

  2. IMMEDIATELY FOLLOWING SETTING OUT OF THE WORKS, BUT PRIOR TO COMMENCEMENT OF ANY CLEARING OR EARTHWORKS, THE CONTRACTOR AND SUPERINTENDENT SHALL WALK THE SITE TO IDENTIFY AND MARK TREES WHICH ARE TO BE PRESERVED. NOTWITHSTANDING THE ABOVE, THE CONTRACTOR SHALL TAKE ALL REASONABLE PRECAUTIONS TO MINIMISE DISTURBANCE TO EXISTING VEGETATION AND GROUND COVER OUTSIDE THE MINIMUM AREAS REQUIRED TO COMPLETE THE WORKS AND SHALL BE RESPONSIBLE FOR RECTIFICATION, AT ITS OWN COST, OF ANY DISTURBANCE BEYOND THOSE AREAS.
- 3. PROVIDE GULLY GRATE INLET SEDIMENT TRAPS AT ALL GULLY PITS.
- 4. PROVIDE SILT FENCING ALONG PROPERTY LINE AS DIRECTED BY SUPERINTENDENT.
- 5. ADDITIONAL CONTROL DEVICES TO BE PLACED WHERE DIRECTED BY THE PRINCIPLE.
- 6. ALTERNATIVE DESIGNS TO BE APPROVED BY SUPERINTENDENT PRIOR TO CONSTRUCTION.
- 7. WASH DOWN/RUMBLE AREA TO BE CONSTRUCTED WITH PROVISIONS RESTRICTING ALL SILT AND TRAFFICKED DEBRIS FROM ENTERING THE STORMWATER SYSTEM.
- 8. NO WORK OR STOCKPILING OF MATERIALS TO BE PLACED OUTSIDE OF SITE WORK
- 9. APPROPRIATE EROSION AND SEDIMENT CONTROLS TO BE USED TO PROTECT
- STOCKPILES AND MAINTAINED THROUGH OUT CONSTRUCTION.


  10. IT IS THE CONTRACTORS RESPONSIBILITY TO TAKE DUE CARE OF NATURAL
- VEGETATION. NO CLEARING IS TO BE UNDERTAKEN WITHOUT PRIOR APPROVAL FROM THE SUPERINTENDENT.
- 11. TO AVOID DISTURBANCE TO EXISTING TREES, EARTHWORKS WILL BE MODIFIED AS DIRECTED ON-SITE BY THE SUPERINTENDENT.
  12. THE LOCATION OF EROSION AND SEDIMENTATION CONTROLS WILL BE DETERMINED ON
- SITE BY THE SUPERINTENDENT.

  13. ACCESS TRACKS THROUGH THE SITE WILL BE LIMITED TO THOSE DETERMINED BY THE
- SUPERINTENDENT AND THE CONTRACTOR PRIOR TO ANY WORK COMMENCING.
- 14. ALL SETTING OUT IS THE RESPONSIBILITY OF THE CONTRACTOR PRIOR TO WORKS COMMENCING ON SITE. THE SUPERINTENDENT'S SURVEYOR SHALL PEG ALL ALLOTMENT BOUNDARIES, PROVIDE COORDINATE INFORMATION TO THESE PEGS AND PLACE BENCH MARKS. THE CONTRACTOR SHALL SET OUT THE WORKS FROM AND MAINTAIN THESE PEGS.
- 15. PLANS ARE MINIMUM REQUIREMENTS AND ARE TO BE USED AS A GUIDE ONLY. EXACT MEASURES USED SHALL BE DETERMINED ON SITE IN CONJUNCTION WITH PROGRAM OF CONTRACTORS WORKS etc.

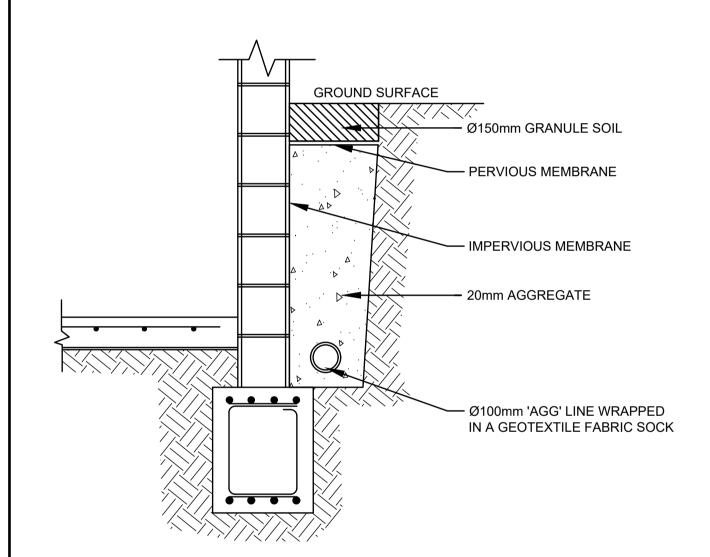


#### TYPICAL SUBSOIL DRAIN


N.T.S

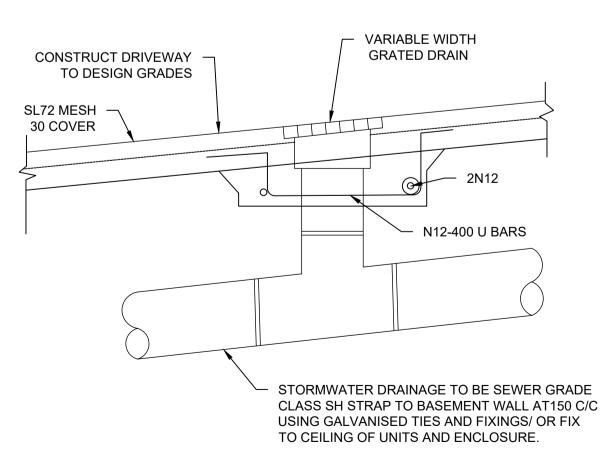



#### GRATED DRAIN DETAIL

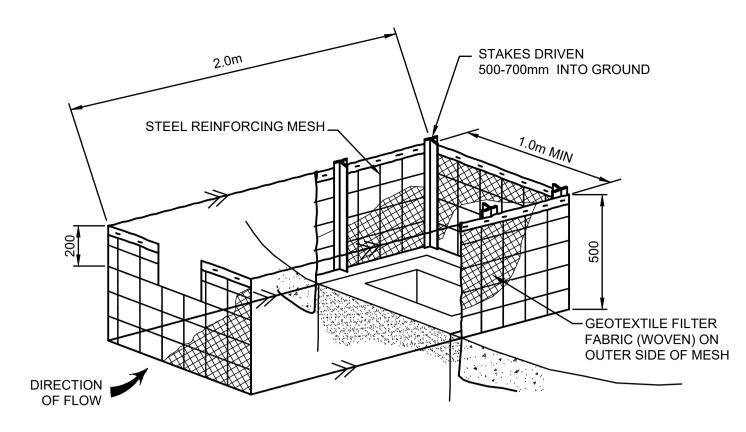


FIELD INLET SEDIMENT TRAP

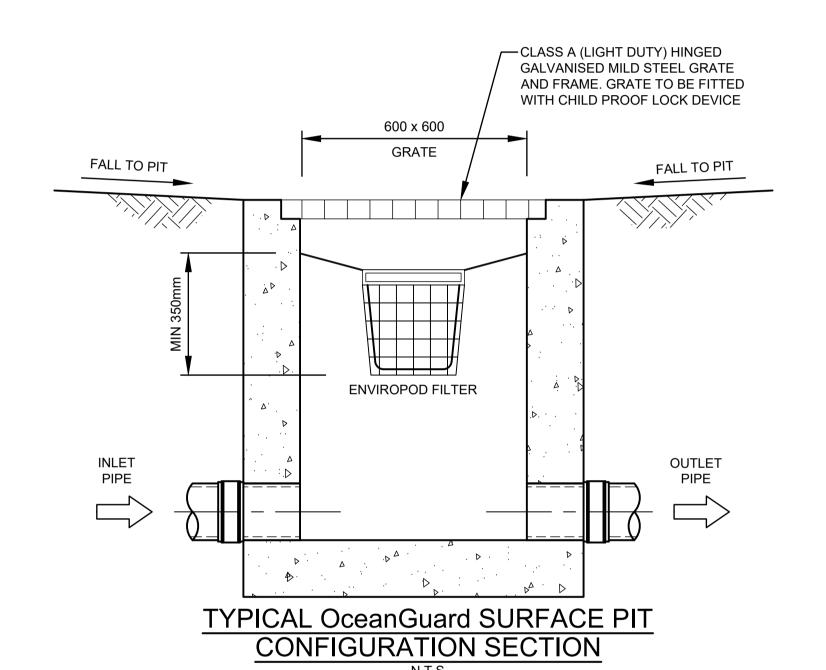

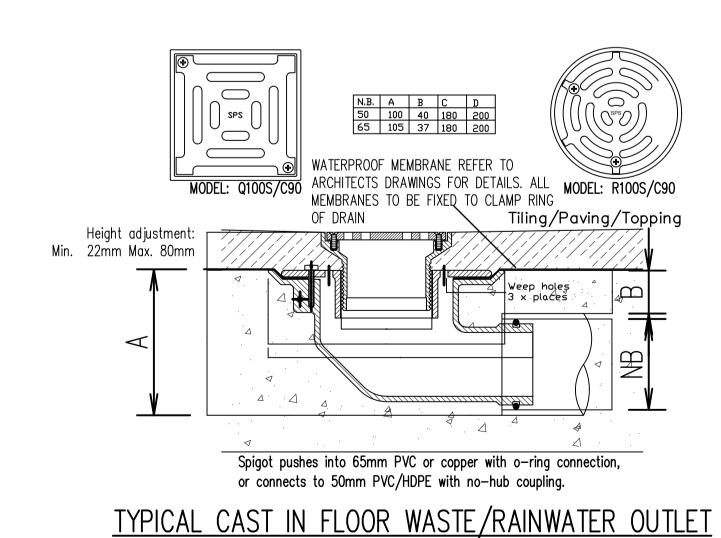

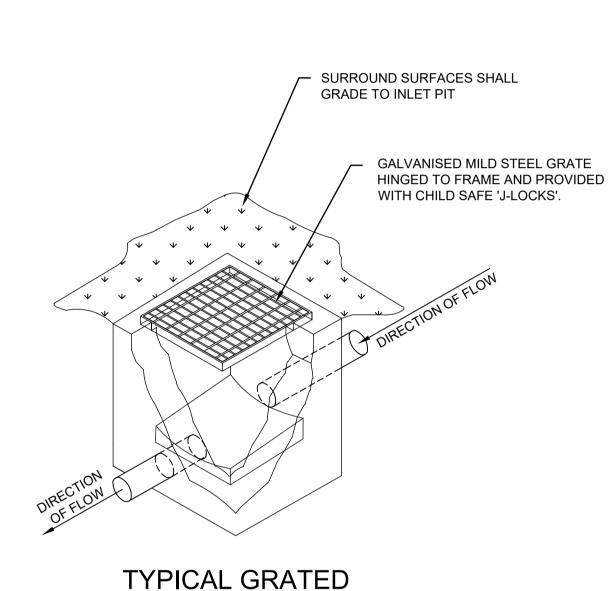


**INLET PIT DETAIL** 

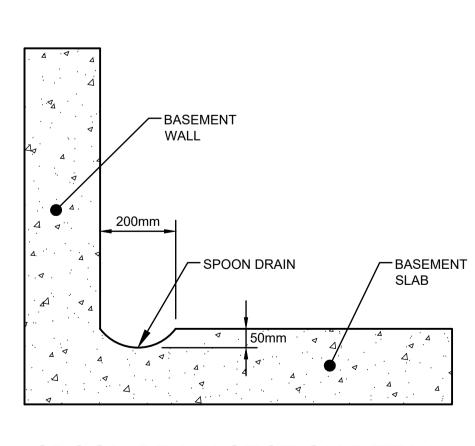

SPOON DRAIN SECTION DETAIL

SCALE 1:10

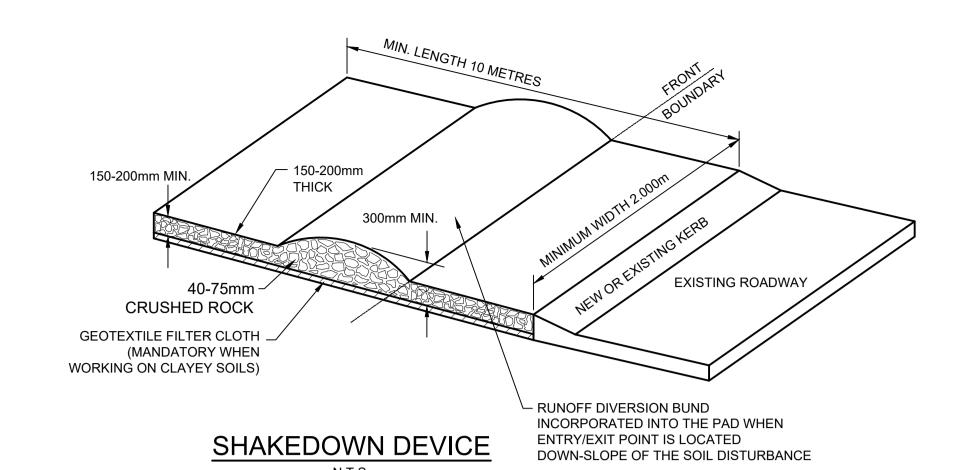

(SIZE AS INDICATED ON PLAN)
TERRACE ON PLAN)
CONCRETE SLAB

VIOLENTIAL CONTROL OF THE CONTROL OF

STORMWATER DRAINAGE TO BE SEWER GRADE CLASS SH STRAP TO BASEMENT WALL AT150 C/C USING GALVANISED TIES AND FIXINGS/ OR FIX TO CEILING OF UNITS AND ENCLOSURE.

#### RAINWATER OUTLET DETAIL

N.T.S.

1.0m (MIN) LONG FENCE
POSTS. 'T' OR 'U' TYPE
STEEL OR 50mm HARDWOOD

FILTER CLOTH "PROPEX
1380 SILT STOP" OR
APPROVED EQUIVALENT

DRAPE BOTTOM 150mm OF SILT FENCE
IN TRENCH, BACKFILL WITH SOIL AND
COMPACT TO ENSURE ANCHORAGE.

## SILT FENCE DETAIL

#### SILT FENCE NOTES:

STEEP TERRAIN.

- 1. FILTER CLOTH TO BE FASTENED SECURELY TO POSTS WITH
- GALVANISED WIRE TIES, STAPLES OR ATTACHMENT BELTS.
  2. POSTS SHOULD NOT BE SPACED MORE THAN 3.0m APART.
- 3. WHEN TWO SECTIONS OF FILTER CLOTH ADJOIN EACH OTHER THEY SHALL BE OVERLAPPED BY 150mm AND FOLDED.
- 4. FOR EXTRA STRENGTH TO SILT FENCE, WOVEN WIRE (14mm GAUGE, 150mm MESH SPACING) TO BE FASTENED SECURELY
- BETWEEN FILTER CLOTH AND POSTS BY WIRE TIES OR STAPLES
  5. INSPECTIONS SHALL BE PROVIDED ON A REGULAR BASIS,
  ESPECIALLY AFTER RAINFALL AND EXCESSIVE SILT DEPOSITS
- REMOVED WHEN "BULGES" DEVELOP IN SILT FENCE
  6. SEDIMENT FENCES SHALL BE CONSTRUCTED WITH SEDIMENT
  TRAPS AND EMERGENCY SPILLWAYS AT SPACINGS NO GREATER
  THAN 40m ON FLAT TERRAIN DECREASING TO 20m SPACINGS ON

NOT FOR CONSTRUCTION

 B
 COUNCIL COMMENTS
 21/06/2022 AGN JSF

 A
 ISSUE FOR DEVELOPMENT APPLICATION
 20/12/2021 JTF JSF

 Issue
 Description
 Date
 Design Checked



Idraft Architecs
Pty Ltd
Unit 43,2 Slough Avenue,
Silverwater NSW 2128
PHONE: 02 9648 8848
Email:pierre@idraft.com.au
www.idraft.com.au
www.idraft.com.au

Council
City of Parramatta
Council

TELFORD CIVIL DESIGN & CONSTRUCTION EXCELLENCE


Level 4, 470 Church Street, Email: info@telfordcivil.com.au
Parramatta NSW 2150 Phone: 02 7809 4931

PO BOX 3579 Parramatta 2124 Company: Telford Consulting Pty Ltd


2-4 BOUNDARY STREET &
85 RAILWAY STREET, PARRAMATTA
PROPOSED RESIDENTIAL DEVELOPMENT
STORMWATER CONCEPT PLANS
DEVELOPMENT APPLICATION

MISCELLANEOUS DETAILS SHEET


Scale A1 Project No. Dwg. No. 1
As Shown 2021316 108

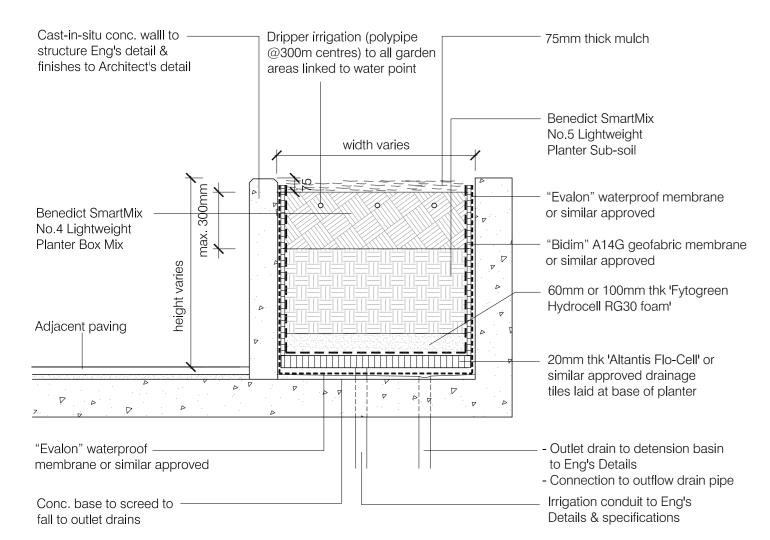

TYPICAL DETAIL 01: on-structure planter

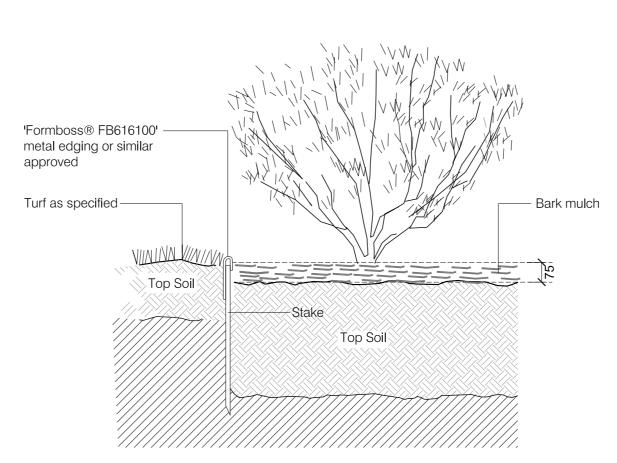

TYPICAL DETAIL 02: metal edging scale: 1:10

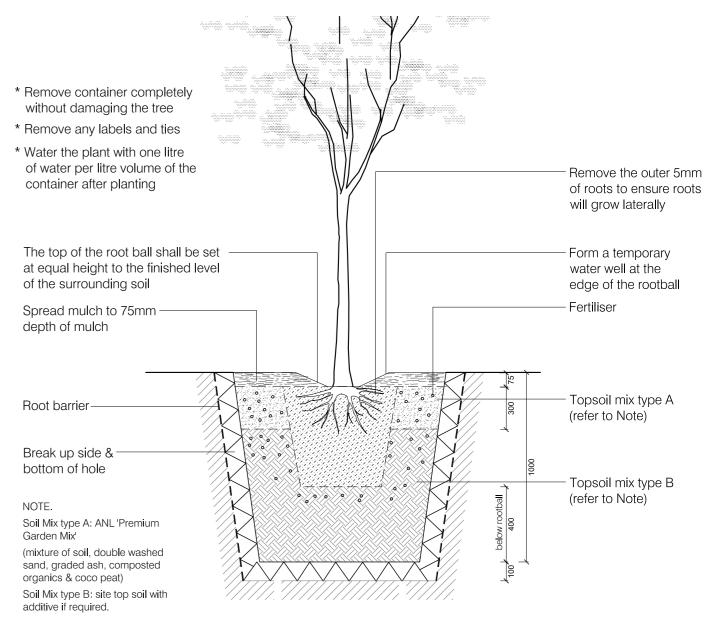

TYPICAL DETAIL 03: tree planting

scale: 1:20

#### MANTENANCE PROGRAM

The typical range of maintenance tasks required over a 12 month period is summarised in the table. Any information provided in the table must be assessed in the light of the weather and general site conditions. For example, watering frequency depends on the soil drainage and rainfall; fertiliser type and frequency needs to be adjusted to suit the plant requirements and the soil fertility and pH. MULCH

Mulch will need be topped up periodically to maintain a min. depth of 75mm. Mulch should be kept at least 50mm away from plant stems to reduce the rick of collar rot. WEEDS

Weeds in mulched beds will need to be controlled by hand pulling or by the use of non residual herbicides. When using herbicides be very careful to avoid spray drifting onto valuable plants. the smallest contact with the chemicals can cause damage.

PLANT MAINTENANCE Deep watering once or twice a week is more beneficial to plants than frequent light watering. Frequent watering will produce shallow roots and make the plant less stable and susceptible to drought. Maintain moisture to the bottom of the rootball for the first 3 months. To help safeguard plants remove labels immediately after planting. Where plants are susceptible to damage by vehicles to pedestrians, maintain protective fences until plants are well established. Replace dead plants fortnightly until such time as alternative maintenance procedures are in places.

LAWN MAINTENANCE Once lawn has been established, carry out watering and fertilising as suggested in the typical maintenance program. In summer, through watering, two or three times each week will encourage roots to go deeper in search of water. Mow grass as required to maintain an even tidy appearance.

Frequency											
January	February	March	April	May	June	July	August	September	October	November	December
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		f. 0<<	January (*/*):	f. Ø< . <d\^; td="" wz0x="" z<=""><td>- &lt;&lt;\\;</td><td>  April   Apr</td><td>April</td><td>  August   A</td><td>  August   A</td><td>April April Agrin Agrin</td><td>April March March March March March March March March March May May March March May March March May March M</td></d\^;>	- <<\\;	April   Apr	April	August   A	August   A	April April Agrin	April March March March March March March March March March May May March March May March March May March M

#### PROPOSED PLANT SCHEDULE

CODE	BOTANICAL NAME	COMMON NAME	POT SIZE	MATURE HEIGHT	NO.
	TREES				
ACD	Acacia decurrens	Black Wattle	45L	8m	2
ACI	Acacia implexa	Sydney Green Wattle	45L	9m	1
ANC	Angophora costata	Smooth-barked Apple	45L	15m	1
BAM	Backhousia myrtifolia	Grey Myrtle	45L	6m	1
BRP	Brachychiton populneus	Kurrajong	45L	12m	2
CAS	Callistemon salignus	Willow-leaved Bottlebrush	45L	6m	1
COF	Corymbia ficifolia	Flowering Gum	45L	8m	1
СОМ	Corymbia maculata	Spotted Gum	45L	20m	4
ELR	Elaeocarpus reticulatus	Blue-berry Ash	45L	8m	4
ESR	Eucalyptus 'Summer Red'	Flowering Gum	45L	6m	1
EUH	Eucalyptus haemastoma	Scribbly Gum	45L	15m	2
EUR	Eucalyptus robusta	Swamp Mahogany	45L	25m	2
FRR	Fraxinus 'Raywood'	Claret Ash	45L	7m	2
LEP	Leptospermum polygalifolium	Lemon Scented Tea Tree	45L	6m	2
MEN	Melaleuca nodosa	Prickly-leaved Paperbark		6m	1
PLR	Plumeria rubra	Frangipani	45L	6m	1
PYCC	Pyrus calleryana 'Chanticleer'	Calleryana Pear	45L	11m	3
TRL	Tristaniopsis laurina	Water Gum	45L	8m	2
	SCREEN & BARRIER SHRUBS				
Acs	Acmena smithii var.minor	Dwarf Lillypilly	25L	3m	18
Cor	Correa reflexa	Native Fuchsia	200mm	1.2m	10
Dsg	Duranta "Sheena's Gold"	Golden Dew Drop (Hedge)	25L	2m	9
Goo	Goodenia ovata	Hop Goodenia	200mm	2m	9
Grl	Grevillea linearifolia	White Spider Flower	200mm	1m	6
Grs	Grevillea sericea	Silky Grevillea	200mm	1.5m	19
Isa	Isopogon anemonefolius	Drumsticks	200mm	1.8m	13
Ozd	Ozothamnus diosmifolius	Rice Flower	200mm	2m	20
Pgp	Pittosporum "Green Pillar"	Green Pillar Pittosporum	5L	3m	22
Phgr	Photinia glabra 'Rubens'	Photinia	25L	2m	11
Pil	Pimelea linifolia	Slender Rice Flower	200mm	1.5m	5
Pmy	Philotheca myoporoides	Wax Flower	200mm	1.5m	2
Rism	Raphiolepis indica 'Snow Maiden"	Indian Hawthorn	200mm	1.5m	5
Saas	Syzygium australe 'Aussie Southern'	Syzygium 'Aussie Southern'	5L	2m	25
Vio	Viburnum odoratissimum 'Emerald Lustre'	Emerald Lustre	300mm	2m	14
Wef	Westringia fruticosa	Coastal rosemary	200mm	1.5m	9

CODE	BOTANICAL NAME	COMMON NAME	POT SIZE	HEIGHT	NO.
	GROUND COVERS				
Ald	Alternanthera dentata	Ruby leaf alternanthera	200mm	0.5m	36
Cag	Casuarina glauca 'cousin it'	Cousin It	200mm	0.3m	13
Dib	Dietes biocolor	Yello Wild Iris	200mm	1m	60
Dir	Dianella revoluta 'little rev'	Black Anther Flax Lily	200mm	0.3m	18
Dis	Dichondra 'silver falls'	Dichondra	200mm	0.2m	13
Dss	Dianella Silver Streak	Silver Streak Flax Lily	200mm	0.4m	41
Gat	Gazania tomentosa	Gazania	200mm	0.2m	31
Imc	Imperata cylindrica	Blady Grass	200mm	0.6m	35
Isn	Isolepis nodosa	Nobby Club-rush	200mm	0.5m	51
Juu	Juncus usitatus	Tussock Rush	200mm	0.9m	98
Lim	Liriope muscari 'Variegata'	Variegata Lily Turf	200mm	0.3m	5
Lolk	Lomandra longifolia 'Katrinus'	Spiny-headed Mat-rush 'Katrinus	200mm	0.7m	87
Opj	Ophiopogon japonicus 'Black Dragon'	Mondo Grass	200mm	0.3m	5
Par	Pennisetum advena 'Rubrum'	Pupple Fountain Grass	200mm	1.5m	50
Pea	Pennisetum alopecuroides	Black Lea	200mm	0.8m	61
Pol	Poa labilladieri	Tussock Grass	200mm	0.8m	60
Scr	Scaevola ramosissima	Puple Fan Flower	200mm	0.4m	42
Sel	Senecio lautus	Variable groundsel	200mm	0.4m	59
Ses	Senecio serpens	Dwarf Blue Chalk Sticks	200mm	0.2m	11
Tha	Themeda australis	Kangaroo Grass	200mm	1m	13
Vih	Viola hederacea	Native Violet	200mm	0.2m	69

CODE	BOTANICAL NAME	COMMON NAME	POT SIZE	HEIGHT	NO.
	ACCENT PLANTS				
Aga	Agave attenuata	Century Plant	200mm	1.5m	10
Cac	Cordyline australis 'Cabernett'	Cordyline Cabernett	200mm	1.2m	13
Срј	Cordyline "Pink Joy"	Pink Joy Cordyline	150mm	1.2m	4
Phbb	Phormium 'Bronze Baby'	Bronze Baby Flax	200mm	0.8m	8
Std	Strelitzia reginae dwarf	Dwarf Bird-of-Paradise	200mm	0.6m	13
	TURF GRASS				
As noted	Stenotaphrum secundatum	Sir Walter Buffalo	roll		173m2

#### PROPOSED PLANTING & SAMPLE PLAY ITEMS IMAGE PALETTE










































































dwg title landscape typical details & maintenance schedule

scale: as shown revision date dwg no.: DA-L103 18/12/2021 da submission da amendments 22/06/2022 Client: INFINITY IDEAS Pty Ltd.

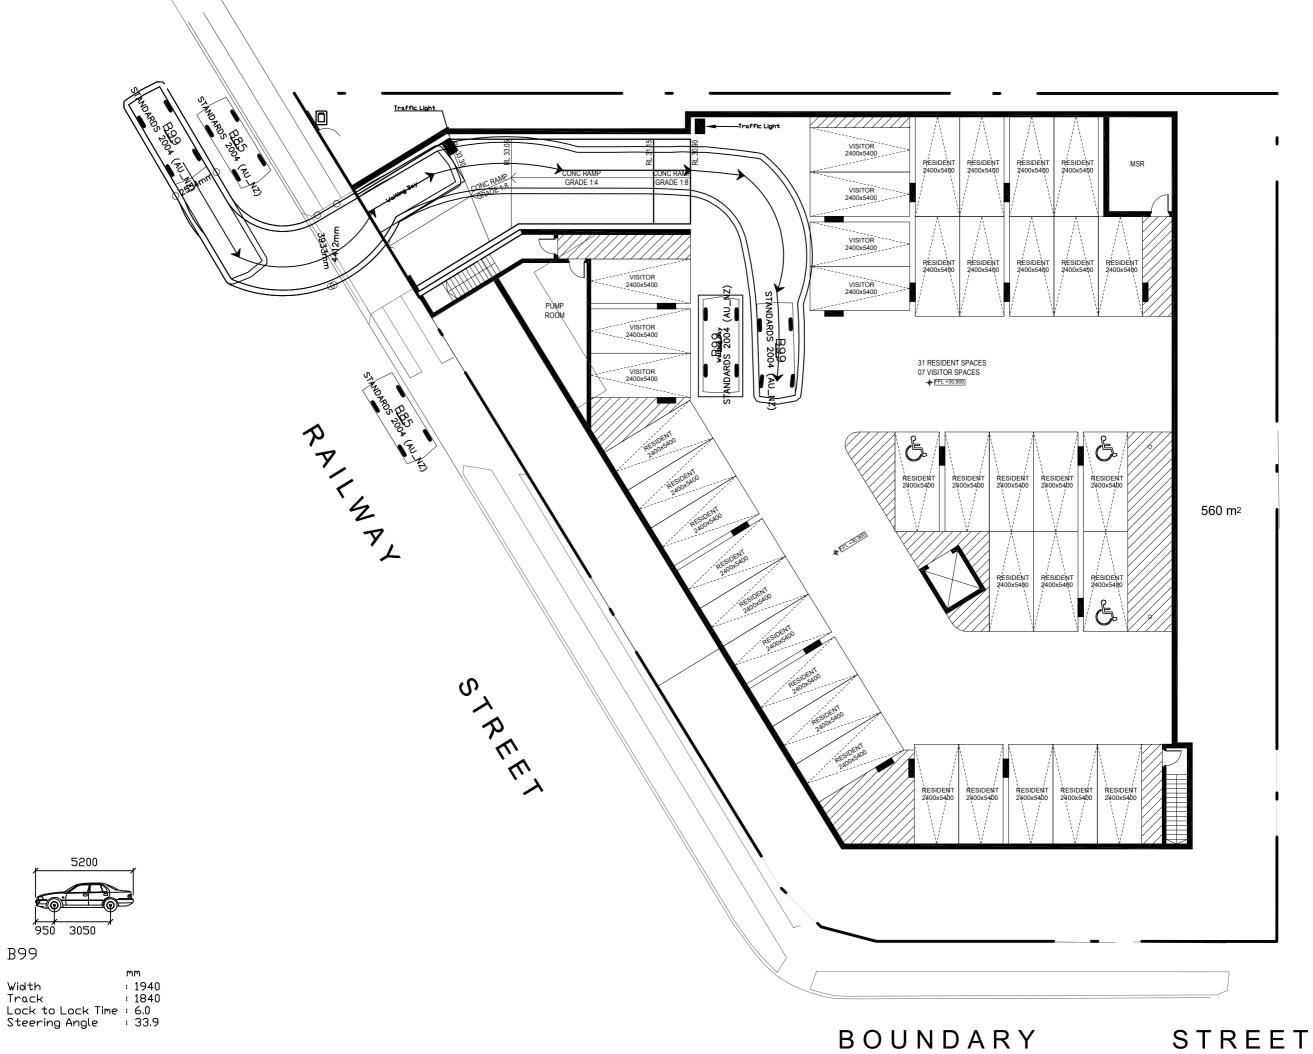

B99

