SHEET INDEX **COVER SHEET EXISTING CONDITIONS** SITE PLAN SITE ANALYSIS **CUT & FILL PLAN** WATER MANAGEMENT PLAN GROUND FLOOR PLAN WINDOW & DOOR SCHEDULES ATTIC PLANS ATTIC ACCESS DETAILS **ELEVATIONS / SECTION ELEVATIONS** SHADOW DIAGRAMS - JUNE 21 KITCHEN DETAILS SLAB PLAN **BUTLER'S PANTRY DETAILS** DRAINAGE PLAN **BATHROOM DETAILS ENSUITE DETAILS** LAUNDRY DETAILS FLOOR COVERINGS

BASIX AREAS CONDITIONED 152.20 UNCONDITIONED 12.31

TOTAL FLOOD ADEAC

IUIAL FLOOK AKEAS	
ALFRESCO	9.23
GARAGE	26.60
LIVING	182.05
PATIO	9.05
	000 00

COMPLIANCE AREAS

LANDSCAPED AREA 219.33

SUSTAINABILITY COMMITMENTS

PRELIMINARY SUSTAINABILITY COMPLIANCE FOR YOUR HOME REQUIRES FURTHER ASSESSMENT TO DETERMINE COMPLIANCE CRITERIA. THIS ASSESSMENT WILL BE FINALISED UPON APPROVAL OF YOUR EXTERNAL COLOUR SELECTIONS TO DETERMINE IF VARIATIONS ARE REQUIRED TO THE PROPOSED DWELLING E.G. ADDITIONAL INSULATION, CHANGES IN WINDOW GLAZING / SIZE / ORIENTATION ETC. YOU WILL BE ADVISED OF ANY REQUIREMENTS OR ALTERNATIVES ONCE THE ASSESSMENT HAS BEEN COMPLETED.

WATER COMMITMENTS

3 STAR (> 7.5 BUT <= 9L/MIN) SHOWER HEADS 4 STAR TOILET SUITES 4 STAR KITCHEN TAPS 5 STAR BATHROOM TAPS

230.28 m² TOTAL ROOF AREA

3239 L WATER TANK(S) MINIMUM CAPACITY 183.95 m² MINIMUM ROOF AREA TO TANK(S)

RAINWATER TANK(S) TO BE CONNECTED TO:

- AT LEAST ONE OUTDOOR TAP

- ALL TOILETS

13

14

15

17

18

- WASHING MACHINE

NO RETICULATED RECYCLED WATER SUPPLY

200 m² GARDEN/LAWN AREA

ENERGY COMMITMENTS

HOT WATER SYSTEM

- GAS CONTINUOUS FLOW - 6 STAR

HEATING SYSTEM

- 1-PHASE REVERSE CYCLE AIR CONDITIONING EER 3.5 - 4.0

COOLING SYSTEM

- 1-PHASE REVERSE CYCLE AIR CONDITIONING EER 3.0 - 3.5

VENTILATION (EXHAUST FANS)

- AT LEAST ONE BATHROOM: DUCTED TO OUTSIDE AIR, INTERLOCKED TO LIGHT

- KITCHEN RANGEHOOD:

DUCTED TO OUTSIDE AIR, MANUAL ON/TIMER OFF

- NO MECHANICAL VENTILATION TO LAUNDRY

PRIMARY FLUORESCENT/LED LIGHTING INCLUDING

- 3 BEDROOMS/STUDY, NON-DEDICATED

- 2 LIVING/DINING AREAS, NON-DEDICATED

- KITCHEN, NON-DEDICATED

- ALL BATHROOMS/TOILETS, NON-DEDICATED

- LAUNDRY, NON-DEDICATED

- ALL HALLWAYS, NON-DEDICATED

NATURAL LIGHTING TO - 2 BATHROOMS/TOILETS

ALTERNATIVE ENERGY

OTHER

- INDUCTION COOKTOP, ELECTRIC OVEN

- FIXED OUTDOOR CLOTHESLINE BY OWNER

GENERAL INFORMATION

ALL CONSTRUCTION TO BE IN ACCORDANCE WITH NCC AND APPLICABLE AUSTRALIAN STANDARDS AT TIME OF APPROVAL

THESE PLANS FEATURE WORKS REQUIRED BY THE OWNER THAT MAY BE EXCLUDED FROM THE SCOPE OF THE CONTRACT WITH THE BUILDER, BUT HAVE BEEN INCLUDED IN THESE DRAWINGS TO ASSIST IN THE OVERALL PLANNING AND ASSESSMENT. SOME REGULARLY EXCLUDED WORKS INCLUDE DRIVEWAYS, RETAINING WALLS AND SITE DRAINAGE. PLEASE REFER TO YOUR CONTRACT TENDER AND COLOUR SELECTIONS DOCUMENTATION FOR DETAILS.

BUILDING INFORMATION

GROUND FLOOR PITCHING HEIGHT(S): 2595mm, 3281mm FIRST FLOOR PITCHING HEIGHT(S): 2400mm FRAMES AND TRUSSES: STEEL ROOF PITCH (U.N.O.): 30 0° **ELECTRICITY SUPPLY:** SINGLE PHASE GAS SUPPLY: RETICULATED SUPPLY

SHEET METAL **ROOF MATERIAL:** ROOF COLOUR: **ROOF INSULATION:** R4.1 BATTS SARKING

WALL MATERIAL: BRICK VENEER, CLADDING

WALL COLOUR: WALL INSULATION: R2.0 BATTS

WALL WRAP TO CLADDING

FLOOR INSULATION: N/A

SITE & ENGINEERING INFORMATION

DESIGN WIND CLASSIFICATION: N2 SITE CLASSIFICATION: SLAB CLASSIFICATION: TBC

SLAB TO BE IN ACCORDANCE WITH AS 2870. REFER TO ENGINEER'S DRAWINGS FOR ALL SLAB DETAILS.

PROVIDE BRICK CONTROL JOINTS IN ACCORDANCE WITH N.C.C.

ALL STEEL FRAMING TO BE DESIGNED TO AS 4100-2020 OR AS/NZS 4600-2018





PRELIMINARY CONSTRUCTION DRAWING

DATE:

12/07/2022

DRAFTING OFFICE:

HUNTER

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mcdonald	jones
YOUR HOME, YOUR	DREAM

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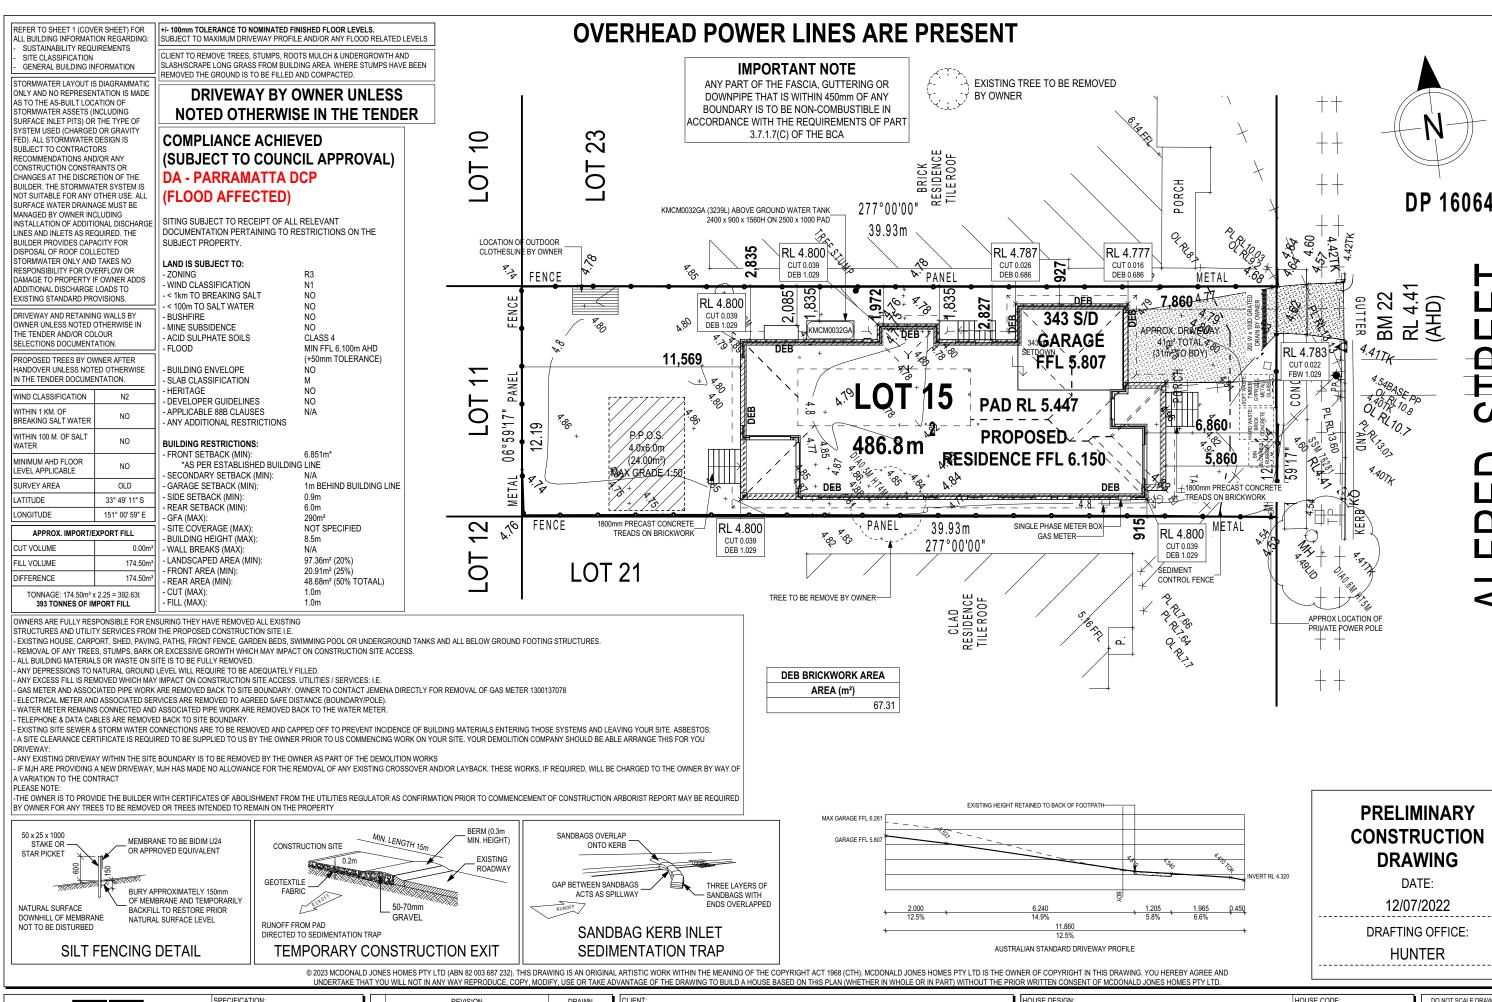
Ì		REVISION		RAWN
ı	8	AMENDED AS PER PCV009	CLG	2022.10.27
1	9	AMENDED AS PER PCV10	LFL	2023.05.05
ı	10	AMENDED AS PER PCV11 & PCV12	LFL	2023.06.27
1	11	CUT AND FILL PLAN ADDED	LFL	2023.07.10
l	12	RIDGE HEIGHT RL / ACCESS DETAILS	SIO	2023.09.26

٦L	VANTAGE OF THE DRAWING TO BUILD A	HOUSE BASED ON THIS FLAN (WHETHER IN WHOLE OR IN PART) WITHOUT THE
_		
I	CLIENT:	
1	MRS. LAURA THERESE	DOLIMANOLIS
ı	IVING. LAUNA ITIENESE	ROUMANOUS
ı	ADDRESS:	
1	140 ALFRED STREET, H	ARRIS PARK NSW 2153
	140 ALI NED OTNEET, I	ANNO I ANN NOW 2100
ı	LOT / SECTION / DP:	COUNCIL:
1	22 / - / DP16064	CITY OF PARRAMATTA COUNCIL
┛	227-701 10004	OTT OF FARMANIATIA COUNCIL
_		

HOUSE DESIGN:		HOUSE CODE:
CAMELLE ONE		H-CMLCLAS18410A
FACADE DESIGN:		FACADE CODE:
CHIFLEY		F-CMLCFLY01
SHEET TITLE:	SHEET No.:	SCALES:
COVER SHEET	1 / 21	

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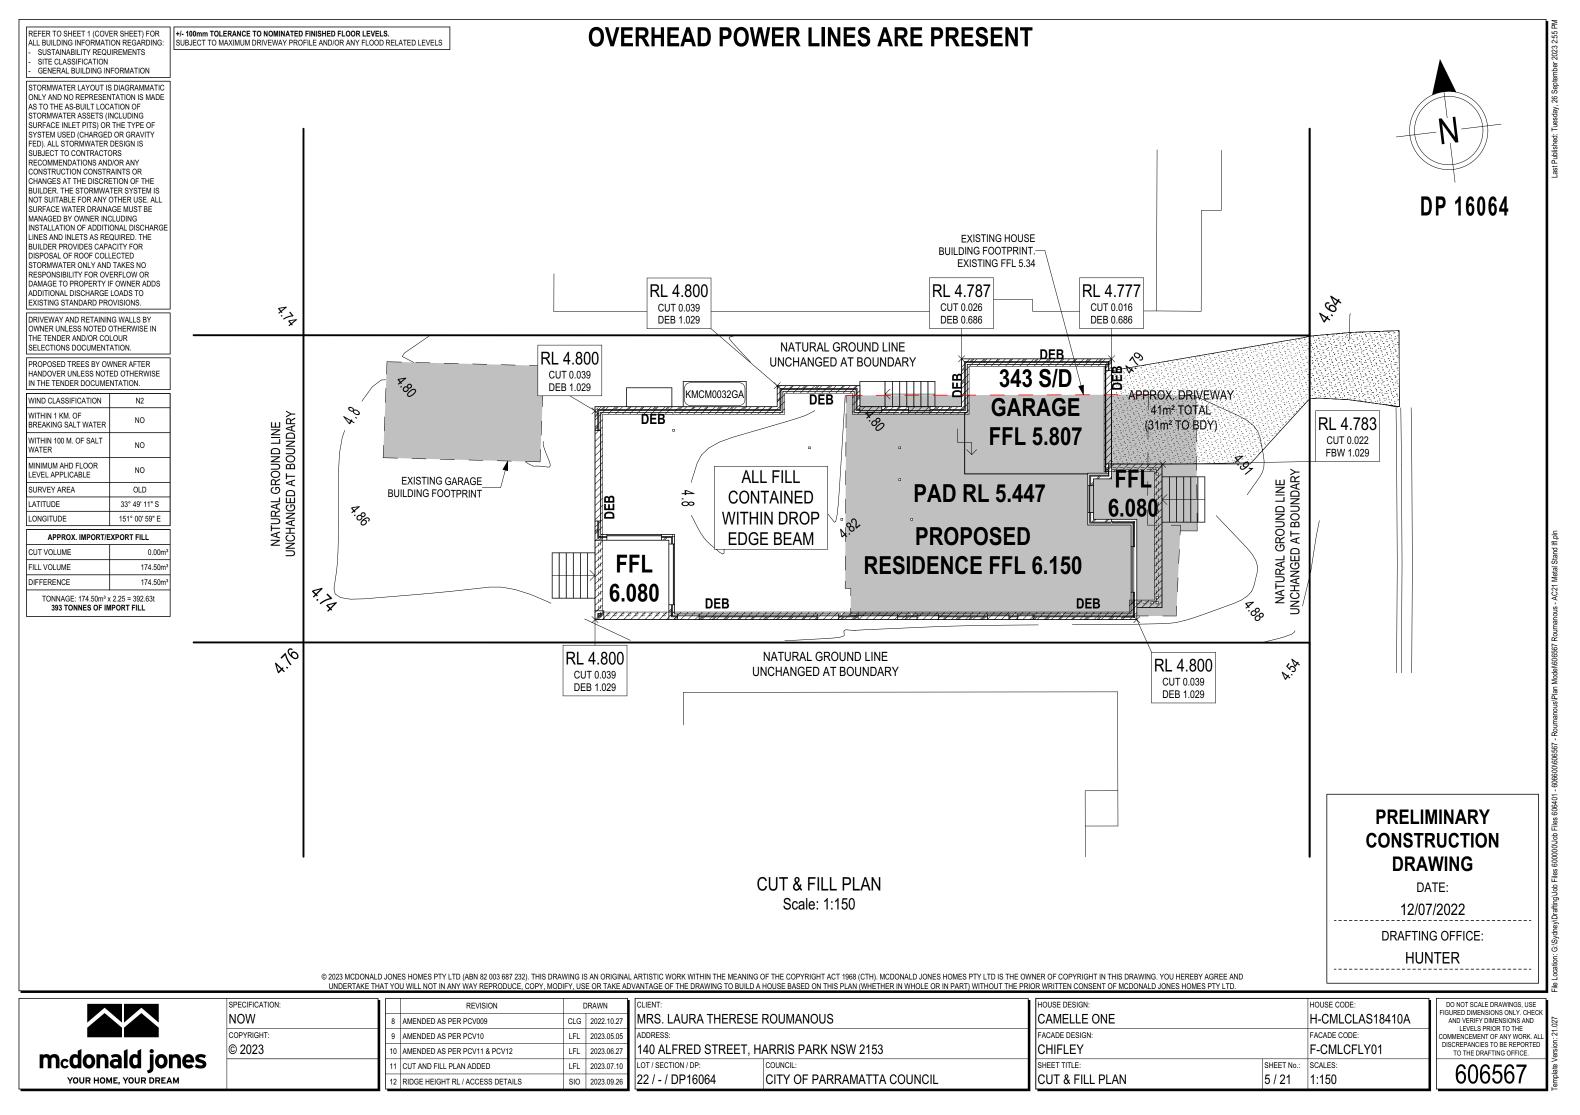
DRAWN 8 AMENDED AS PER PCV009 CLG 2022.10.27 9 AMENDED AS PER PCV10 LFL 2023.05.05 10 AMENDED AS PER PCV11 & PCV12 LFL 2023.06.27 11 CUT AND FILL PLAN ADDED LFL 2023.07.10 12 RIDGE HEIGHT RL / ACCESS DETAILS SIO 2023.09.26

MRS. LAURA THERESE ROUMANOUS ADDRESS 140 ALFRED STREET. HARRIS PARK NSW 2153 LOT / SECTION / DP 22 / - / DP16064 CITY OF PARRAMATTA COUNCIL

HOUSE DESIGN HOUSE CODE CAMELLE ONE H-CMLCLAS18410A FACADE DESIGN FACADE CODE: CHIFLEY F-CMLCFLY01 SHEET TITLE SHEET No.: SCALES: SITE PLAN 3 / 21 1:200, 1:125

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WINDOW SCHEDULE

0, 1 ASSUME LOOKING FROM OUTSIDE

ID	CODE°	ROOM	HEIGHT	WIDTH F	PERIMETER	AREA FRAME (m²) TYPE	BAL RATING	SILL TYPE	ORIENT.	GLAZING AREA (m²)	ADDITIONAL INFORMATION ¹	
W0′	1 FF/AA1785x1810	GUEST BED	1,785	1,810	7,190	3.23 ALUMINIUM	N/A	SNAP HEADER	E	2.52 CLEAR	BP 1190, MP 905/905, GLAZING BARS	
W02	2 D2080x850	BATH	2,080	850	5,860	1.77 ALUMINIUM	N/A	SNAP HEADER	N	1.50 SATINLITE, TOUGHENED		
WO	3 D2080x850	FAMILY / LIVING	2,080	850	5,860	1.77 ALUMINIUM	N/A	SNAP HEADER	S	1.50 CLEAR		
W04	4 D2080x850	FAMILY / LIVING	2,080	850	5,860	1.77 ALUMINIUM	N/A	SNAP HEADER	S	1.50 CLEAR		
WO	5 DF1216	BED 2	1,200	1,570	5,540	1.88 ALUMINIUM	N/A	ANGLED	S	1.56 CLEAR	MP 785	
W06	6 D2080x850	MASTER SUITE	2,080	850	5,860	1.77 ALUMINIUM	N/A	SNAP HEADER	S	1.50 CLEAR		
W07	7 D2080x850	MASTER SUITE	2,080	850	5,860	1.77 ALUMINIUM	N/A	SNAP HEADER	S	1.50 CLEAR		
W08	B SF1006	ENS	1,030	610	3,280	0.63 ALUMINIUM	N/A	ANGLED	S	0.47 SATINLITE, TOUGHENED		
W08	B D1012	ATTIC	1,030	1,210	4,480	1.25 ALUMINIUM	N/A	NONE	N	1.02 SATINLITE, TOUGHENED		
WOS	9 D1012	ATTIC	1,030	1,210	4,480	1.25 ALUMINIUM	N/A	NONE	N	1.02 SATINLITE, TOUGHENED		

14.09

EXTERIOR DOOR SCHEDULE

0, 1 ASSUME LOOKING FROM OUTSIDE

ID	CODE°	ROOM	HEIGHT	WIDTH	AREA FRAME (m²) TYPE	BAL RATING	SILL TYPE	ORIENT.	GLAZING TYPE	DOOR TYPE ADDITIONAL INFORMATION¹
DO	1 1020	ENTRY	2,106	1,067	2.25 TIMBER	N/A	SNAP HEADER	Е	DOOR(S): N/A - SIDELIGHT(S): N/A	SWINGING
DO	2 820	LDRY	2,106	867	1.83 TIMBER	N/A	SNAP HEADER	N	DOOR(S): CLEAR - SIDELIGHT(S): N/A	SWINGING
DO	3 FSS2136	DINING	2,100	3,588	7.53 ALUMINIUM	N/A	SNAP HEADER	W	CLEAR, TOUGHENED	STACKER
DC	4 FS2122	DINING	2,100	2,170	4.56 ALUMINIUM	N/A	SNAP HEADER	S	CLEAR, TOUGHENED	SLIDING
DC	5 SF2124	FAMILY / LIVING	2,100	2,410	5.06 ALUMINIUM	N/A	SNAP HEADER	W	CLEAR, TOUGHENED	SLIDING

21.23 m²

INTERIOR DOOR SCHEDULE

QT	CODE	TYPE	HEIGHT	WIDTH	GLAZING	ADDITIONAL INFORMATION
3	1020 SS	SQUARE SET OPENING	2,155	1,020	N/A	
1	2 x 520	SWINGING	2,040	1,040	N/A	
1	2 x 620	SWINGING	2,040	1,240	N/A	
1	720	SWINGING	2,040	720	N/A	LIFT-OFF HINGES
1	770	SWINGING	2,040	770	N/A	LIFT-OFF HINGES
2	770	SWINGING	2,040	770	N/A	
1	800 SS	SQUARE SET OPENING	2,155	800	N/A	
4	820	SWINGING	2,040	820	N/A	

17.09

PICTURE/TV RECESS & SQUARE SET WINDOW SCHEDULE

QTY	TYPE	HEIGHT	WIDTH	AREA (m²)
1	PICT RECESS	650	0.40	0.26

REFER TO SHEET 1 (COVER SHEET) FOR ALL BUILDING INFORMATION REGARDING: - SUSTAINABILITY REQUIREMENTS - SITE CLASSIFICATION - GENERAL BUILDING INFORMATION

PRELIMINARY CONSTRUCTION **DRAWING**

DATE:

12/07/2022

DRAFTING OFFICE:

HUNTER

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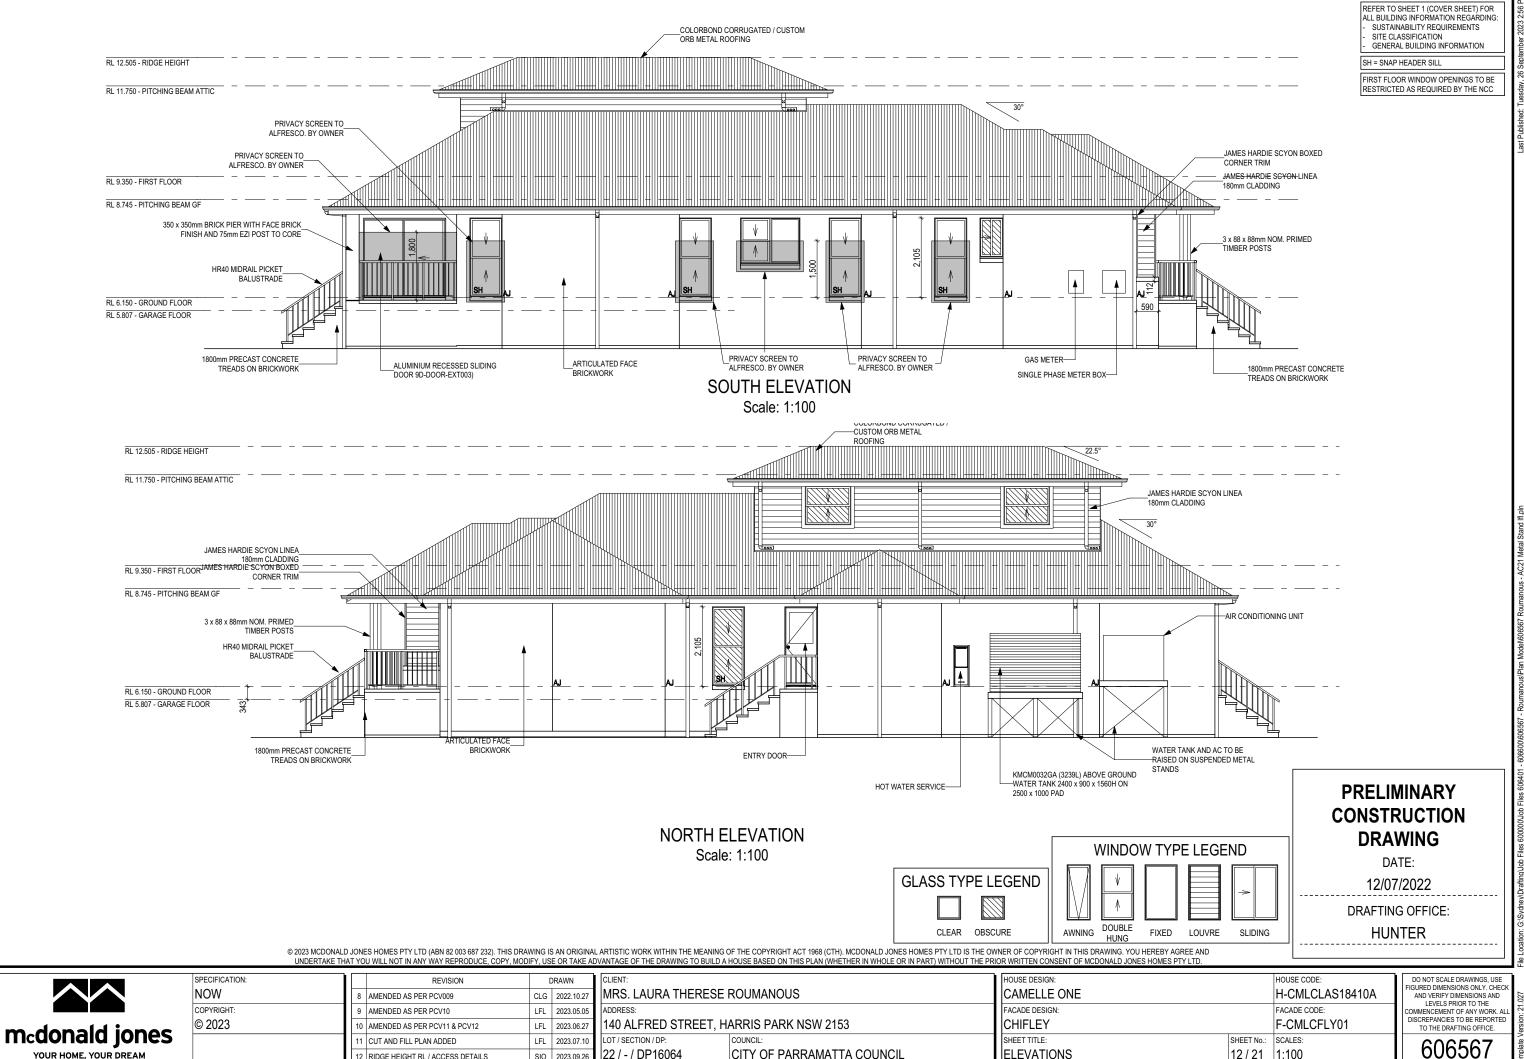
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Ì		REVISION	DRAWN		
ı	8	AMENDED AS PER PCV009	CLG	2022.10.27	
	9	AMENDED AS PER PCV10	LFL	2023.05.05	
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ı	11	CUT AND FILL PLAN ADDED	LFL	2023.07.10	
ı	12	RIDGE HEIGHT RL / ACCESS DETAILS	SIO	2023.09.26	

,	CLIENT:				
.10.27	MRS. LAURA THERESE ROUMANOUS				
.05.05	ADDRESS:				
.06.27	140 ALFRED STREET, HARRIS PARK NSW 2153				
.07.10	LOT / SECTION / DP:	COUNCIL:			
.09.26	22 / - / DP16064	CITY OF PARRAMATTA COUNCIL			

_			
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	FACADE DESIGN:		FACADE CODE:
	CHIFLEY		F-CMLCFLY01
	SHEET TITLE:	SHEET No.:	SCALES:
	WINDOW & DOOR SCHEDULES	8 / 21	

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CITY OF PARRAMATTA COUNCIL

22 / - / DP16064

SIO 2023.09.26

12 RIDGE HEIGHT RL / ACCESS DETAILS

YOUR HOME, YOUR DREAM

ELEVATIONS

12 / 21 | 1:100

EXTERNAL COLOUR PLAN



AUSTRAL BRICKS
Everyday Life, Engage
Off White Mortar, Iron joint



METAL ROOFING
Custom Orb, Colorbond
Dune



WINDOWS Bradnams, Surfmist Matt



COLORBOND, DUNE Gutter & Rainwater Tank



TAUBMANS, SURFMIST

Front Entry Door, Hinged Laundry Door, Eaves, Posts, Cladding & Moulding



COLORBOND, SURFMIST

Fascia



TAUBMANS, DUNE

Downpipes




GARAGE DOOR


Slimline, Surfmist





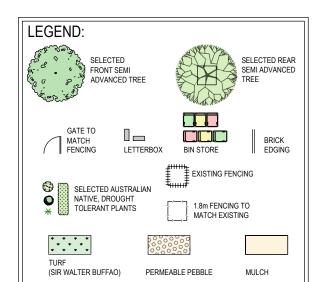

LANDSCAPE PLAN HAS BEEN PREPARED IN EXISTING TREE ACCORDANCE WITH THE PARRAMATTA TO BE REMOVED CITY COUNCIL DCP BY OWNER LANDSCAPED AREA

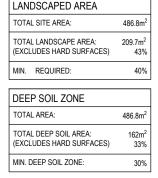

(3239L) ABOVE GROUND WATER TANK 2400 x 900 x 1560H ON 2500 x 1000 PAD LOCATION OF OUTDOOR CLOTHESLINE (BY OWNER) 4000 LOT 10 LOT 23 DEEP SOIL ZONE CUT 0.035 FBW 1.029 RL 4.800 RL 4.787 RL 4.777 CUT 0.096 92. DEB 0.343 PANEL METAL *CUT_0.039 . **GARAGE** APPROX. DRIVEWAY 47m² TOTAL `STEPDOWN' 343mm (31m2 TO BDY) 8 1]569 ·& LOT 22 FFL\\$.807 486.8m² **EG**L 5.447 3 V PROPOSED LOT 11 RESIDENCE > r.83 FFL 6.150

70°50°

1800mm PRECAST CONCRETE

TREADS ON BRICKWORK

RL 4.800

CUT 0.039 FBW 1.029 PANEL

FGL 5.790

TREE TO BE REMOVE BY OWNER

ACID SULFATE SOILS CLASS 4

FLOOD ZONE FENCING MUST BE DESIGNED SO AS NOT TO IMPEDE THE FLOW OF FLOODWATER OR ENTRAP DEBRIS


PLAN	T SCHEDULE:					
CODE	BOTANICAL NAME	COMMON NAME	NATIVE OR EXOTIC	No.	POT	MATURE
TREES					SIÆ	HEIGHT
TLL	Tristaniopsis laurina	Water Gum	NATIVE	2	75lt	8m
SHURBS					050	
WBG	Westringia 'Blue Gem'	C oastal rosemary	NATIVE	14	250mm	0.9m
SAR	Syzygium australe 'Resilience'	Lilly Pilly	NATIVE	33	250mm	1.8m hedged
CWA	Callistemon 'White Anzac'	Callistemon White Anzac	NATIVE	8	200mm	1.0m
HGROUND	COVERS & GRASSES					
MPY	Mypoporum parvifolium 'Yareena'	Myoporum Yareena	NATIVE	23	150mm	0.2m
TURF						
	Stenotaphrum secundatum 'Sir Walter'	Sir Walter Buffalo Turf	EXOTIC		-	-

MAINTENANCE PROCEDURES

- LAWN TO BE FERTILISED TWICE A YEAR IN THE WARM MONTHS, MOWING WEEKLY IN SUMMER MONTHS AND FORTNIGHTLY OR MONTHLY AS REQUIRED IN THE WINTER MONTHS.
- PLANTS TO BE FERTILISLED A MINIMUM OF TWICE A YEAR AT THE SAME TIME OF PRUNING, TO DO THIS USE A COMPLETE FERTILISER. KEEP MULCH CLEAR OF TREE TRUNK AREA. AFTER PLANT/SHURBS AND TREES ARE PLANTED CONTINUE TO WATER WELL ONCE A WEEK.
- PRUNE HEDGE PLANTS A MINIMUM OF 2 3 TIMES A YEAR, IN THE WARMER MONTHS. WAIT FOR AT LEAST 10MM OF NEW GROWTH BEFORE PRUNING AGAIN TO PROMOTE HEALTHY NEW GROWTH.

NOTES:

- ALL LANDSCAPED AREAS TO HAVE A MINIMUM 1:100 FALL TOWARDS STORM WATER DRAINS, OR AWAY FROM THE BUILDING FOR POSSIBLE OVERLAND WATER DRAINAGE
- A TREE PROTECTION ZONE (TPZ) SHALL BE ESTABLISHED FOR THE DURATION OF ANY WORKS NEAR ANY EXISTING TREES, AS PER THE METHOD OUTLINED IN THE CURRENT AS4970-2009. PERMISSION FROM THE COUNCIL ARBORIST IS REQUIRED FOR ACTIVITIES THAT DO NOT COMPLY WITH THE CURRENT AUSTRALIAN STANDARDS
- DRIVEWAY LAYOUT TO BE CONSTRUCTED FROM ARCHITECTURAL CONSTRUCTION DRAWINGS.
- RETAINING WALLS ALONG SIDE BOUNDARIES BETWEEN LOTS TO BE FINALISED ON SITE AFTER **BENCHING**
- ALL RETAINING WALLS VISIBLE FROM THE STREET TO BE MASONRY WITH COLOURS MATCHING THOSE ON THE FRONT FACADE OF THE DWELLING. ALL IMPORTED SOIL TO GARDEN AREAS TO BE OF PREMIUM GARDEN MIX STANDARD AT 300MM
- DFPTH
- TURF TO BE LAID ON A 150MM MINIMUM BASE OF 80% SAND 20% SOIL MIX. REFER TO DETAIL. ALL GARDEN AREAS TO BE COVERED WITH A MINIMUM OF 75MM OF 14MM PINE BARK MUII CH
- GARDEN EDGING IS TO BE INSTALLED BETWEEN ALL ADJOINING SOFT LANDSCAPE FINISHES. REFER TO DETAIL.

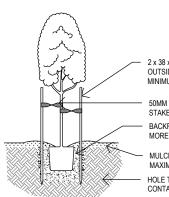

20

LOT 12

FENCE

39.93

LOT 21

1/TLL

33/SAR

2 x 38 x 38mm H/W STAKES DRIVEN OUTSIDE OF ROOT BALL AND A MINIMUM OF 1200mm HIGH 50MM WEBBING LOOSELY STAPLED TO STAKES WITH A DOUBLE CONFIGURATION BACKFILL SOIL TO BE CONDITIONED WITH NOT

MULCH WELL AS SHOWN MAXIMUM DEPTH 75mm


HOLE TO BE DUG TWICE THE SIZE OF THE CONTAINER WITH SURFACE ROUGHED

AFTER PLANTING WATER IN PLANT WELL USING FOUR TIMES THE PLANT

CONTAINER CAPACITY OF WATER FOR TREES 50It AND ABOVE INSERT A 60mm DIA AG PIPE UNDER PLANT IN

BACKFILL TO PROMOTE GOOD AERATION IN SOIL. TREES SHALL NOT BE TIED UNLESS SUPPORT IS ESSENTIAL


TYPICAL TREE PLANTING DETAIL SCALE: N.T.S.

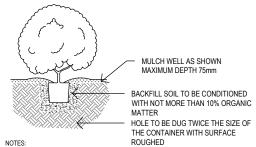

AFTER PLANTING WATER IN PLANT WELL USING FOUR TIMES THE PLANT


APTER PLANTING WATER IN PLANT WELL OSING FUOR TIMES THE PLANT CONTAINER CAPACITY OF WATER.
FOR TREES 50It AND ABOVE INSERT A 60mm DIA AG PIPE UNDER PLANT IN BACKFILL TO PROMOTE GOOD AERATION IN SOIL.

TYPICAL SHRUB PLANTING DETAIL SCALE: N.T.S. Tube, 150mm, 200mm, 250mm Pot Size

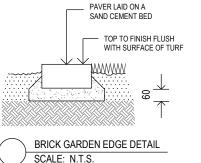

RL4.800

FBW 1.029

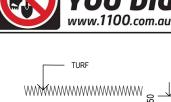

SCALE: N.T.S.

BENCHMARK

- RY 10.>

1 A. 4014

4.783 0.022

1029

8/CWA

1800mm PRECAST CONCRETE

TREADS ON BRICKWORK

SINGLE PHASE METER BOX

. 9

150mm DECOMPACTED TURF DETAIL

15/MPY

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1/TLL

SEE NOTES

APPROX LOCATION OF

PRIVATE POWER POLE

EXISTING STREET TREES TO BE RETAINED AND PROTECTED AS SPECIFIED IN THE AS4970-2009.

14/WBG

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	1		1
REV	ISSUE / DESCRIPTION	DATE	CHECKED
Α	Initial design for DA	24.02.22	KR
В	Revision	27.10.22	KR
С	Revision	03.11.22	KR



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Contractors must verify all dimensions on site before commencing fabrication or preparation of workshop drawings, and verify all errors and ommissions with the Architect. Use figured dimensions only. Do not scale from drawings. Position of all services on site to be confirmed prior to commencement of

PLAN DRAWINGS PREPARED FOR DEVELOPMENT APPLICATION ONLY. PLAN IS NOT TO BE USED FOR CONSTRUCTION PURPOSES

SCALE:	DRAWING NO.
1:200@A3	LP-22158
CLIENT NO: 606567	COUNCIL: PARRAMATTA
DRAWN:	PAGE NO:
AVS	1/1


SO

REVISION

DA LANDSCAPE PLAN NORTH CLIENT: MCDONALD JONES HOMES

DRAWING TITLE:

LOT 22, DP 16064, NO.140 ALFRED STREET, HARRIS PARK, NSW 2150

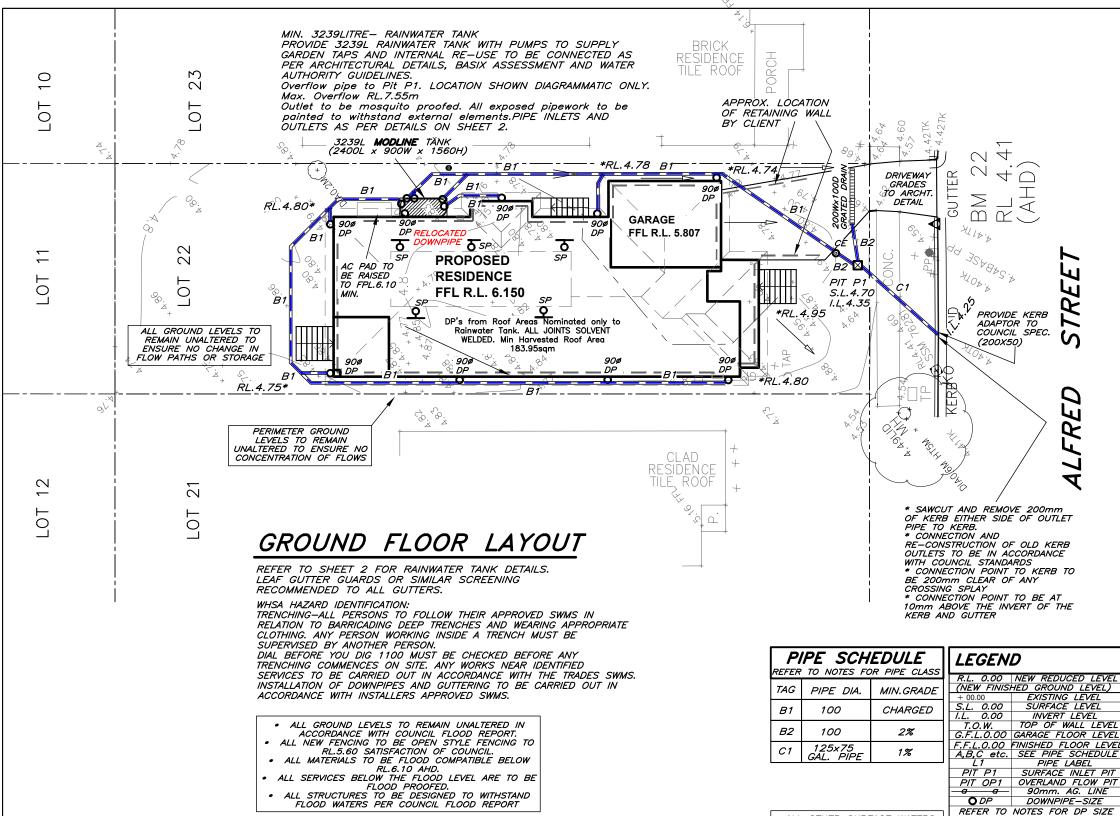

TAG	PIPE DIA.	MIN.GRADE
B1	100	CHARGED
B2	100	2%
C1	125×75 GAL. PIPE	1%

ALL OTHER SURFACE WATERS TO BE STRICTLY CONNECTED TO A SEPARATE SYSTEM BY OWNER IN ACCORDANCE WITH AS 3500:.3:2003 AND BCA PART 3.1.2.3.

RAINWATER TANKS WITH PUMPS TO SUPPLY GARDEN TAPS AND INTERNAL RE-USE AS PER BASIX ASSESSMENT

	HED GROUND LEVEL)
+ 00.00	EXISTING LEVEL
S.L. 0.00	SURFACE LEVEL
1.L. 0.00	INVERT LEVEL
T.O.W.	TOP OF WALL LEVEL
G.F.L.0.00	GARAGE FLOOR LEVEL
F.F.L.0.00	FINISHED FLOOR LEVE
A,B,C etc.	SEE PIPE SCHEDULE
L1	PIPE LABEL
PIT P1	SURFACE INLET PIT
PIT OP1	OVERLAND FLOW PIT
a a	90mm. AG. LINE
O DP	DOWNPIPE-SIZE
REFER TO	NOTES FOR DP SIZE
⊕ GP	GULLY PIT
⊕ GP	GARDEN GULLY PIT
= 0/F	OVERFLOW-200x100
RWH/S	RAIN WATER HEAD/SUMP
5 SP	DP WITH SPREADER
A BC	BALCONY GULLY PIT

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STORMWATER LAYOUT NOTES

PITS UP TO 450 DEEP TO BE 350SQ U.N.O., PITS UP TO 600
DEEP TO BE 450 SQ U.N.O., PITS UP TO 900 DEEP TO BE 600 SQ
U.N.O., PITS UP TO 1200 DEEP TO BE 900 X 600 U.N.O., PITS
EXCEDING 1200 DEEP TO BE 900 SQ U.N.O. PITS TO BE PRECAST
CONCRETE OR RENDERED BRICK WITH CONCRETE HEAVY DUTY
GRATES. U.N.O. LIGHT DUTY PITS AND GRATES MAY BE USED ONLY
IN LIGHT/FOOT TRAFFICABLE AREAS. U.N.O. ALL PITS TO BE BENCHED TO DISCHARGE PIPES U.N.O. GAL. STEP IRONS TO ALL PITS EXCEEDING 900 DEPTH.

-COVER AND SUMP GRATES SHALL COMPLY WITH AS2733 &

-DOWNPIPES TO BE 90 DIA IF CHARGED AND 100 x 50 BOX IF GRAVITY. U.N.O. DP'S SHALL BE INSTALLED IN ACCORDANCE WITH AS3500.3.2:4.11 & AS4198. MAX. ROOF AREA PER DOWNPIPE WITH NOMINATED GUTTER SIZE TO BE DETERMINED USING MANUFACTURERS SPECIFICATIONS WITH OVERFLOW PROVISIONS BY

-PIPES TO HAVE 1% MIN.GRADE U.N.O. BY PIT INVERTS. PIPES TO BE V.C. CLASS 'X' OR U.P.V.C. CLASS STORMWATER PIPE TO AS1254,1260,1273,1477,2179.2 AND WHERE EXPOSED TO DIRECT SUNLIGHT TO HAVE ADEQUATE PROTECTION TO U.V. RADIATION IN

ACCORDANCE WITH AS2032. SEWER GRADE/GAL. PIPES AND KERB ADAPTORS TO BE USED WHERE COUNCIL POLICY OR CONSENT REQUIRE SUCH. —GUTTER OUTLETS SHALL BE FITTED VERTICALLY TO THE SOLE OF THE EAVE GUTTERS. RAINHEADS TO HAVE AN OVERFLOW DUCT OR

WEIR 50mm BELOW THEIR CREST. -PROVIDE OVERFLOW SPITTERS TO ALL COVERED BALCONIES/ TERRACES. NOT TO BE DIRECTED ON TO ROOF SURFACES -RISING MAINS (PRESSURE PIPE) TO BE IN ACCORDANCE WITH

AS3500.1:2.

-SUBSOIL DRAINS TO BE IN ACCORDANCE WITH AS2439.1 CLASS
100 TO BE USED ONLY IN SINGLE DWELLINGS.

-ALL PIPE JOINTS, VALVES TO BE IN ACCORDANCE WITH
AS3500.3.2:2.7 & AS3500.3.2

-EXPANSION JOINTS SHALL COMPLY WITH AS3500.3.2:TABLE 4.1 PVC

JOINTS AND ACCESSORIES TO COMPLY WITH AS2179.2 & AS4198. -ALL TRENCHES TO BE IN ACCORDANCE WITH AS3500.3.2:7.2.8-14. EMBEDMENT MATERIAL AND TRENCH FILL TO ALL PIPES & SUBSOIL, DRAINS TO BE IN ACCORDANCE WITH AS3500.3.2:7, ALL WORKS TO BE IN ACCORDANCE WITH AS1254, 1741, 2032, 2733, 2865, 3996, 1260, 1477, 2179.1 & 2,2566, 6367, 8301, ARR97

& BCA.

IT IS THE BUILDER'S RESPONSIBILITY TO CONFIRM THAT LEVELS

AND SURVEYS ARE IN ACCORDANCE WITH LEVELS ON SITE & ARE

APPROVED BY COUNCIL & ARCHITECT BEFORE COMMENCING WORK.

NO SEWER VENTS, GULLY PITS OR SIMILAR TO BE LOCATED BELOW THE MAXIMUM WATER SURFACE LEVEL IN DETENTION BASINS. ALL BASIN WALLS TO BE WATERTIGHT & STRUCTURALLY DESIGNED BY A STRUCTURAL FNGINFFR.

-ALL FENCES WHICH MAY DIVERT FLOW FROM PROPOSED DIRECTION TO BE RAISED 100mm.

-BUILDER TO ENSURE ALL DRAINAGE AREAS INCLUDING EXPOSED BALCONIES TO HAVE OVERFLOW MECHANISM IN PLACE IN THE EVENT OF BLOCKAGE WITH ADEQUATE OVERFLOW SECTION THROUGH PLANTERS, PARAPETS ETC.

ALL EXTERIOR FINISHED GROUND LEVELS TO BE SLOPING AWAY FROM PERIMETER WALLS IN ALL CASES.

ALL HEADROOM CLEARANCES TO BE COORDINATED BETWEEN BUILDED BY ADDROVAL IS ANY

BUILDER & ARCHITECT. NOTIFY ENGINEER FOR APPROVAL IF ANY

CHANGES OCCUR. -ALL GULLY POSITIONS ARE DIAGRAMMATIC ONLY- BUILDER SHOULD CONSULT ARCHITECTURALS FOR DIMENSIONS TO LOCATE

STORMWATER ELEMENTS U.N.O.

-FIRE RATING TO ARCHITECT'S SPECIFICATION. -ALL FINISHED FLOOR LEVELS ARE NOMINATED BY ARCHITECT. -ALL FINISHED FLOUR LEVELS ARE NOMINATED BY ARCHITECT.
-ALL SITE SAFETY MEASURES AND WORK METHOD STATEMENTS
PREPARED BY BUILDER/SUB-CONTRACTORS ARE TO BE
IMPLEMENTED DURING CONSTRUCTION. NO WORK IS TO COMMENCE
UNTIL ALL WORKERS CARRY OUT SITE INDUCTION, PREPARED AND
CARRIED OUT BY BUILDER. ANY HAZARD IDENTIFICATION TO BE REPORTED IMMEDIATELY TO SITE SUPERVISOR TO CARRY OUT NECESSARY PROCEDURES TO ELIMINATE HAZARD, PRIOR TO PROCEEDING WITH WORK. STRUCTURAL AND GEOTECHNICAL ADVICE SHOULD BE SOUGHT IN ALL CASES.

—CONFINED SPACES SIGNAGE TO BE INSTALLED IN ACCESSIBLE UNDERGROUND TANKS TO WORK COVER SPECIFICATIONS. ALL PITS

EXCEEDING 600mm DEPTH TO HAVE 'J' BOLTS OR SIMILAR INSTALLED TO GRATES.

-MAINTENANCE DEVICES REQ'D BY AUTHORITIES ARE NOT TO BE ASSUMED SHOWN ON DRAWINGS.
—EARTH MOUNDING SHOWN AS TEMPORARY MEASURE UNTIL

LANDSCAPING COMPLETED TO DIRECT FLOWS AS SHOWN.

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	Δ	Garage level raised per			

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ISSUE PRINTS		ISSUED TO	DATE
1	EMAIL	BUILDER/CLIENT	8-4-22
2	EMAIL	BUILDER/CLIENT	21-10-22
3	EMAIL	BUILDER/CLIENT	3-7-23

D

SCALE(A3) 1:200, 100 u.n.o. SCALE BAR - 1m INTERVALS DATE MARCH . 2022 DRAWN M./. DESIGNED M./.

APPROVED



IBRAHIM STORMWATER CONSULTANTS

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PROPOSED RESIDENCE AT 140 ALFRED STREET, HARRIS PARK FOR MRS LAURA ROUMANOUS

CLEANING EYE

GROUND FALL

100 HIGH EARTH MOUNDING

THIS DRAWING STORMWATER


JOB NUMBER LAYOUT SH.1 M10639-606567

BUILDER SHEET No. MJH HOMES

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TANK DETAILS SHOWN ARE A SUGGESTED CONFIGURATION ONLY. ANY MODIFICATIONS TO TANK VOLUME OR INLET AND OUTLET LEVELS MUST BE APPROVED BY ENGINEER PRIOR TO COMMENCEMENT OF CONSTRUCTION. TANK SHAPE, & DEVICES SHOWN ARE DIAGRAMMATIC ONLY. MINIMUM OF 450 CLEARANCE (UNLESS L.G.A. REQUIRES LARGER SETBACK) TO SIDE BOUNDARIES MUST BE MAINTAINED. CLIENT IS RESPONSIBLE TO ENSURE COMPLIANCE WITH THIS IN THE INSTALLED STATE. Charged stormwater lines from Roof Areas ONLY to rainwater tank.


All joints to be solvent welded. All exposed pipework to be painted to withstand external elements.

First flush water diverter at tank to comply with Water Authority and council DCP's. An approved switch system similar to 'Rainbank' to be used via mains. Pumps to manuf. specs. Rain Tank to be installed and maintainted to manufacturers specifications and to comply with all Water Authority Guidelines.

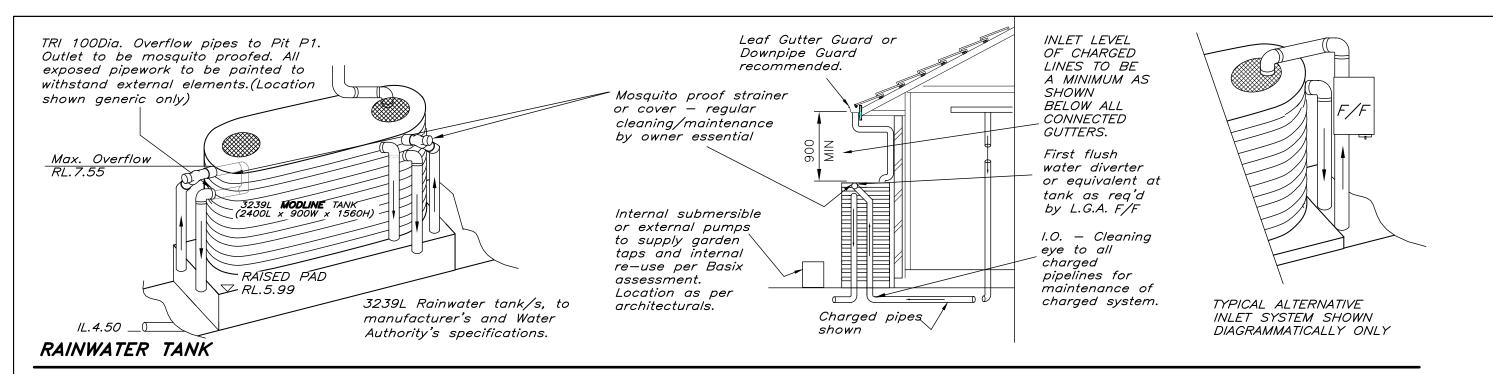Client to be responsible for maintenance system of charged pipelines. Debris accumulation significantly affects systems performance. Maintenance program essential. Structural details for tank base by manufacturer or others.

WHSA HAZARD IDENTIFICATION:

INSTALLATION OF RAINTANKS: PLUMBER/SITE SUPERVISOR TO ASSESS ACCESS SUITABILITY PRIOR OR POST SLAB CONSTRUCTION. INSTALLATION OF TANKS TO BE CARRIED OUT FOLLOWING SWMS OF TANK SUPPLIER AND PLUMBER. APPROPRIATE GLOVES TO BE WORN AT ALL TIMES WHILE HANDLING TANKS.

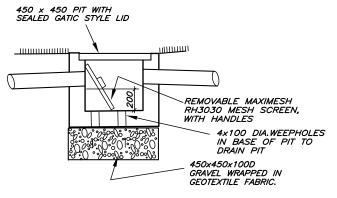

SILT ARRESTOR PIT - P1

WHSA
ALL NEARBY SERVICES TO BE LOCATED PRIOR EXCAVATIONS.
ALL PIPES TO BE CUT FLUSH WITH PIT WALLS AND SPARGED.
PITS EXCEEDING 600mm IN DEPTH TO HAVE LOCK DOWN MECHANISM.
SAFETY GEAR TO BE WORN AT ALL TIMES. INCLUDING FOOTWEAR, CLOTHING
AND GLOVES AS PER SWMS.

THIS DRAWING IS DIAGRAMMATIC ONLY & NOT TO BE SCALED. IT IS NOT A PART 4A CERT REPRODUCED OR COPIED, WHOLE OR IN PART, IN ANY F

BUILDER/CLIENT TO ENSURE THAT ALL SAFETY MEASURES ARE TAKEN DURING CONSTRUCTION, INCLUDING BUT NOT LIMITED TO, FENCING, SIGNAGE, OBTAINING STRUCTURAL AND GEOTECH ADVICE WHERE EXCAVATIONS ARE NEAR STRUCTURES OR SAFETY MEASURES RECOMMENDED BY PRODUCT SUPPLIE

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CHNICAL R SERVICES.	В	ARCHT. REVISIONS
RS ETC.	Α	Garage level raised per archt.

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PROPOSED RESIDENCE AT 140 ALFRED STREET, HARRIS PARK FOR MRS LAURA ROUMANOUS

THIS DRAWING STORMWATER DETAILS SH.1

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