14 Windermere Avenue, Northmead

Proposed Child Care Centre

DRAWING SCHEDULE:

A000 - COVER PAGE

A001 - CALCULATIONS PAGE / LEP MAPS

A002 - SITE CONTEXT PLAN

A003 - DEMOLITION PLAN

A004 - SITE ANALYSIS PLAN

A005 - LOWER GROUND FLOOR PLAN

A006 - GROUND FLOOR PLAN

A007 - FIRST FLOOR PLAN

A008 - NORTH (STREETSCAPE) & EAST ELEVATIONS

A009 - WEST & SOUTH ELEVATIONS

A010 - SECTION

A011 - PERSPECTIVES

A012 - CUT AND FILL PLAN

A013 - SHADOW DIAGRAMS

A014 - COVERED OUTDOOR AREA DIAGRAMS

A015 - EMERGENCY EVACUATION PLAN - LOWER GROUND FLOOR

A016 - EMERGENCY EVACUATION PLAN - FIRST FLOOR

A017 - COLOUR AND FINISHES SCHEDULE





		AMENDMENTS		Duning Tiller	DRAWING TITLE:	CLIENT DETAILS:
IS	SSUE: DESCRI	PIPTION	DATE:	Project Title:	Cover Page	Barakat
┝				Proposed Child Care	2 2 7 2 7 7 2 9	
				Centre		LOCAL GOVERNMENT AREA:
				•	ADDRESS:	Parramatta Council
				•	14 Windermere Avenue, Northmead	Issue For: DA
⊢						Date: Scale: Dr

GENERAL NOTES

SCALE FROM DRAWINGS.

COORDINATION AND INFORMATION.

CONNECTION WITH THE SERVICE.

OF THE STRUCTURAL ENGINEER.

IMMEDIATELY FOR CLARIFICATION.

TO BE ORGANISED AND REVIEWED BY THE CLIENT.

STRUCTURAL ENGINEER.

POTENTIAL PERFORMANCE SOLUTION PROPOSED.

5. DRAWINGS ARE NOT COORDINATED BY JANSSEN DESIGNS

CONDITIONS AND DOCUMENTS NEED TO BE COORDINATED AND CHECKED TO CONFIRM THEY SATISFY THE AUSTRALIAN STANDARDS

SPECIALIST DISABILITY ACCOMMODATION, DESIGN FOR DISABILITY ACCOMMODATION, DEVELOPMENT APPLICATION REQUIREMENTS, THORC, BCA CODES AND CONTROLS THAT APPLY TO THIS PROJECT. A

COORDINATED CONSTRUCTION SET MAY VARY FROM THE PRODUCED DRAWINGS. JANSSEN DESIGNS DOES NOT ACCEPT ANY LIABILITY,

DIRECT OR INDIRECT, FOR ANY LOSS LIABILITY OR LOSS SUFFERED OR INCURRED BY ANY PERSON OR THIRD PARTY PLACING ANY RELIANCE

6. ALL STRUCTURAL ELEMENTS ARE SHOWN INDICATIVELY AND ARE TO

BE CONFIRMED WITH THE DESIGN, DETAIL AND SPECIFICATION OF THE

7. ALL STRUCTURAL FRAMING, LOADING, BEARING, RETAINING AND FIXING OF ELEMENTS ARE TO THE DESIGN, DETAIL AND SPECIFICATION

8. ALL SERVICES ELEMENTS INCLUDING HYDRAULICS, ELECTRICAL, MECHANICAL, FIRE AND COMMUNICATION SERVICES SHOWN ARE

INDICATIVE ONLY. REFER TO SERVICES CONSULTANT SEPARATE DOCUMENTATION AND SPECIFICATION FOR DETAILED DESIGN.

9. ANY DISCREPANCIES BETWEEN ARCHITECTURAL CONSULTANT DOCUMENTATION ARE TO BE REPORTED TO THE ARCHITECT

10. ALL CONCRETE AND METALWORK ITEMS, SUCH AS SHOP DRAWINGS,

ON THE SERVICES OR DOCUMENTS OR ADVICE ARISING IN

1. CONTRACTOR MUST VERIFY ALL DIMENSIONS ON SITE BEFORE COMMENCING WORK OR PREPARING SHOP DRAWINGS. DO NOT

NATIONAL CONSTRUCTION CODE (NCC), BUILDING CODE OF

2. ALL BUILDING WORKS SHALL BE IN ACCORDANCE WITH THE RELEVANT

AUSTRALIA (BCA), RELEVANT AUSTRALIAN STANDARDS (AS), INCLUDING AMENDMENTS AND THE REQUIREMENTS OF COUNCIL AND PRIVATE CERTIFIERS (PC) AND OTHER AUTHORITIES HAVING JURISDICTION.

3. THE ARCHITECTURAL DRAWINGS ARE TO BE READ IN CONJUNCTION WITH ALL RELEVANT CONSULTANT DRAWINGS AND REPORTS FOR

4. THRESHOLDS AND DOORWAYS ARE FLUSH FOR WHEELCHAIR ACCESS IN ACCORDANCE WITH AS 1428.1 DESIGN FOR ACCESS AND MOBILITY. REFER TO ACCESS CONSULTANT REPORT FOR DISPENSATIONS AND

COMPLIANCE TABLE

TOTAL SITE AREA 1,322.00m2

MAX BUILDING HEIGHT 9

PROPOSED BUILDING HEIGHT 8.9M - COMPLIES

MAXIMUM FLOOR SPACE RATIO0.5:1 | 661m2PROPOSED FLOOR SPACE RATIO0.49:1 | 659m2

CHILDCARE

NUMBER OF CHILDREN:

0-2 YEARS - 20 PLACES 2-3 YEARS - 30 PLACES 3-6 YEARS - 38 PLACES

TOTAL - 88 PLACES

NUMBER OF TEACHERS:

0-2 YEARS - 5 TEACHERS @ 1:4 RATIO 2-3 YEARS - 6 TEACHERS @ 1:5 RATIO 3-6 YEARS - 4 TEACHERS @ 1:10 RATIO

INDOOR PLAY AREA:

0-2 YEARS - 70m2 @ 3.50m2 / KID 2-3 YEARS - 100m2 @ 3.33m2 / KID 3-6 YEARS - 165m2 @ 4.30m2 / KID

TOTAL INTERNAL AREA: 310.3m2 | 3.52m2 PER CHILD - COMPLIES


OUTDOOR PLAY AREA:

TOTAL AREA - 627m2 @ 7.125m2 / KID - COMPLIES


MINIMUM REQUIRED INTERNAL STORAGE VOLUME: 17.6m3 | 0.2m3 PER CHILD PROPOSED INTERNAL STORAGE VOLUME: 34.56m3 | 0.39m2 PER CHILD - COMPLIES

MINIMUM REQUIRED OUTDOOR STORAGE VOLUME: 26.4m3 | 0.3m3 PER CHILD PROPOSED OUTDOOR STORAGE VOLUME: 35.69m3 | 0.40m3 PER CHILD - COMPLIES


ZONING - R2 LOW DENSITY RESIDENTIAL

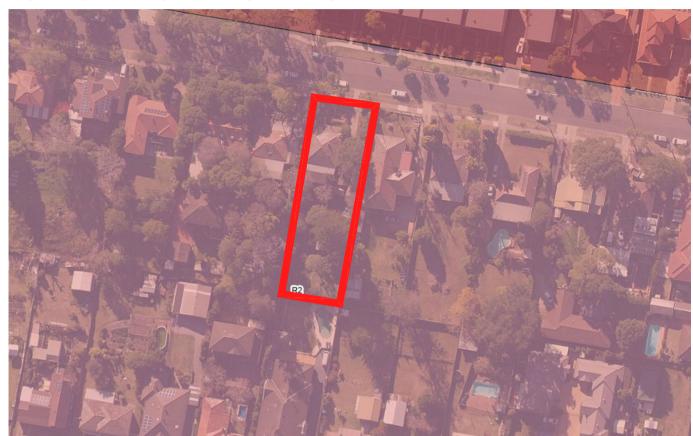

MAXIMUM BUILDING HEIGHT - 9M

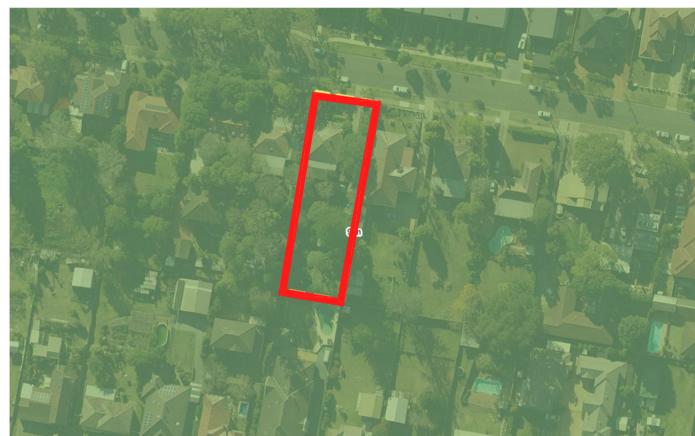

BUSHFIRE - N/A

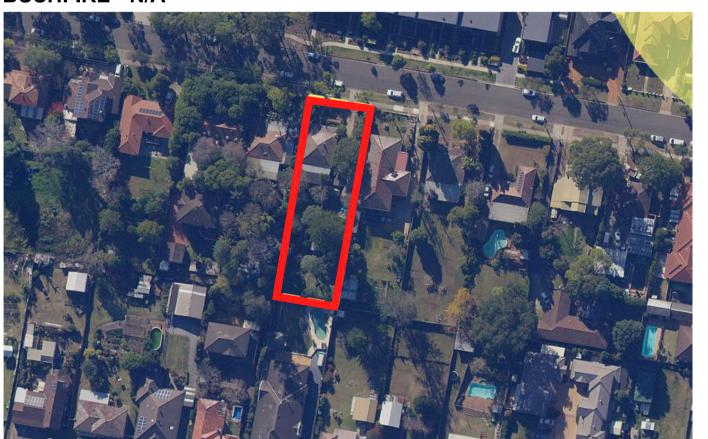

FLOOR SPACE RATIO - 0.5:1 (AS PER CHILDCARE DESIGN GUIDELINE)



HERITAGE - N/A





AMENDMENTS		- Project Title:
E: DESCRIPTION	DATE:	<u> Project Title: </u>
		 Proposed Child Care
		•
		[—] Centre
		0011110
		_

DRAWING TITLE:

Calculations and LEP

Controls

ADDRESS:
14 Windermere Avenue,
Northmead

CLIENT DETAILS:

Barakat

LOCAL GOVERNMENT AREA:

Parramatta Council

NOTE: ALL WORK TO BE CARRIED OUT IN ACCORDANCE WITH BCA, SAA & COUNCILS CONDITIONS COPYRIGHT:. DO NOT SCALE OFF ARCHITECTURAL DRAWINGS. THESE NOTES MUST BE READ IN CONJUNCTION WITH COLOURS SELECTION FOR ADDITIONAL DETAILS ON APPLIANCES, PCI IEMS & SHOWER SIZES SHOWN ON PLAN ARE INSIDE HOB DIMENSIONS SHOWER SCREENS TO BE FITTED ON INSIDE OF HOB BULKHEADS MAY BE REQUIRED TO ACCOMMODATE DRAINAGE LINES & STEEL BEAMS POSITION TO BE DETERMINED ON SITE. USE FIGURED DIMENSIONS ONLY, DO NOT SCALE. HINISHED GROUND LEVELS ON PLANS ARE SUBJECT TO SITE CONDITIONS, ALL CALCULATED DIMENSIONS ARE SUBJECT TO SITE MEASURE DURING CONSTRUCTION & NO ALLOWANCE HAS BEEN MADE FOR SHRINKAGE OR MILLING POSITION OF ELECTRICAL METER TO BE DETERMINED ON SITE IN ACCORDANCE TO THE TURRET POSITION FRONT GARDEN TAP ON METER ENERGY SMART DESIGN: AAA RATED WATER CONSERVATION DEVICES INCLUDE RAINWATER TANKS SHOWER HEADS, WATER TAP FLOW REGULATORS, DUAL FLUSH TOILETS CISTERNS & COMPLIANT HOT WATER SYSTEMS WITH MINIMUM GREEN HOUSE SCORE OF 3 STARS ARE TO BE USED IN THIS DEVELOPMENT. OCCUPANTS ARE ENCOURAGED TO USE AAA RATED DISH WASHING MACHINES WITH FRONT LOADING WHERE POSSIBLE.

OWNDER/BUILDER MUST READ ALL PLANS IN CONJUNCTION WITH THE ABSA & BASIX REPORT

DO NOT SCALE OFF ARCHITECTURAL DRAWINGS




LANDMARKS

- A CUPA JOES DRIVE THRU
- B WINDSOR ROAD
- C NORTHMEAD EARLY EDUCATION CENTRE
- D NORTHMEAD RESERVE
- E EXCELSIOR RESERVE
- F THE HILLS SCHOOL
- G MYRAI MEDICAL CENTRE
- H NBC SPORTS CLUB
- I COULTER SWIMMING NORTHMEAD
- J SHELL PETROL STATION

SITE CONTEXT PLAN -





	AMENDMENTS		D T'll	DRAWING TITLE:	CLIENT DETAILS:
ISSUE:	DESCRIPTION	DATE:	<u>Project Title:</u> Proposed Child Care	Site Context Plan	Barakat
			Centre - -	ADDRESS:	LOCAL GOVERNMENT AREA: Parramatta Council
				14 Windermere Avenue, Northmead	<u>Issue For:</u> <u>Is</u> <u>Orave</u> <u>Orave</u> <u>Island</u> <u>Orave</u> <u></u>

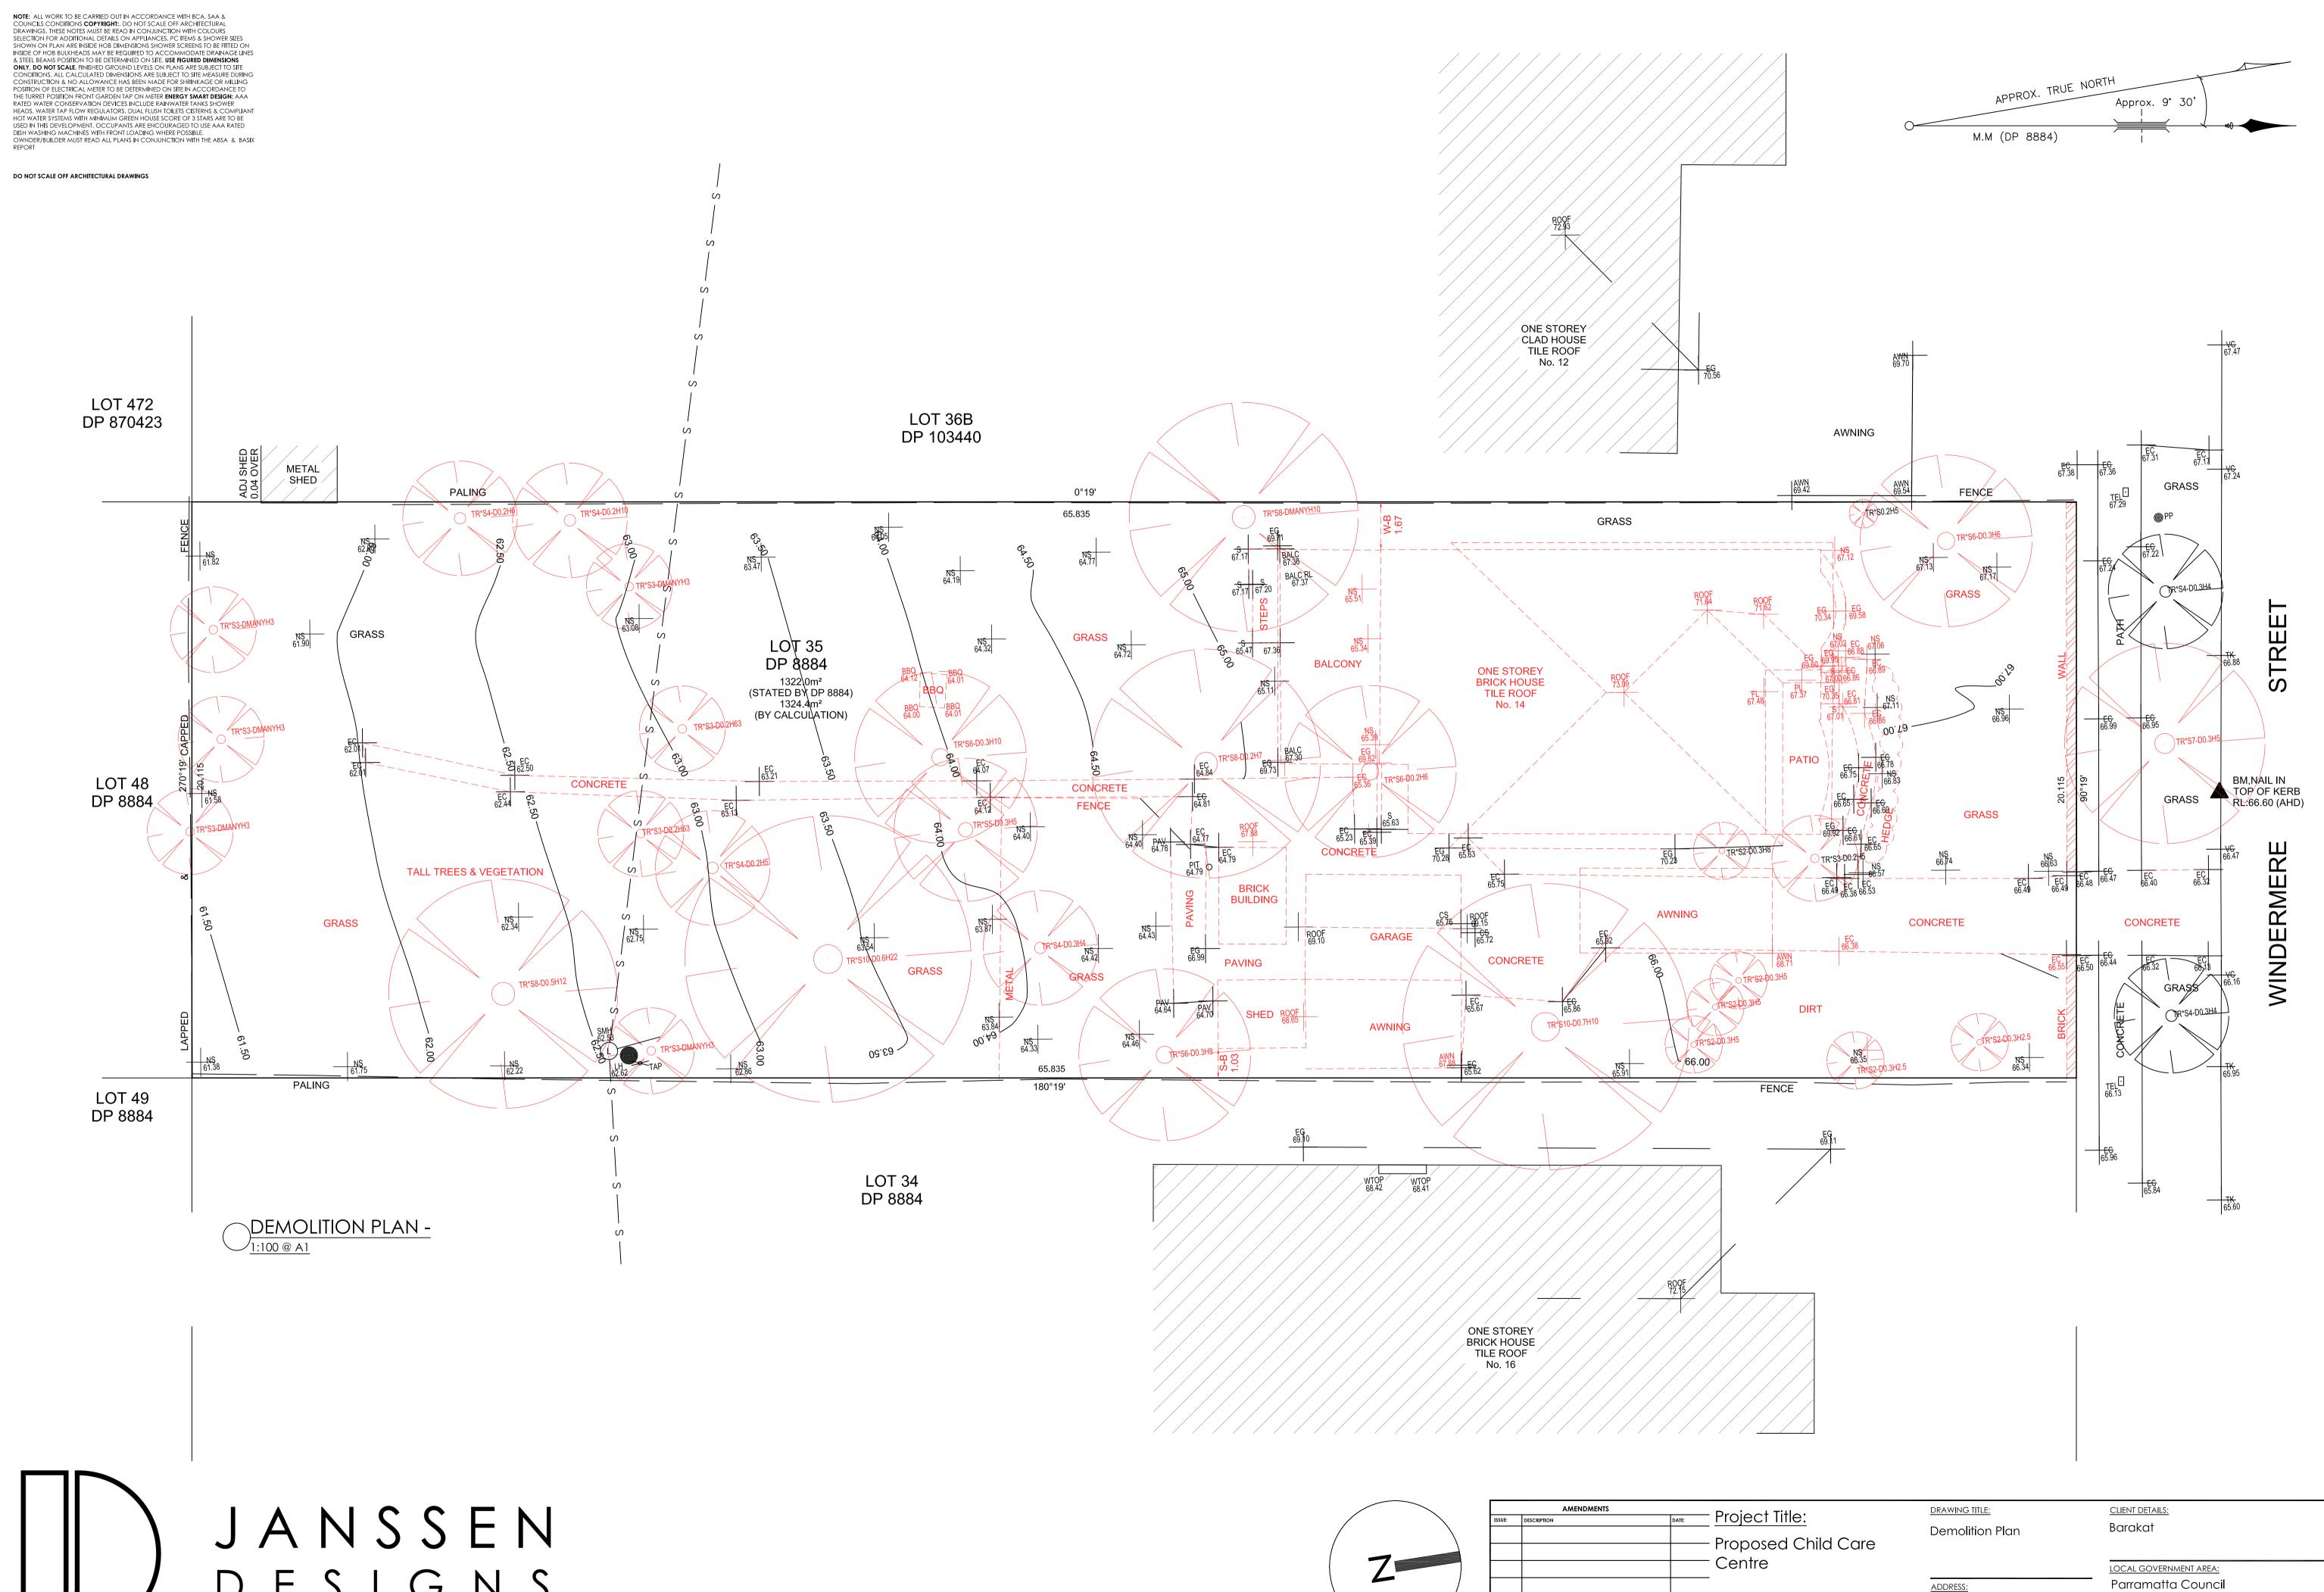








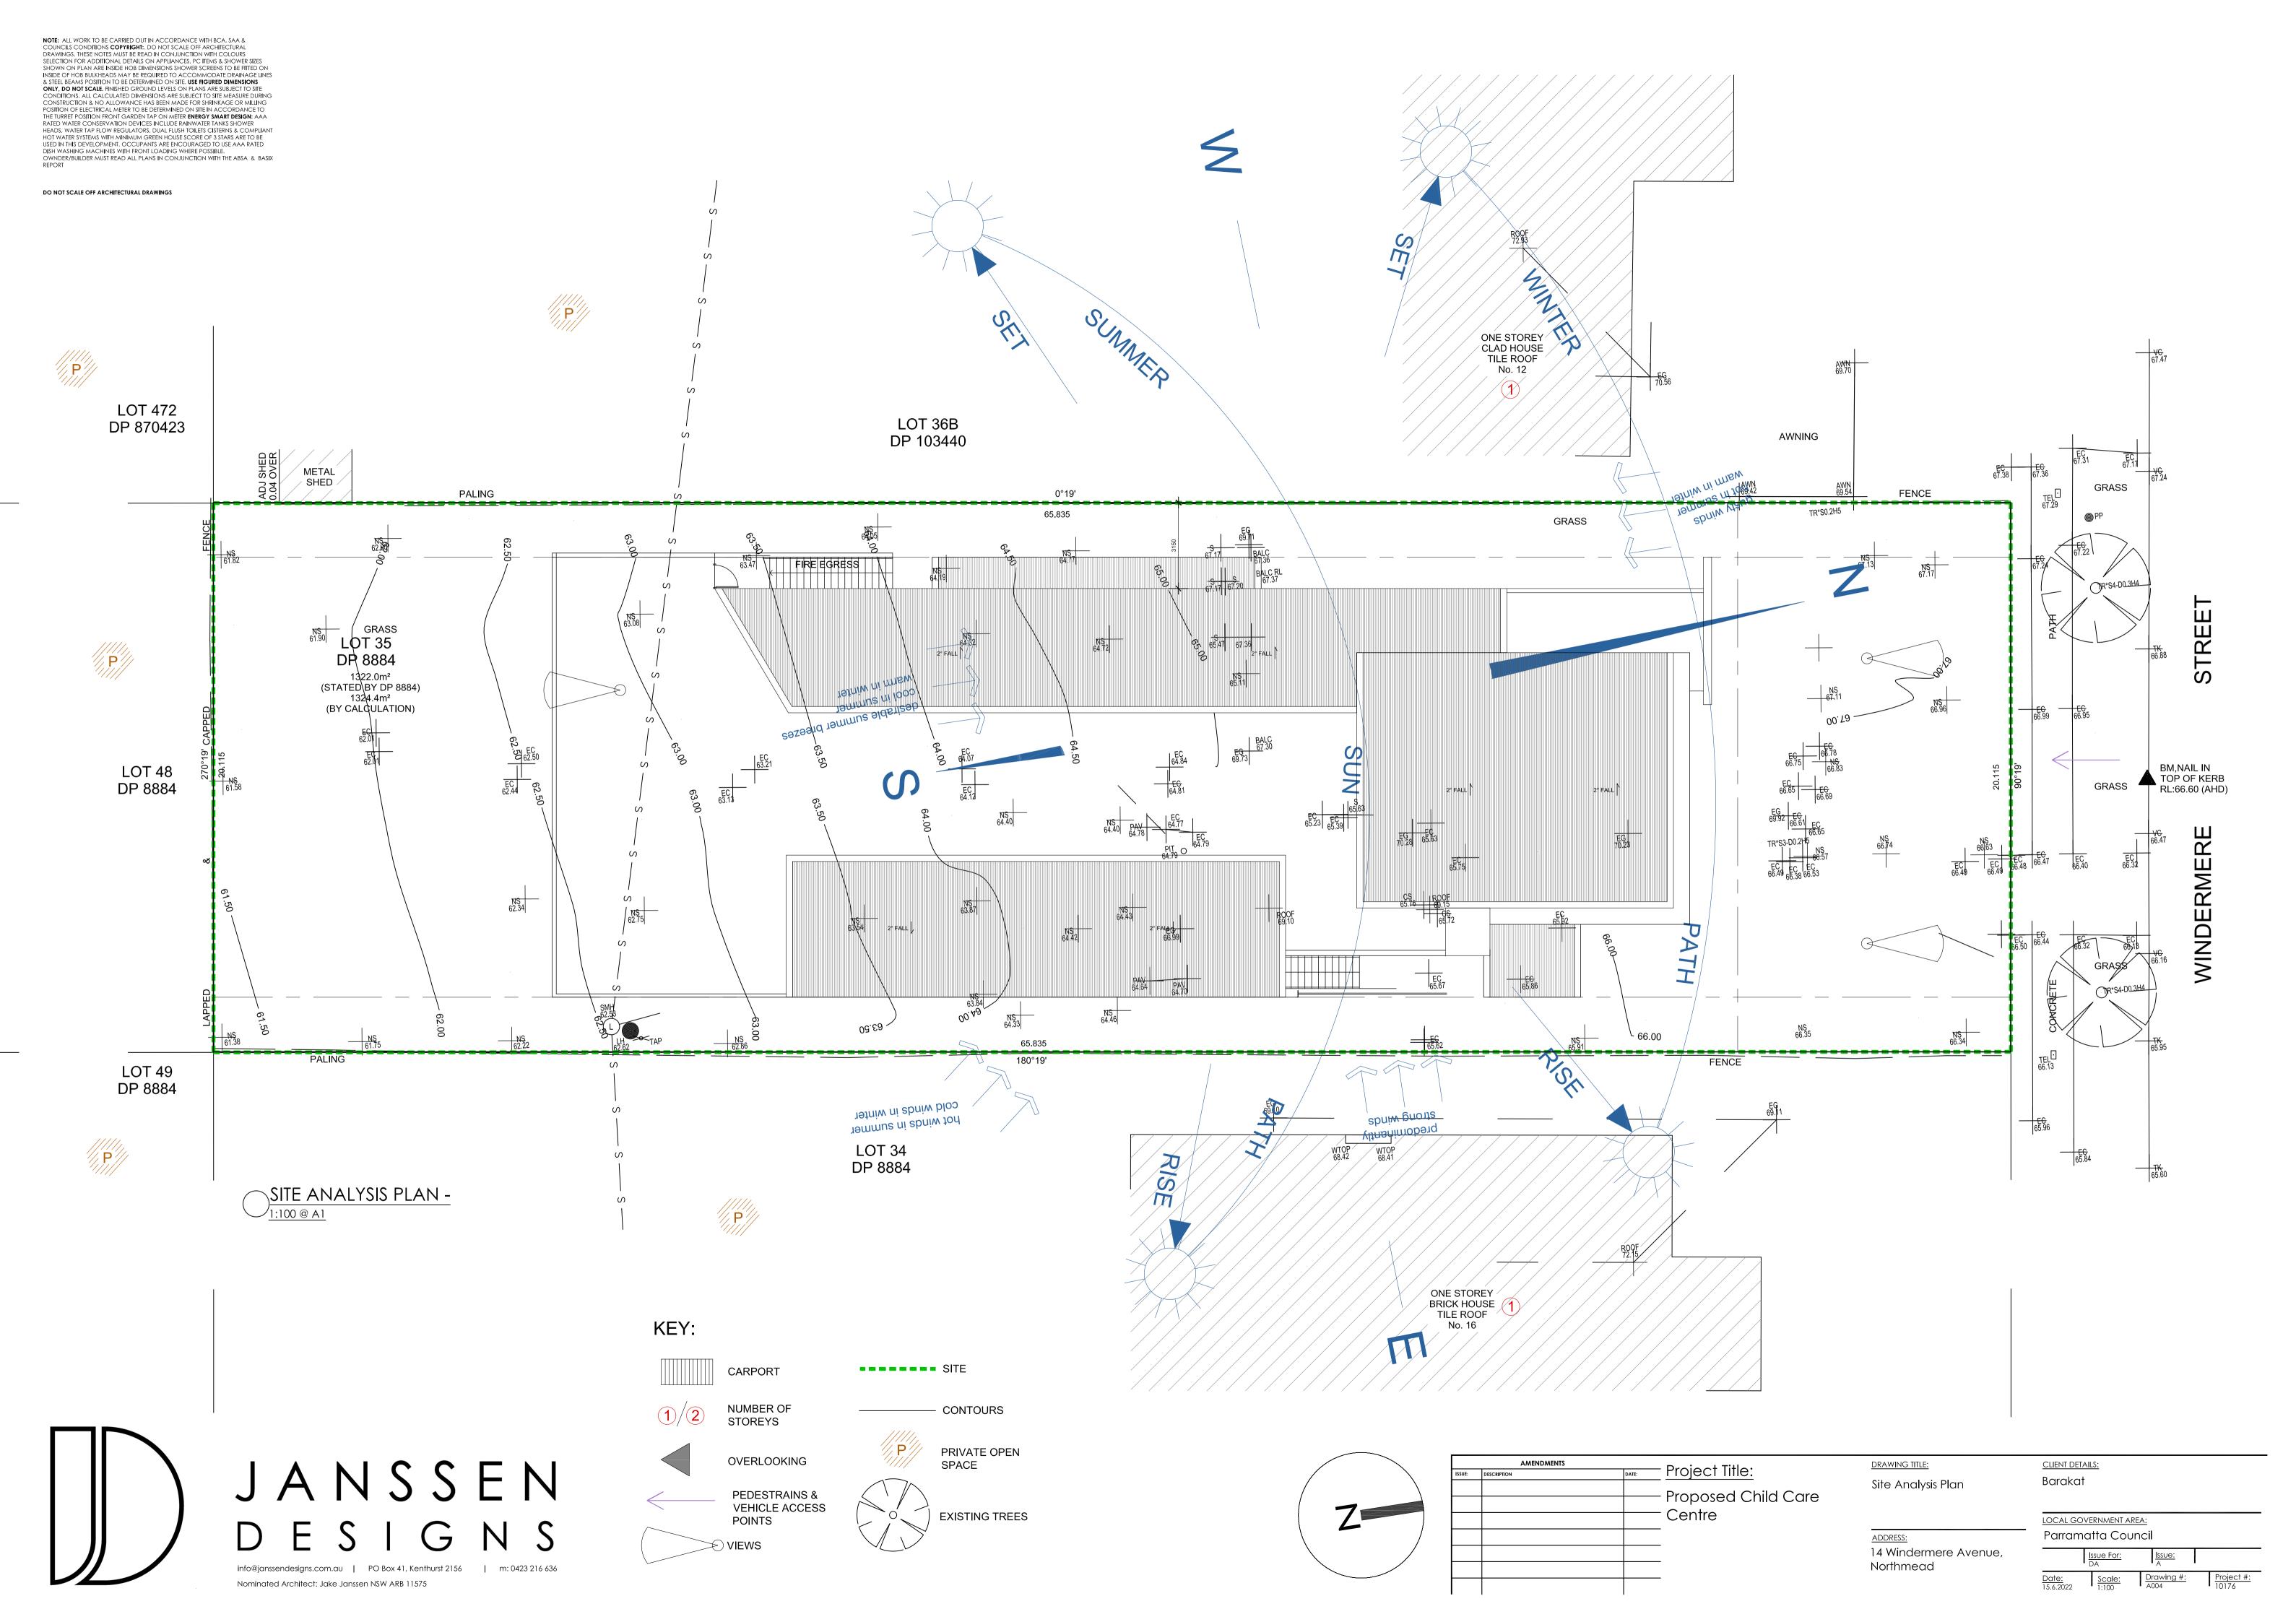


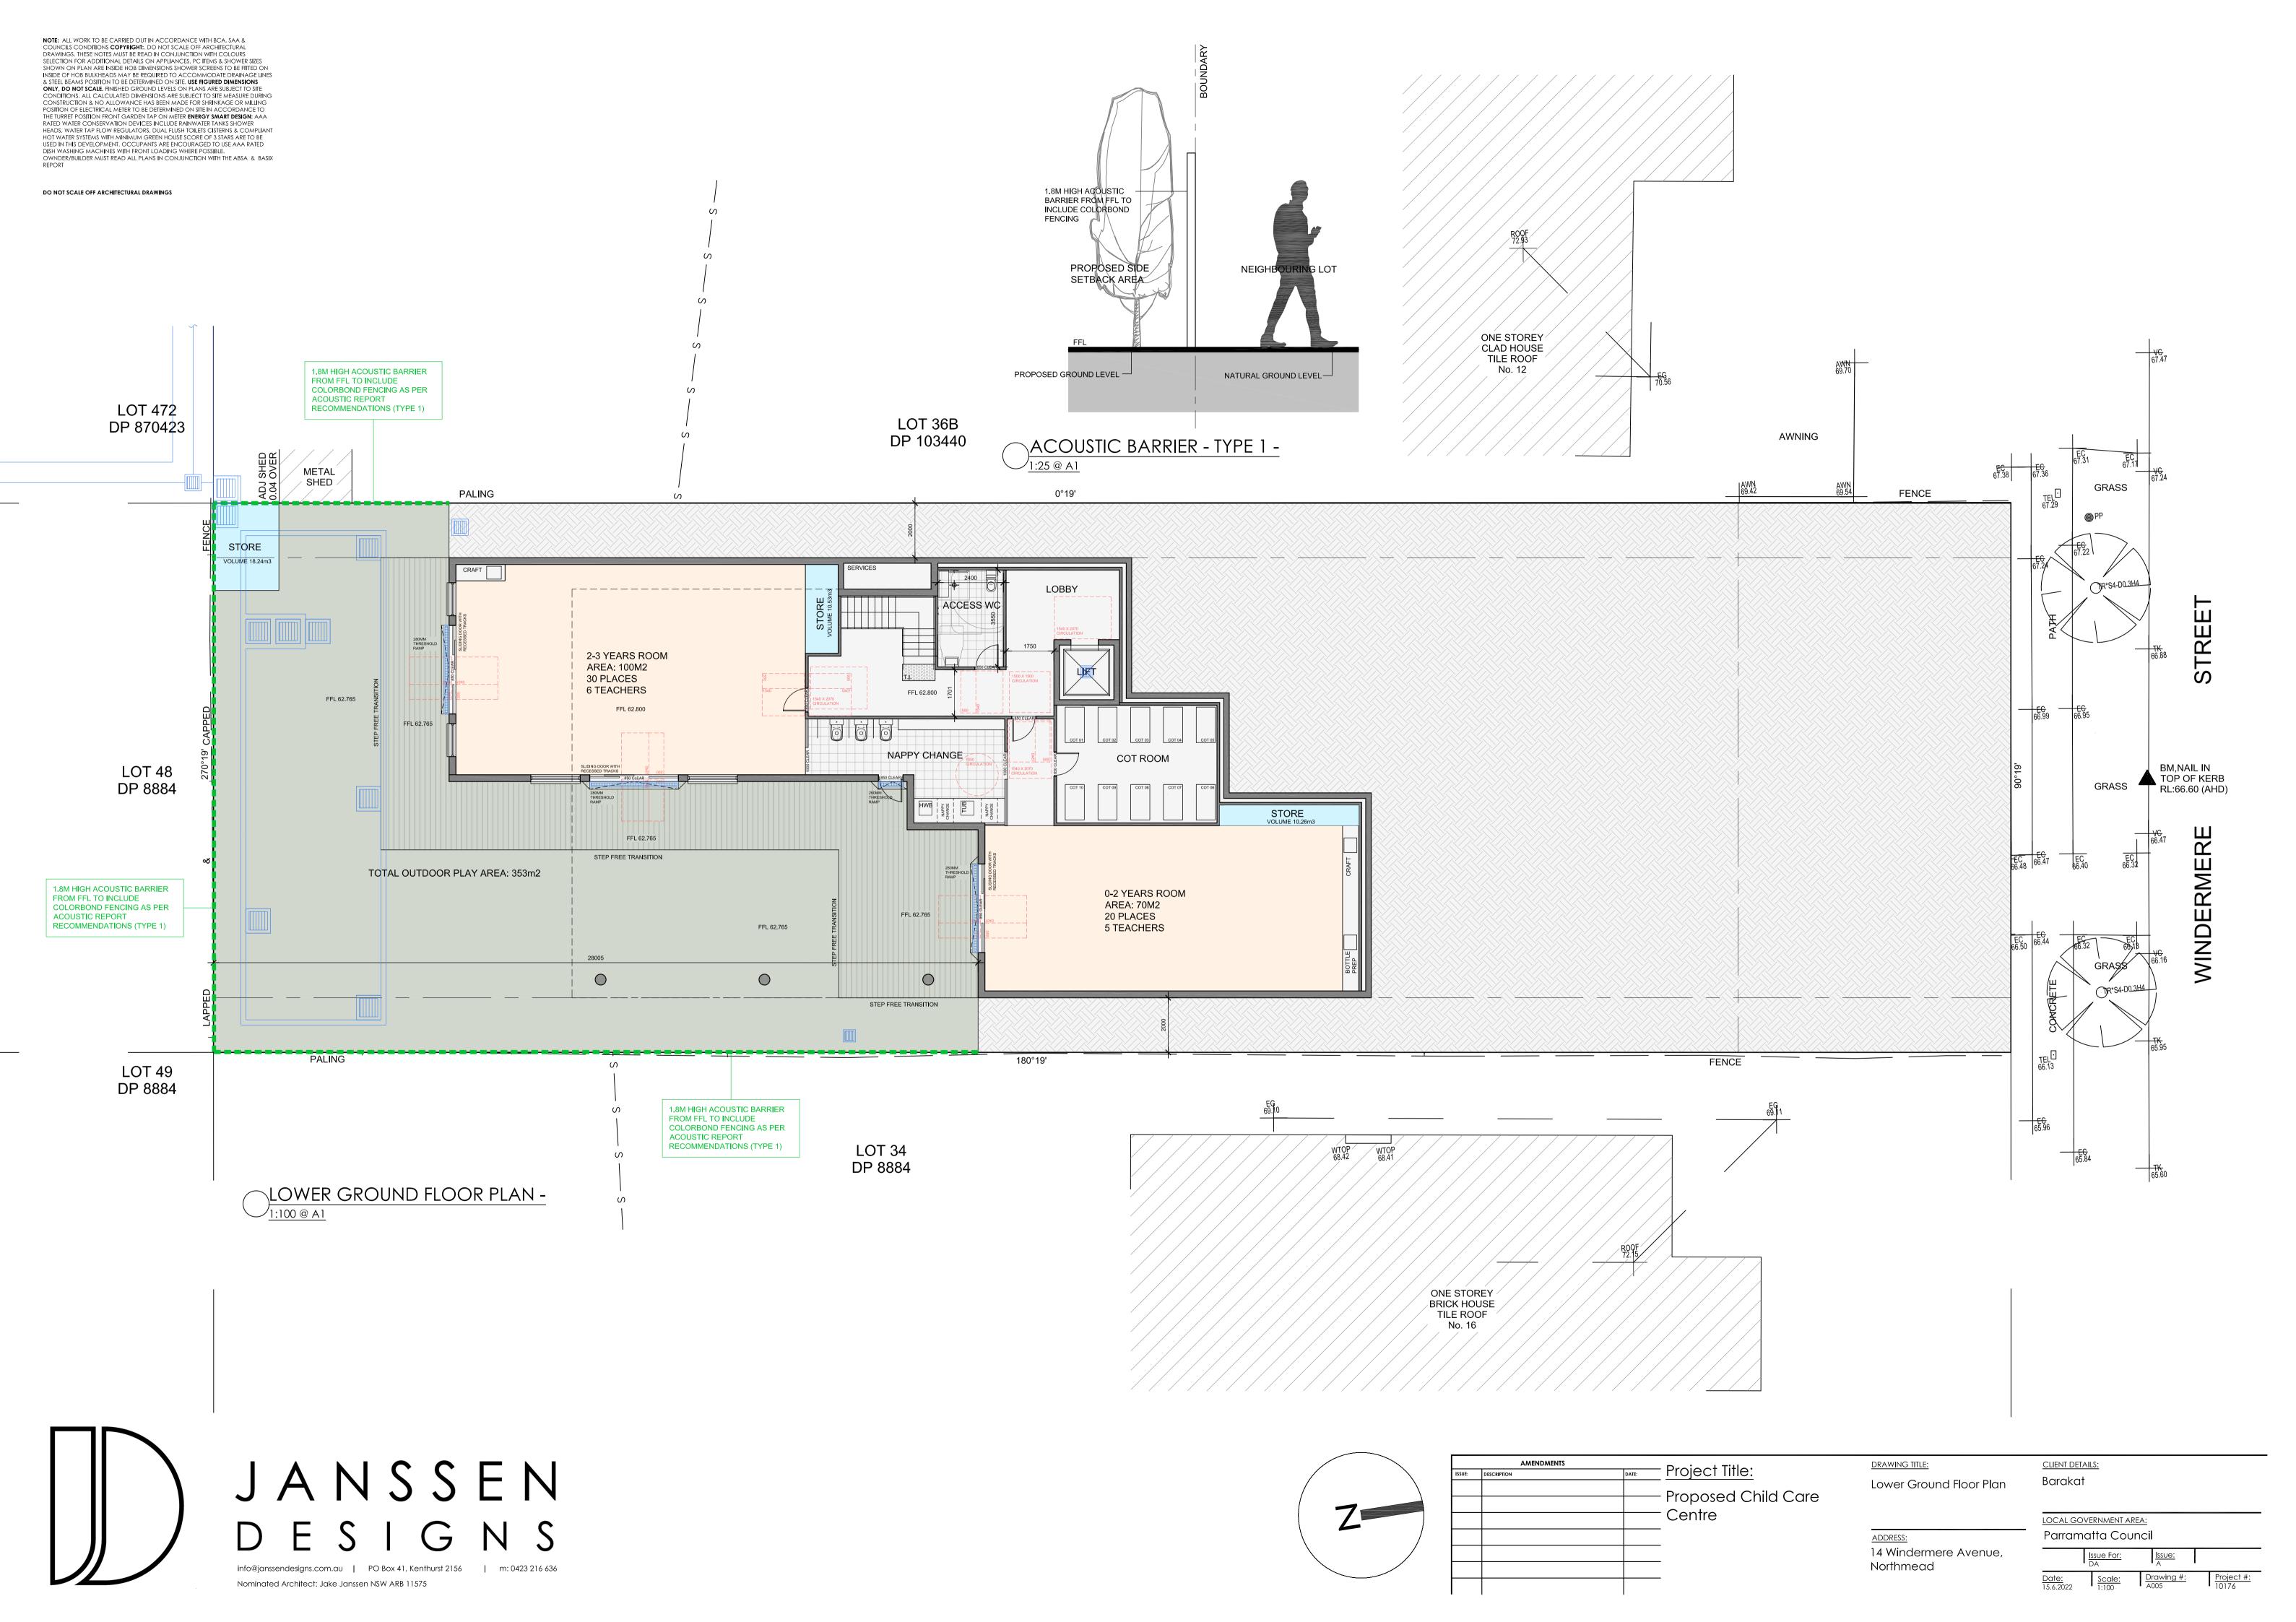

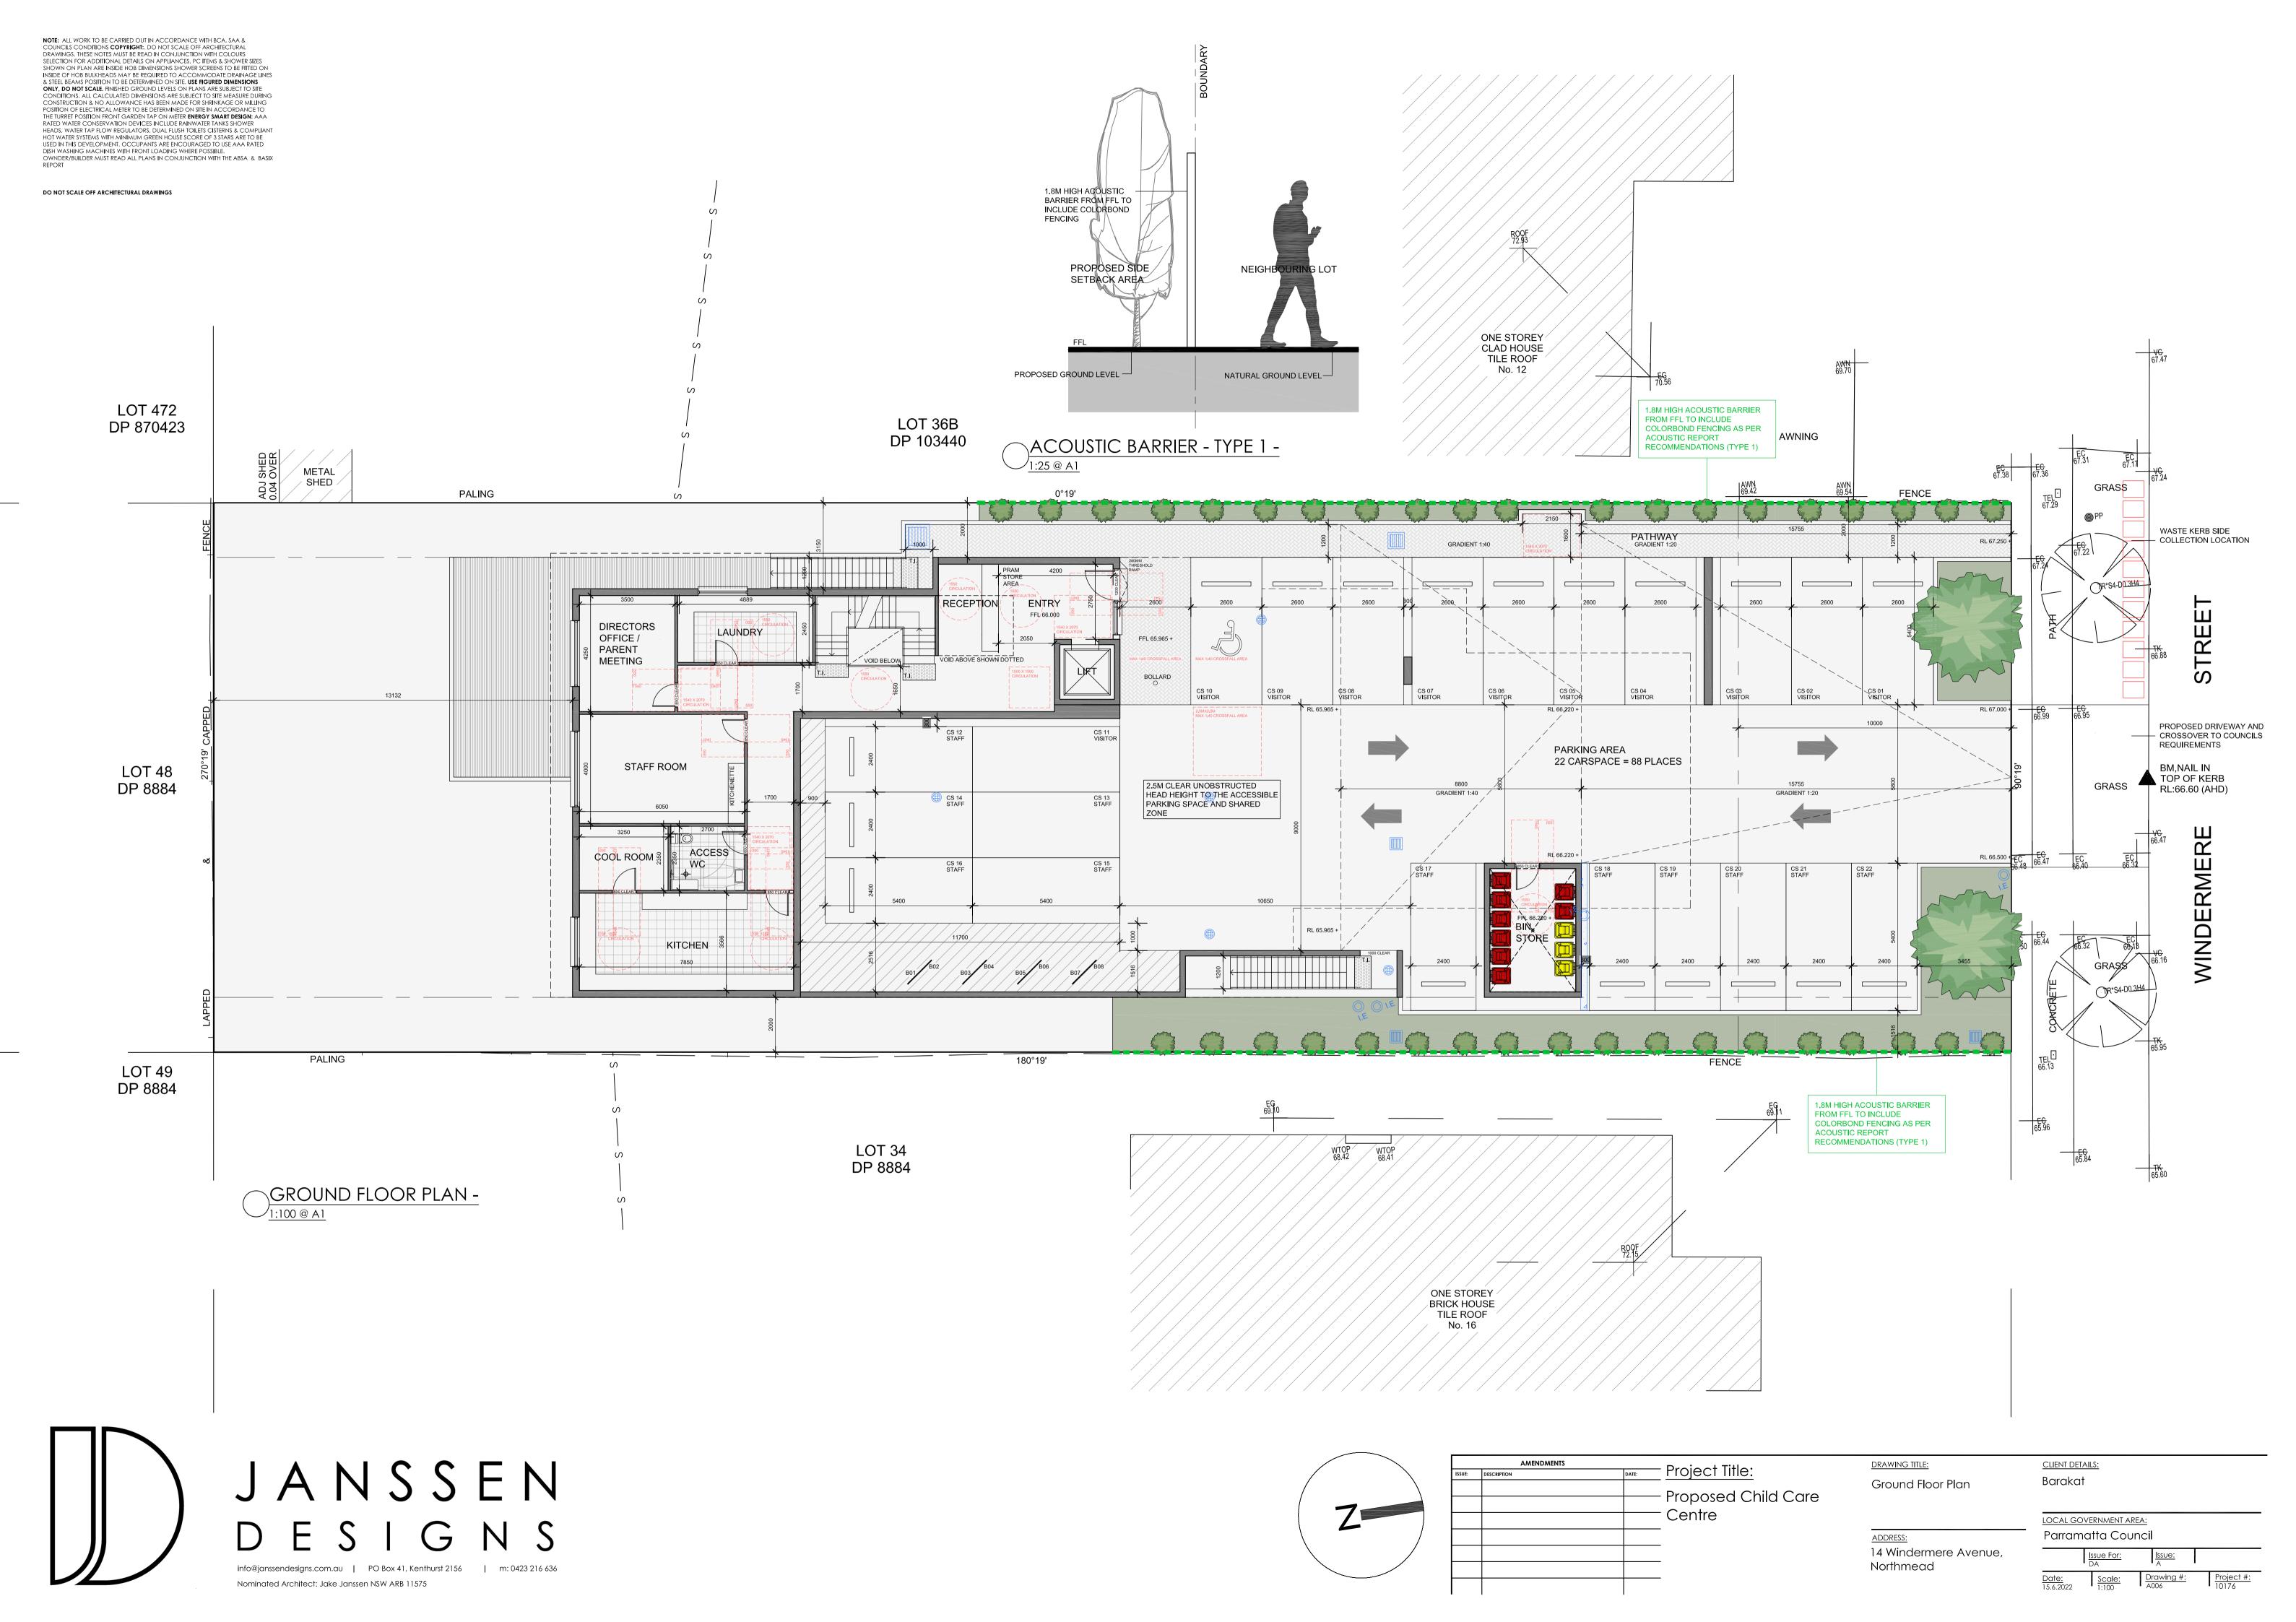

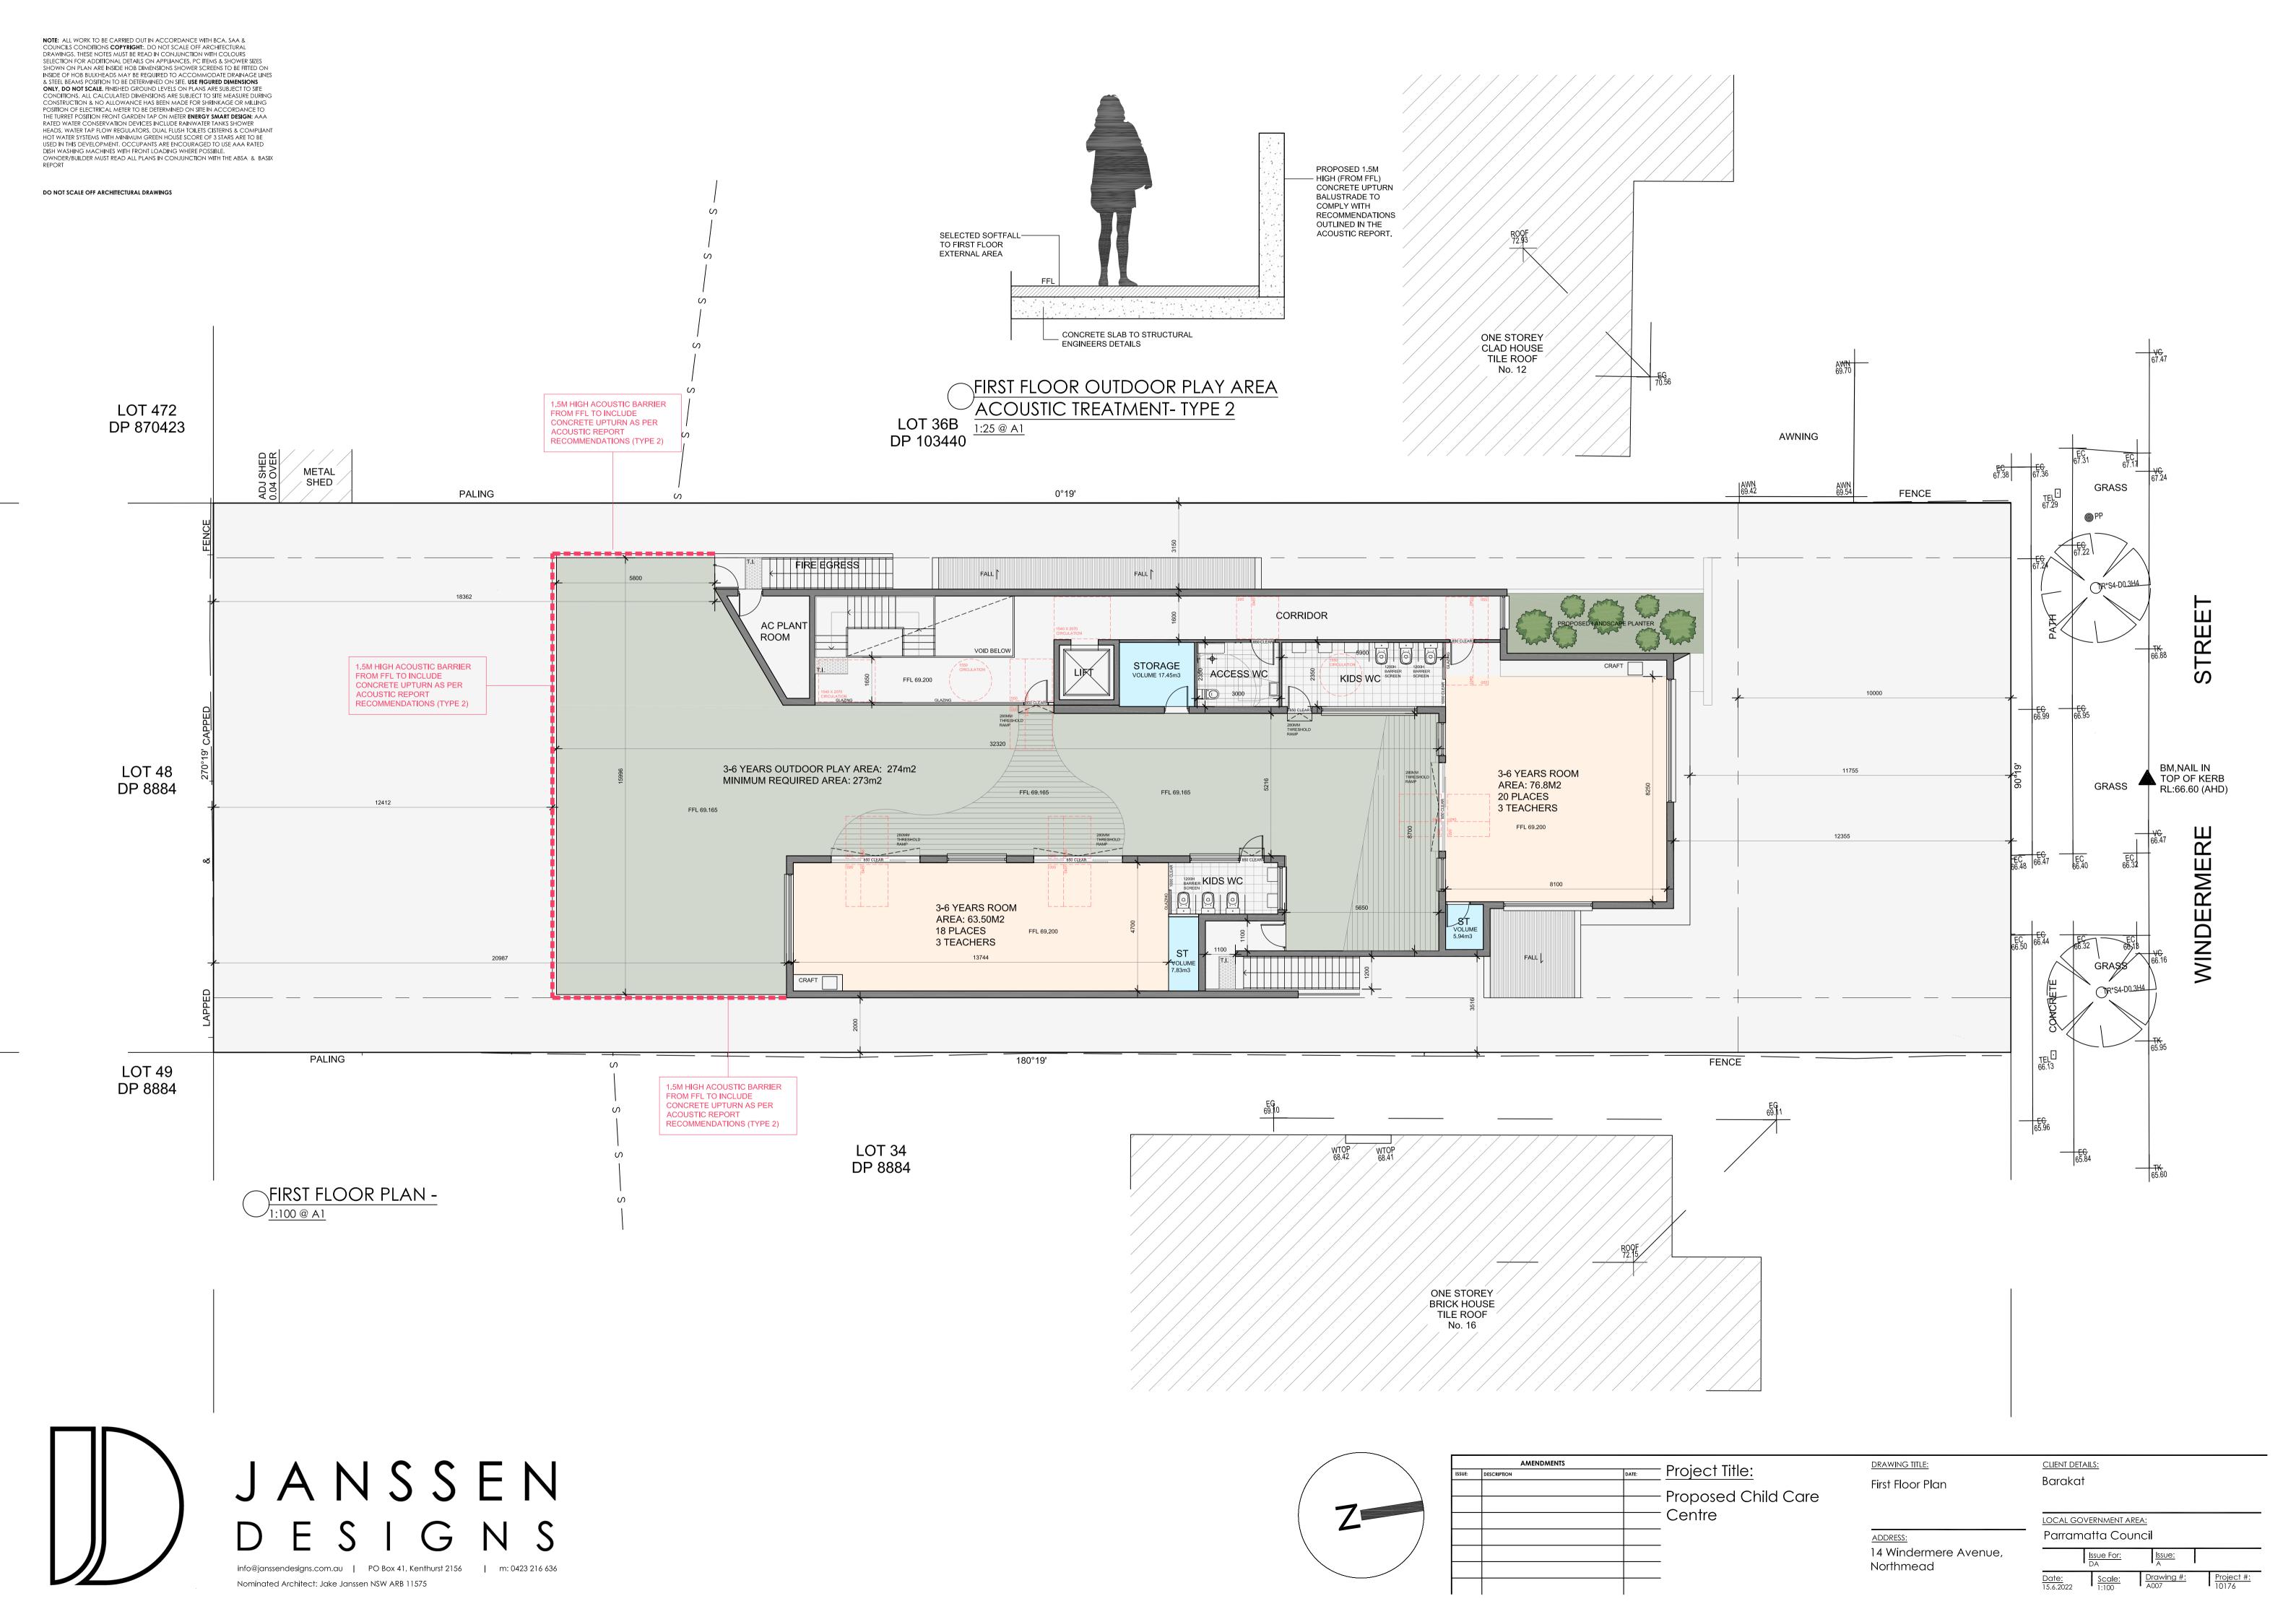


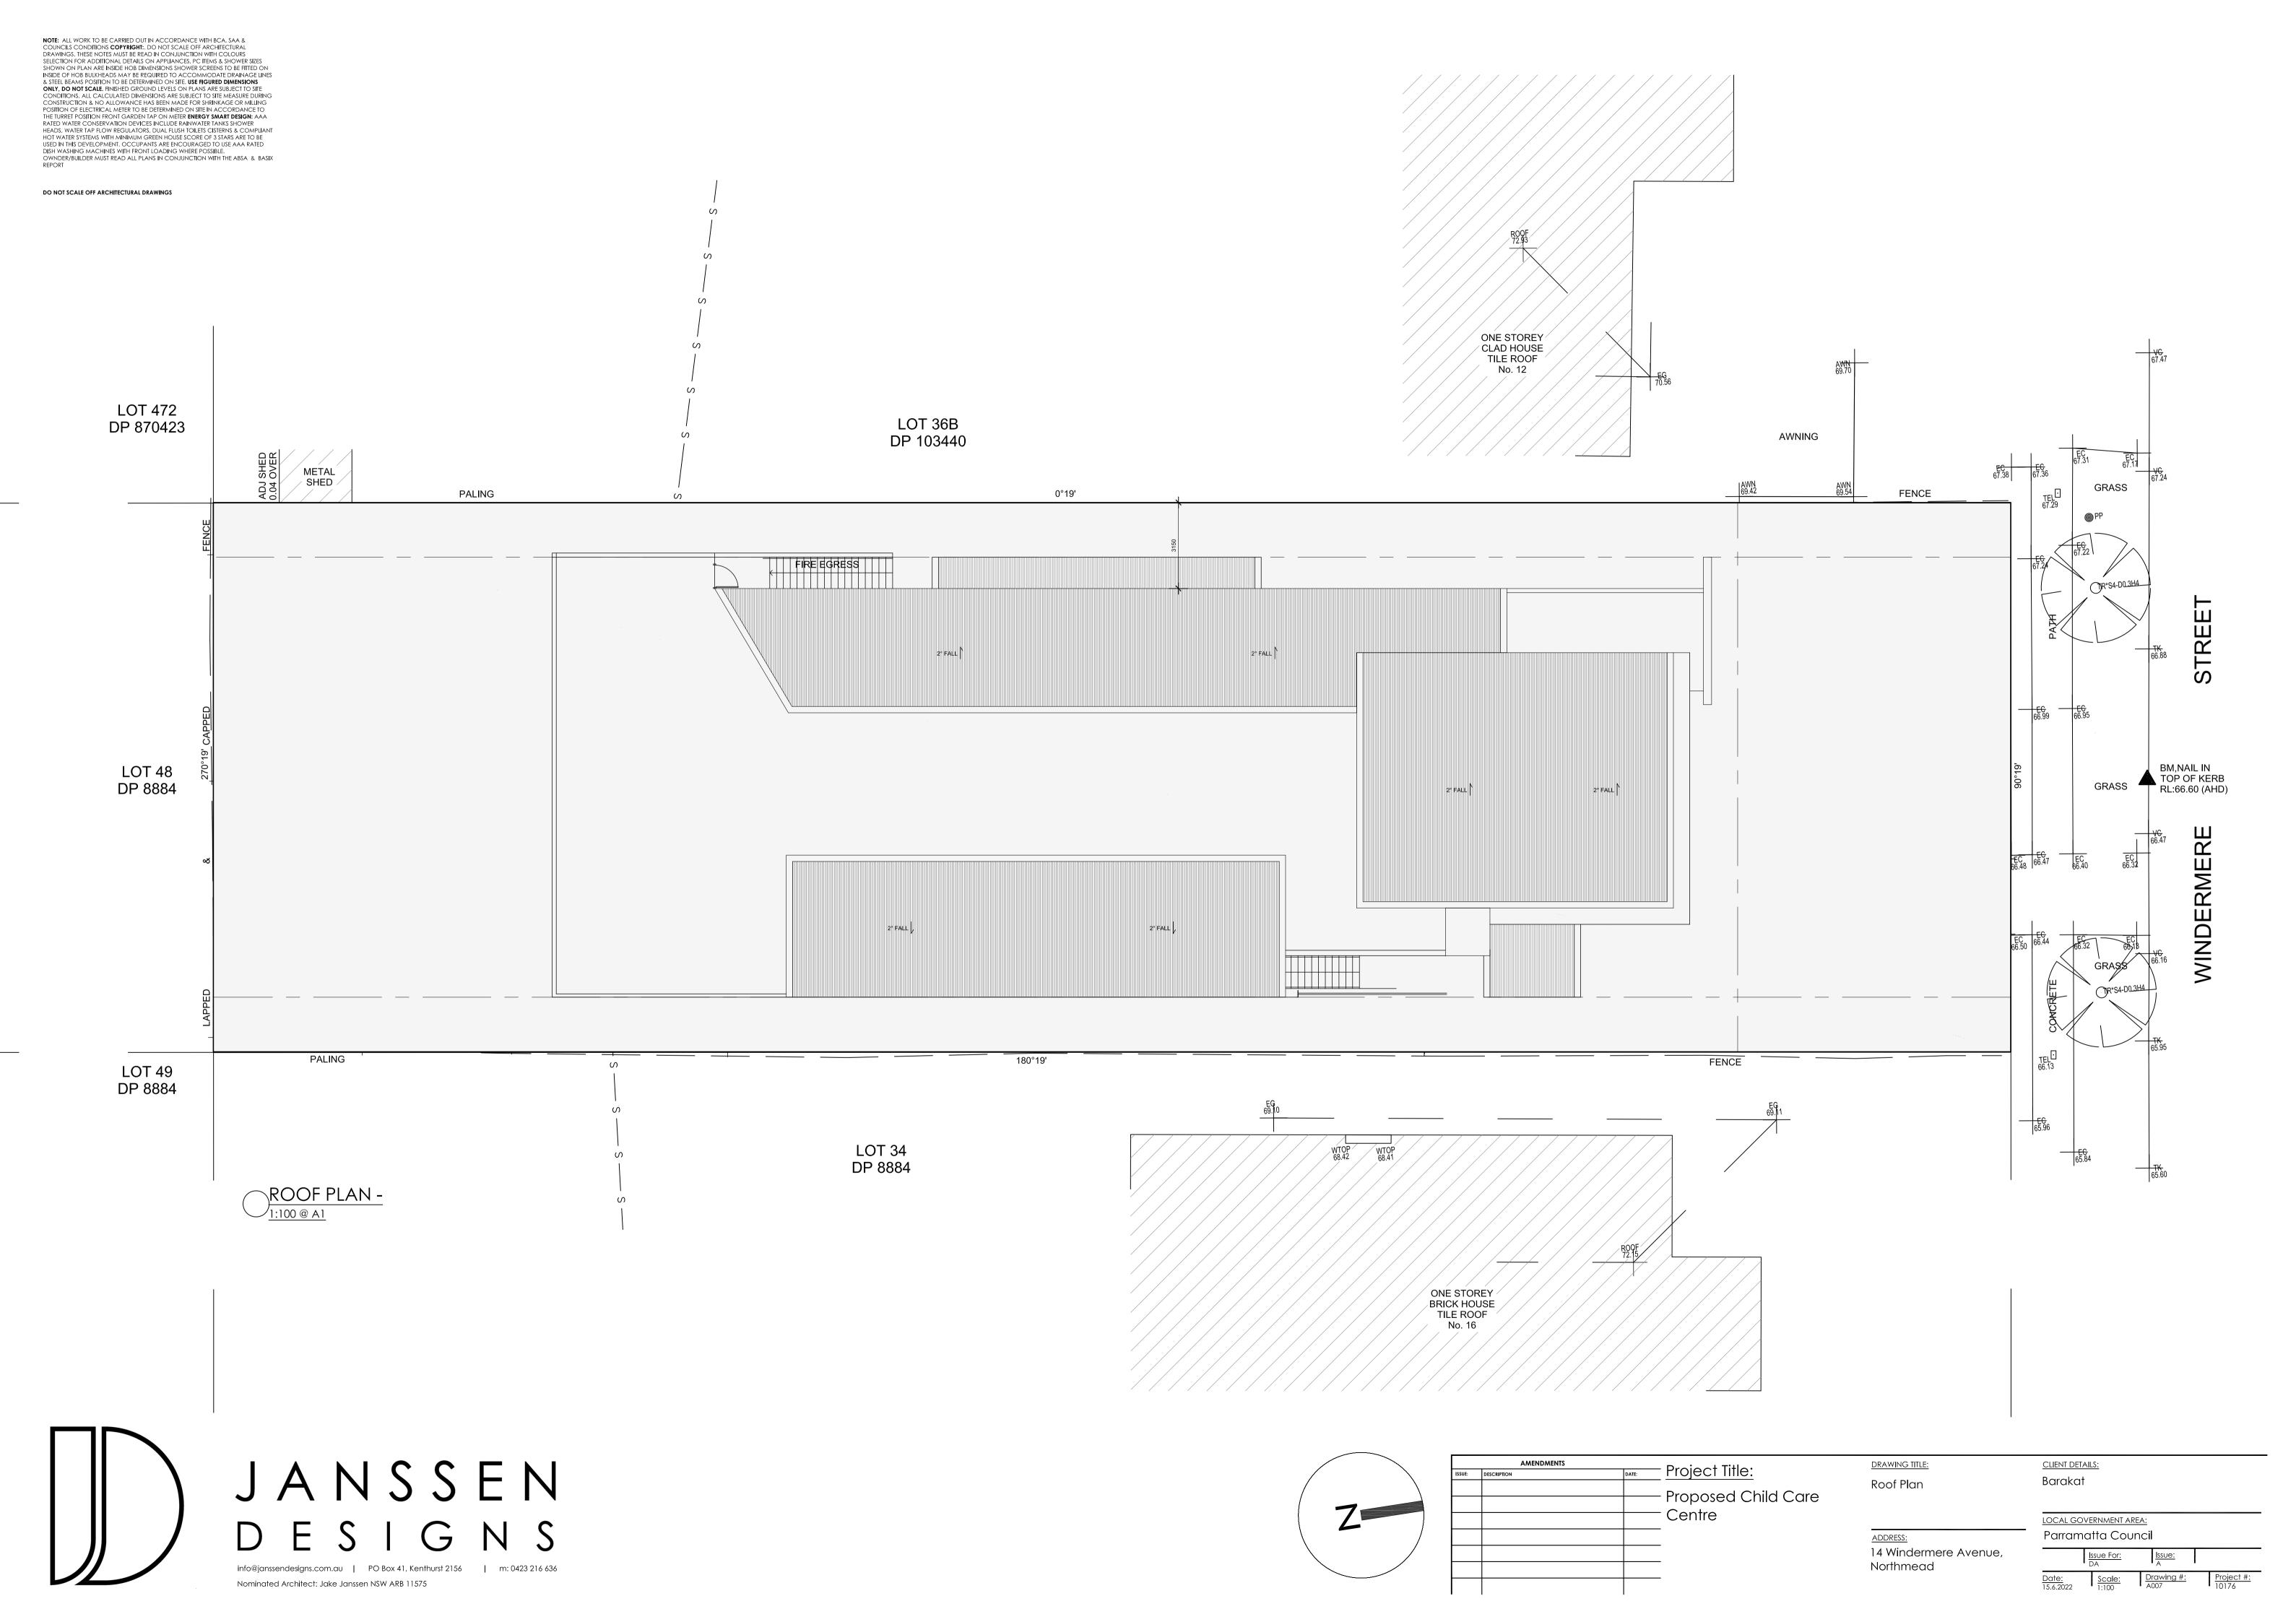


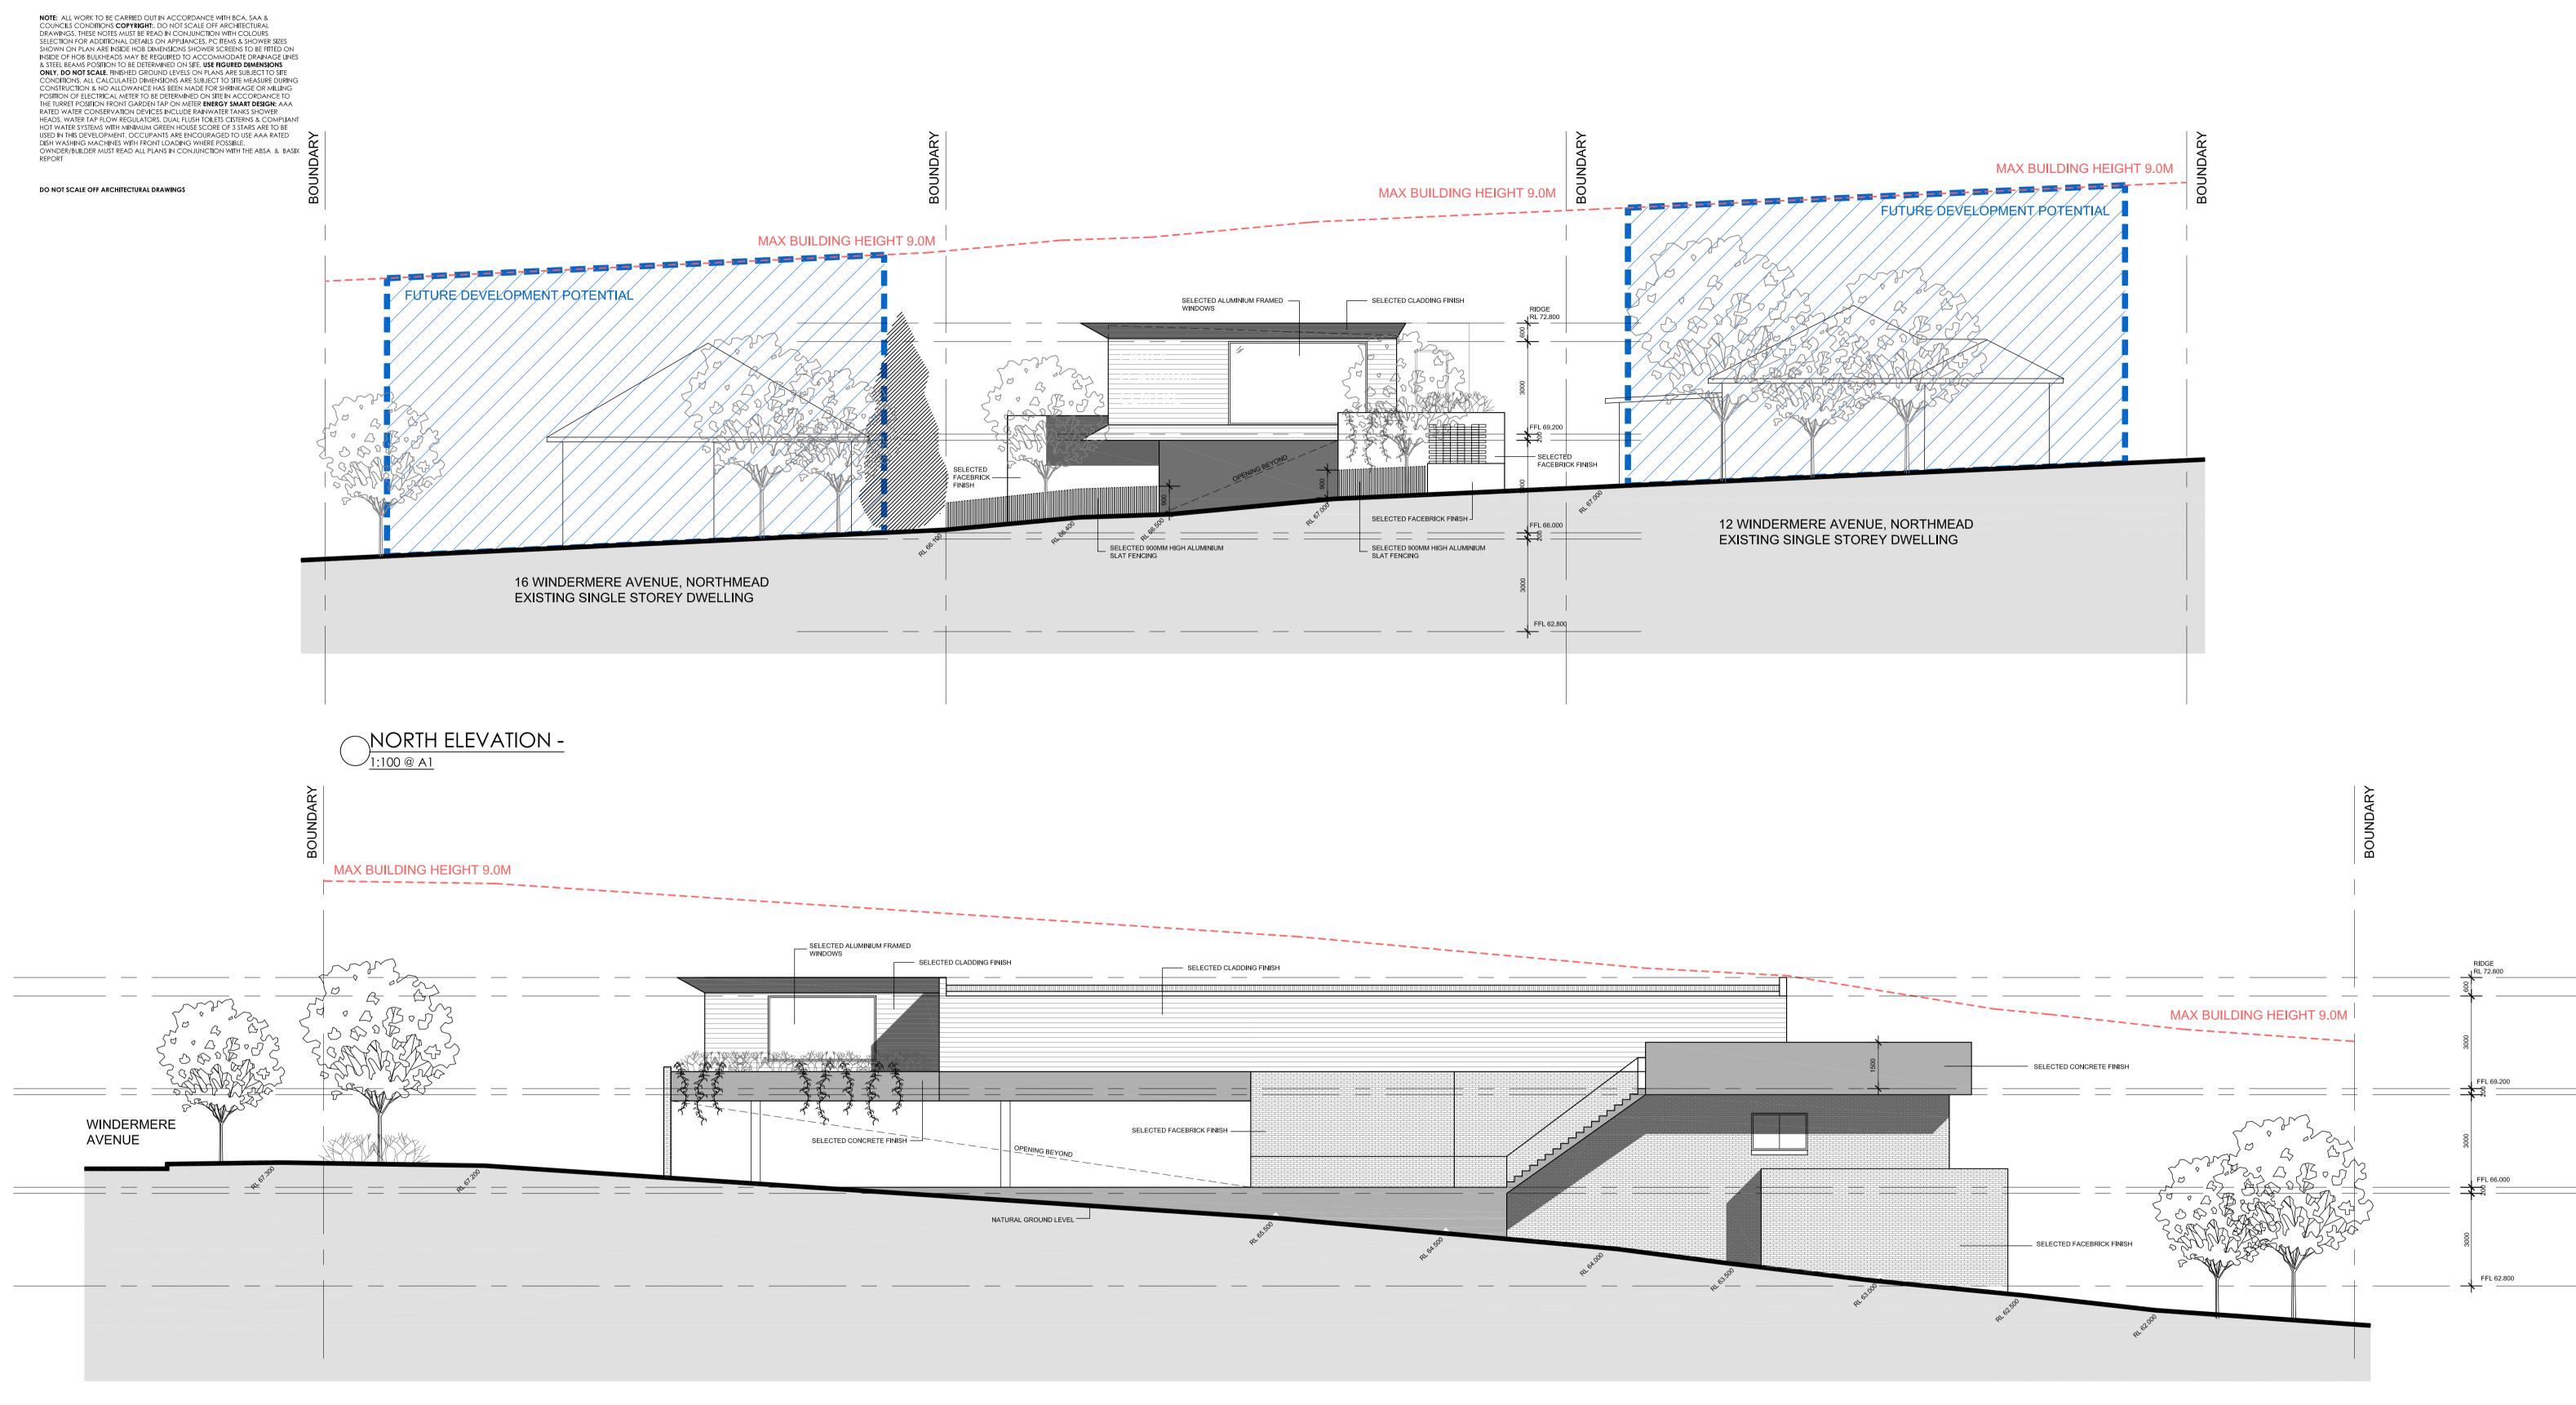

EAST ELEVATION -



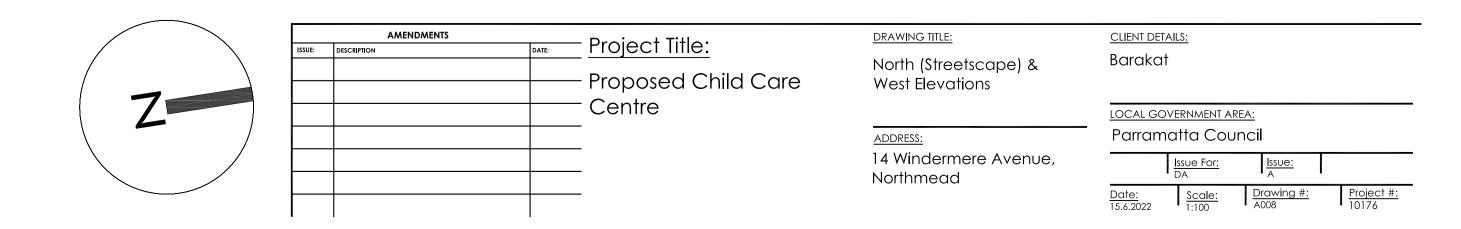


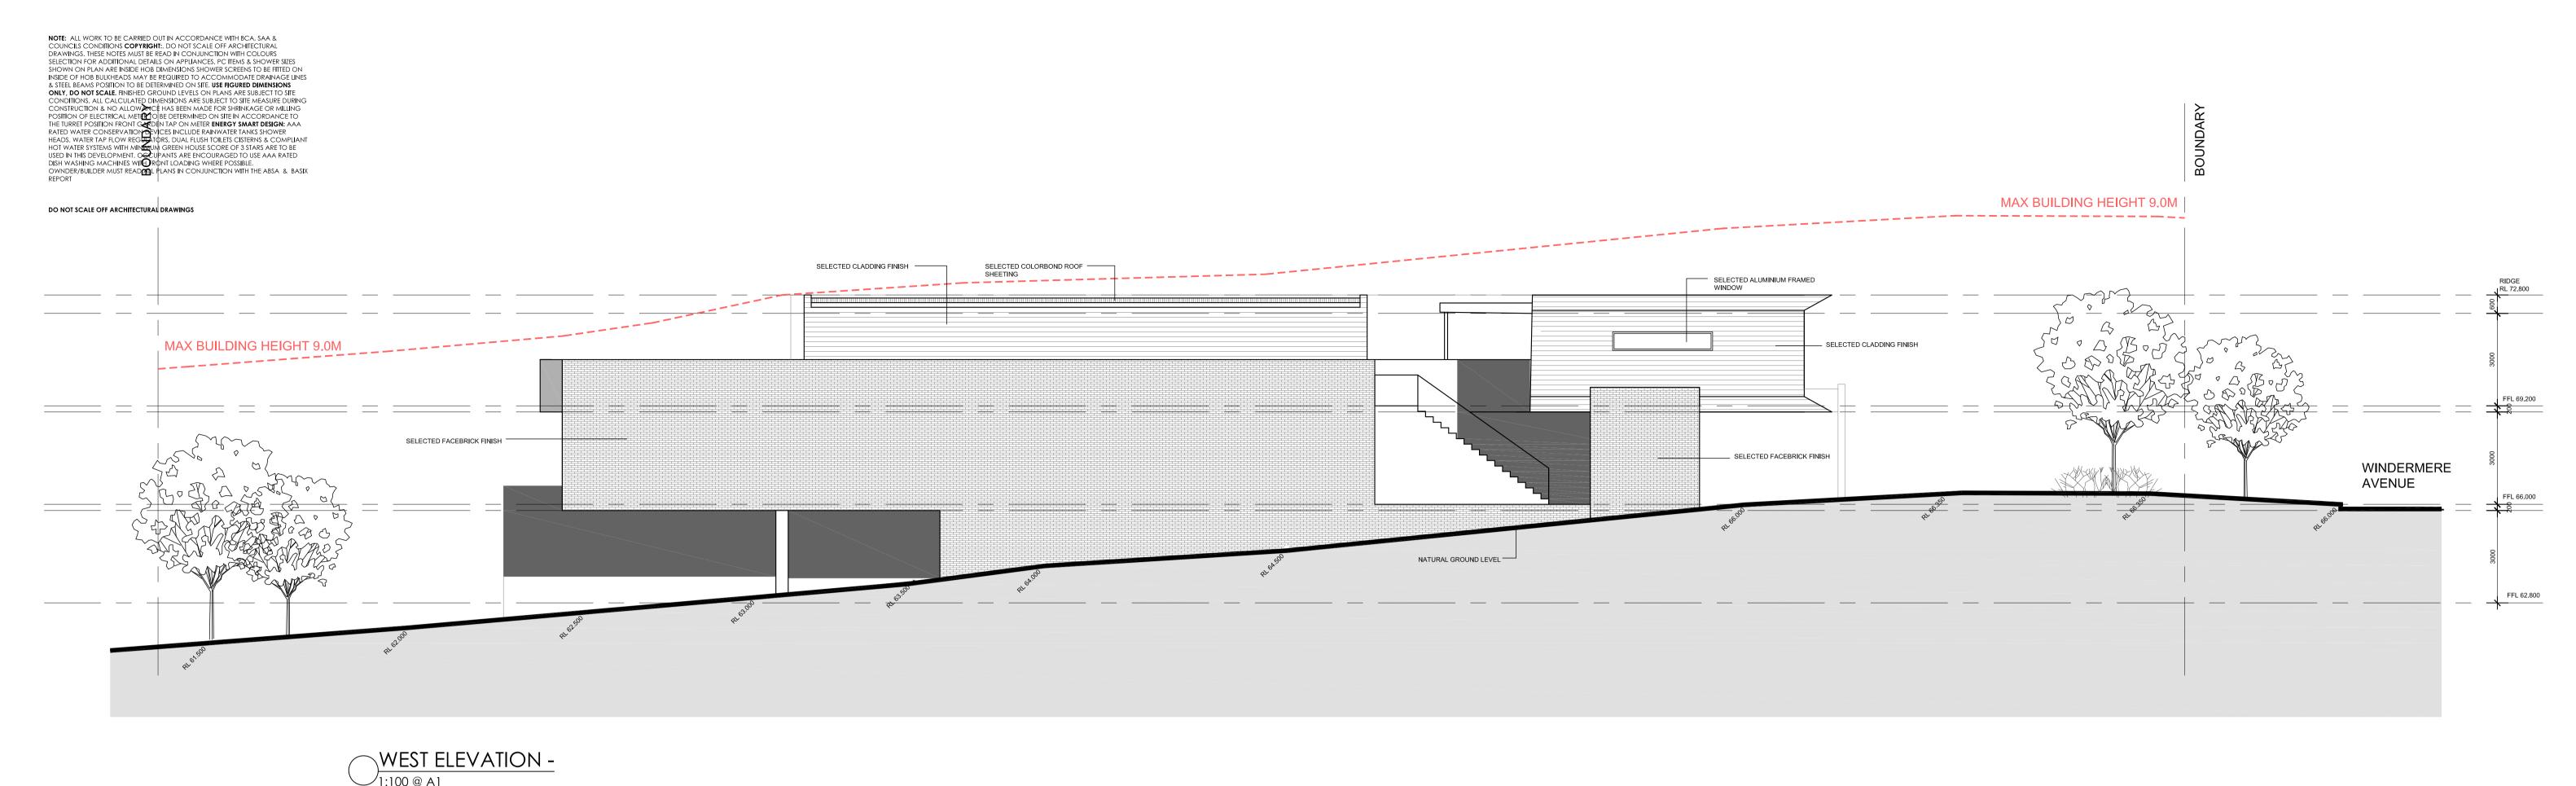



SOUTH ELEVATION -1:100 @ A1




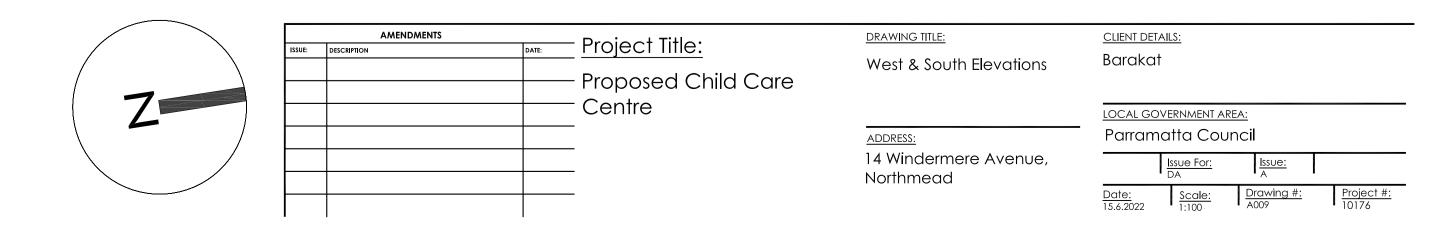


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OWNDER/BUILDER MUST READ ALL PLANS IN CONJUNCTION WITH THE ABSA & BASIX REPORT

DO NOT SCALE OFF ARCHITECTURAL DRAWINGS



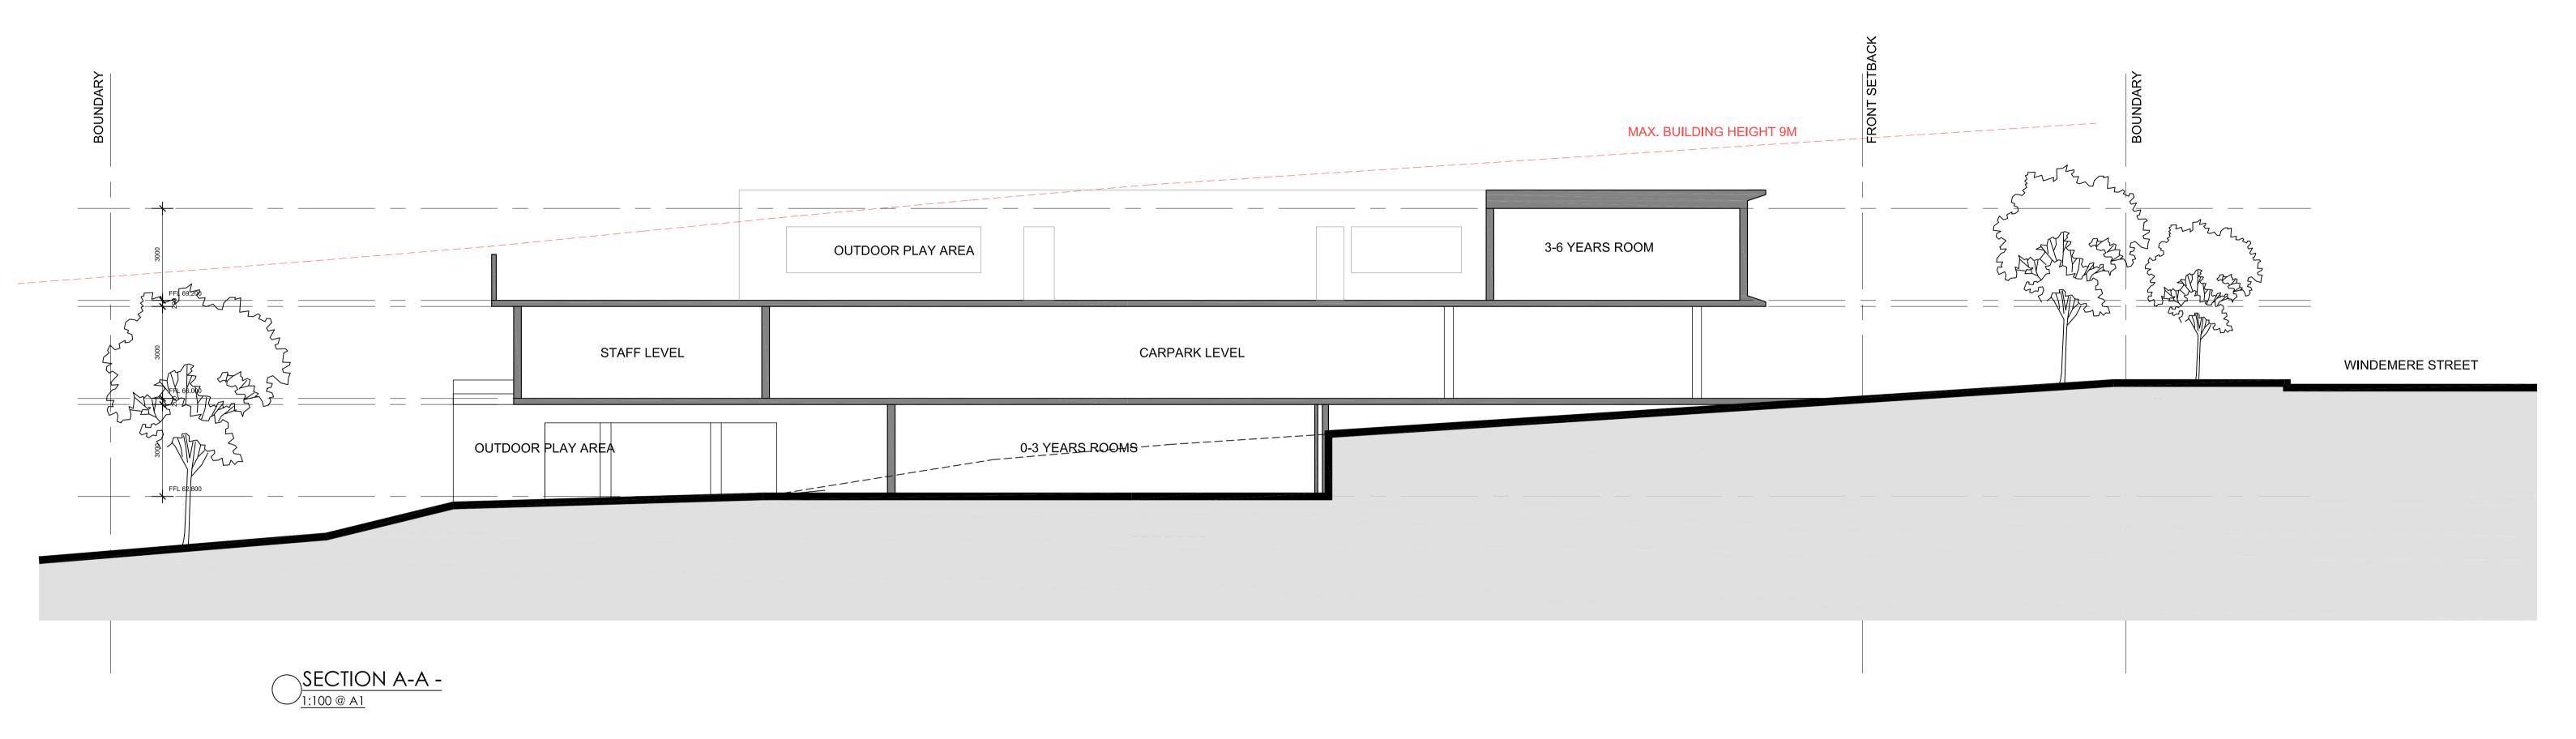

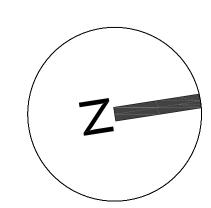

	AMENDMENTS		D T.H		
ISSUE:	DESCRIPTION	DATE:	<u> Project Title:</u>		
			– Proposed Child Care		
			[–] Centre		
			_		
			_		
			<u> </u>		
			_		

DRAWING TITLE:

Section

CLIENT DETAILS:

Barakat

LOCAL GOVERNMENT AREA:

ADDRESS:
Parramo
Northmead





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OWNDER/BUILDER MUST READ ALL PLANS IN CONJUNCTION WITH THE ABSA & BASIX REPORT

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Learning

	AMENDMENTS	- Drain at Title.		
ISSUE:	DESCRIPTION	DATE:	<u>Project Title:</u>	
			Proposed Child Care	
			•	
			Centre	

DRAWING TITLE:
Perspectives

<u>CLIENT DETAILS:</u> Barakat

ADDRESS:
Part 14 Windermere Avenue,
Northmead

LOCAL GOVERNMENT AREA:

Parramatta Council


| Issue For: | Issue: A


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OWNDER/BUILDER MUST READ ALL PLANS IN CONJUNCTION WITH THE ABSA & BASIX REPORT DO NOT SCALE OFF ARCHITECTURAL DRAWINGS ONE STOREY / CLAD HOUSE TILE ROOF No. 12 LOT 472 DP 870423 LOT 36B AWNING DP 103440 ADJ SHED 0.04 OVER METAL SHED **GRASS** 0°19' **FENCE** PALING TR*S0.2H5 65.835 GRASS NS 64.19 NS 64.32 DR 8884 1322.0m² (STATED\BY DP 8884) 1324.4m² (BY CALQULATION) LOT 48 DP 8884 BM,NAIL IN TOP OF KERB GRASS RL:66.60 (AHD) 66.49 66.38 66.53 NS 62.34 65.835 **PALING** LOT 49 DP 8884 WTOP WTOP 68.42 68.41 LOT 34 DP 8884 ONE STOREY BRICK HOUSE TILE ROOF No. 16 LEGEND: JANSSEN DRAWING TITLE: CLIENT DETAILS: Project Title: Cut and Fill Plan Barakat Proposed Child Care PROPOSED CUT - Centre LOCAL GOVERNMENT AREA: Parramatta Council ADDRESS: 14 Windermere Avenue, Northmead Nominated Architect: Jake Janssen NSW ARB 11575





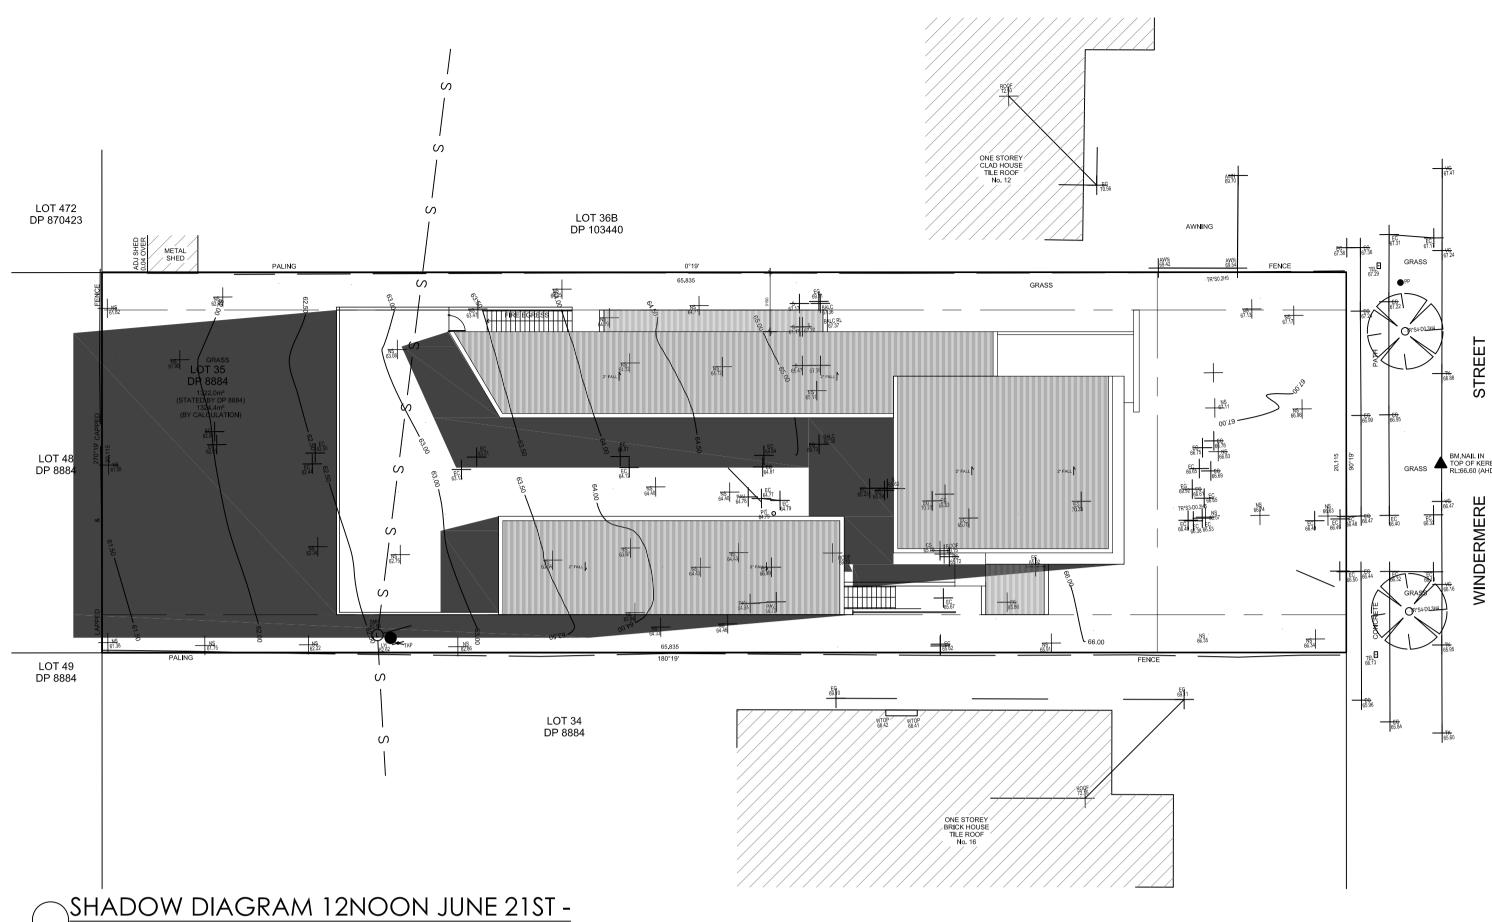

Project Title:

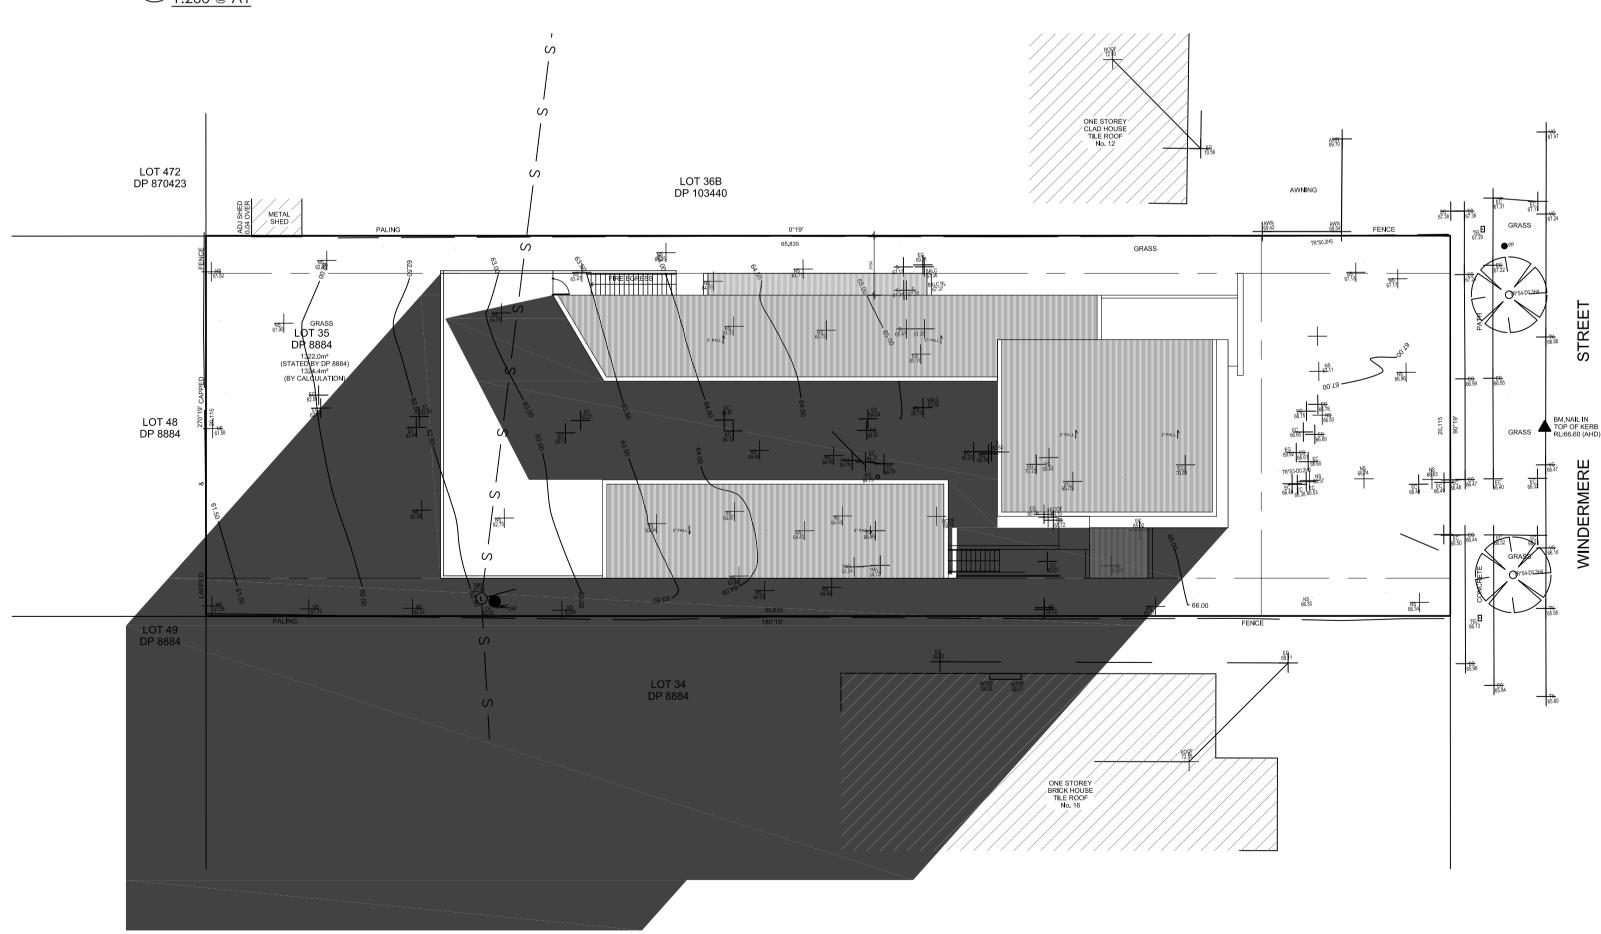Centre

Proposed Child Care

DRAWING TITLE:

ADDRESS:

Northmead

Shadow Diagrams

14 Windermere Avenue,

CLIENT DETAILS:

LOCAL GOVERNMENT AREA:
Parramatta Council

Barakat

AMENDMENTS

SHADOW DIAGRAM 3PM JUNE 21ST -



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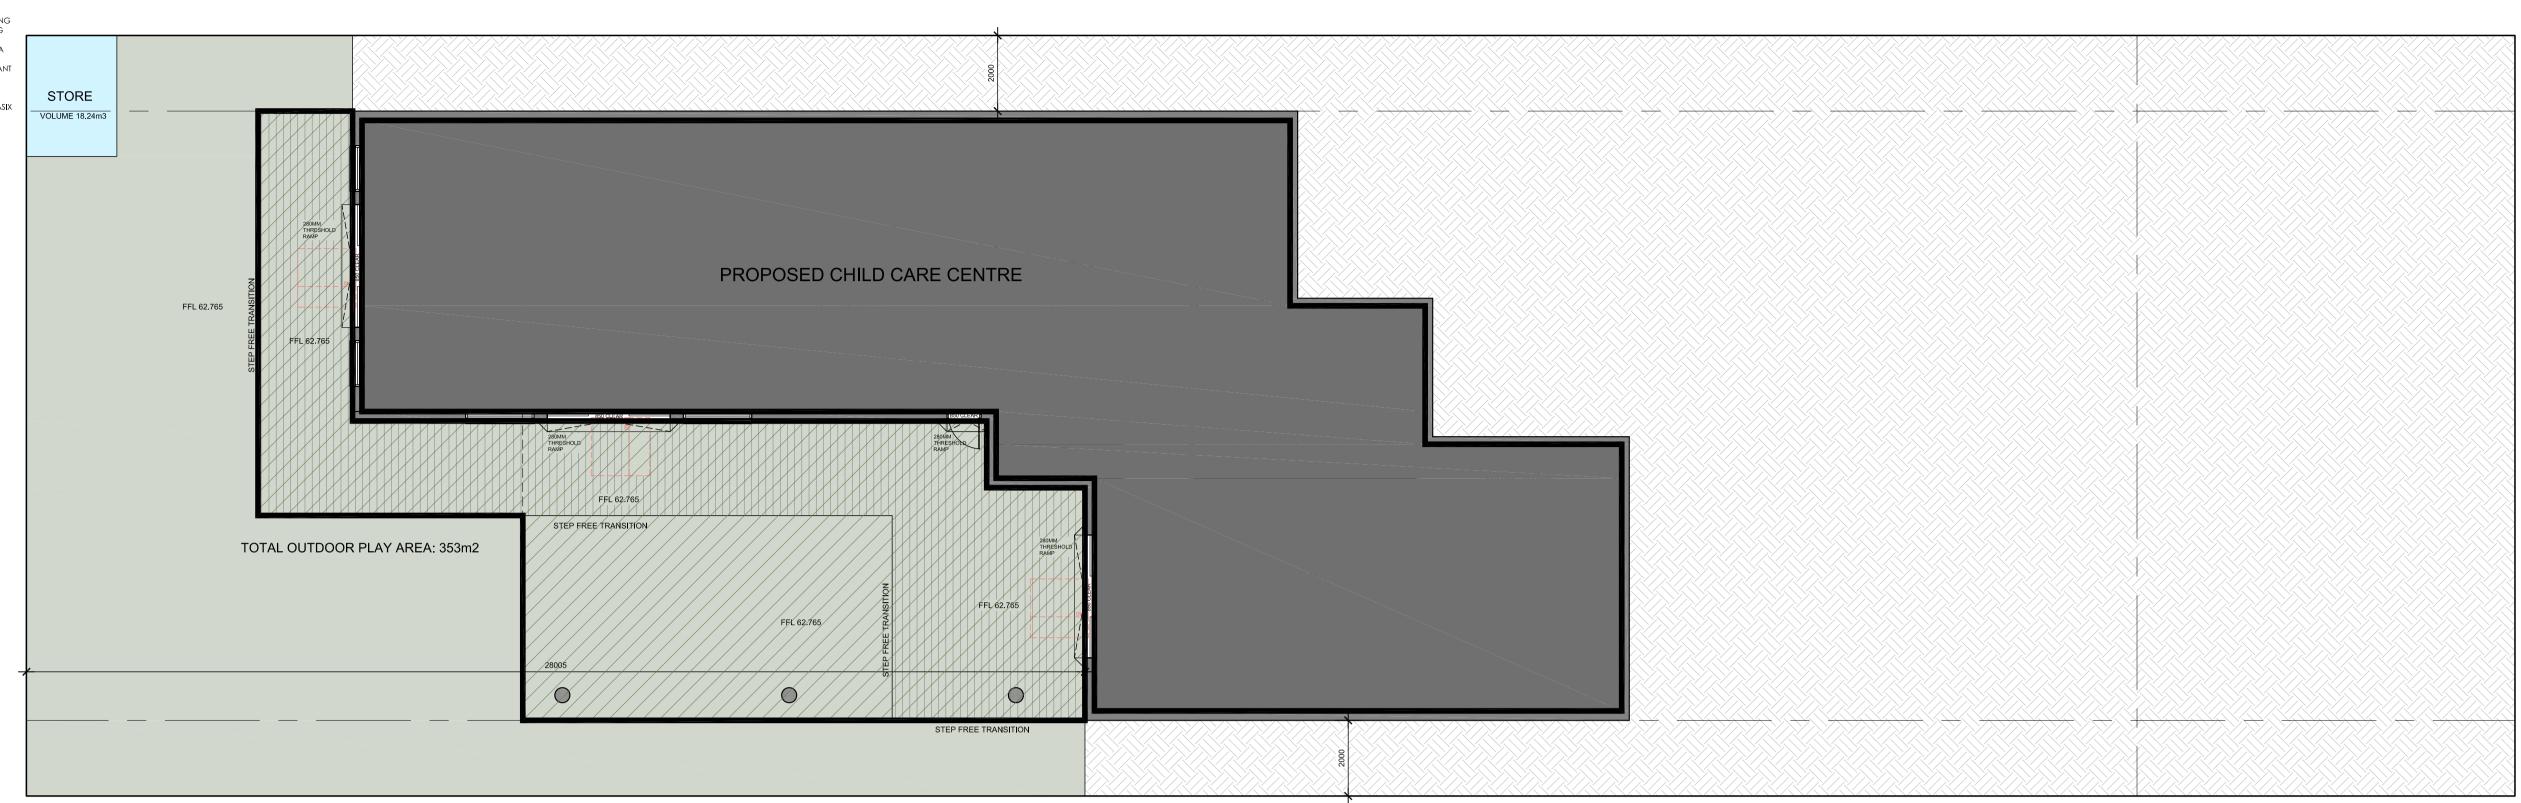
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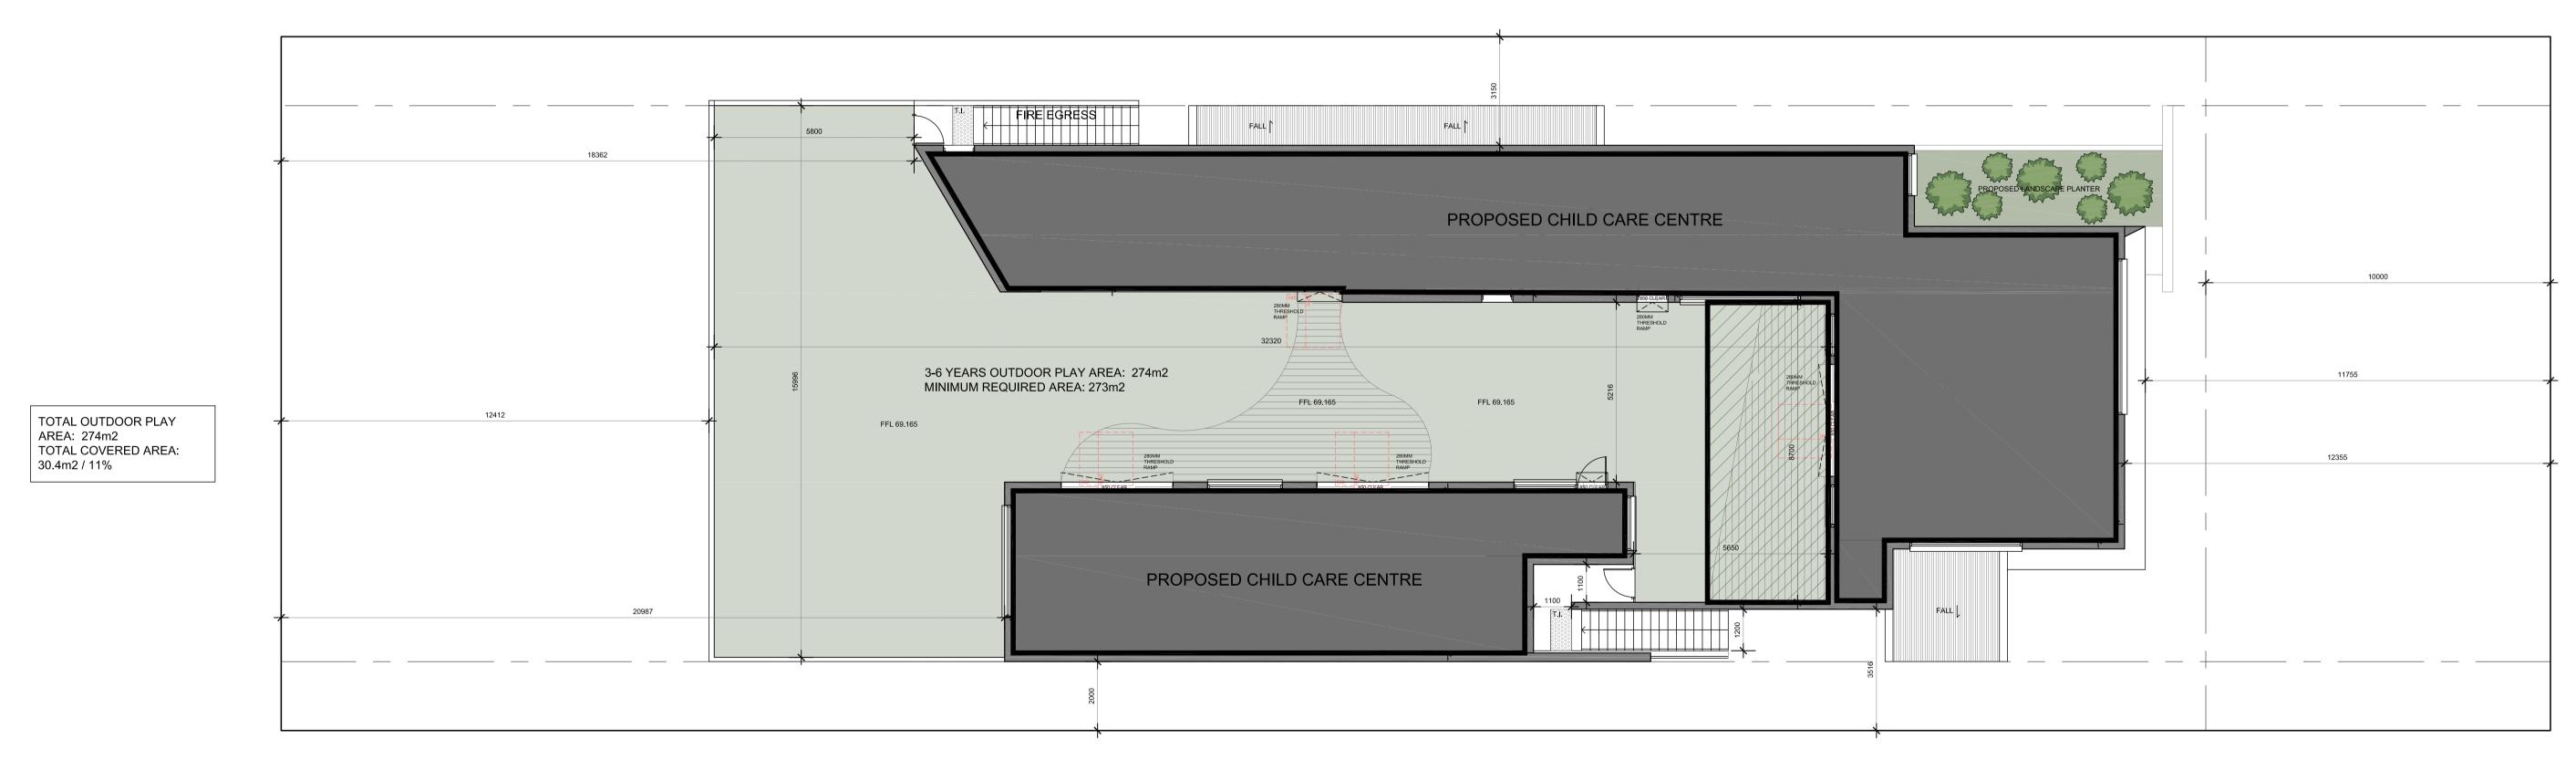
OWNDER/BUILDER MUST READ ALL PLANS IN CONJUNCTION WITH THE ABSA & BASIX REPORT

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TOTAL OUTDOOR PLAY AREA: 353m2 TOTAL COVERED AREA: 151m2 / 42.7%



COVERED OUTDOOR AREA DIAGRAM - LOWER GROUND FLOOR



COVERED OUTDOOR AREA DIAGRAM - UPPER GROUND FLOOR




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HATCHED AREA IDENTIFIES



	AMENDMENTS		- Project Title:		
ISSUE:	DESCRIPTION	DATE:	<u>Project Title:</u>		
			- Proposed Child Care - Centre -		
			_		
			_		
			-		

DRAWING TITLE:

Covered Outdoor Area

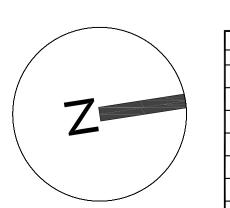Diagrams

ADDRESS:


14 Windermere Avenue,
Northmead


CLIENT DETAILS:

Barakat


LOCAL GOVERNMENT AREA:
Parramatta Council

| Issue For: | Issue: | A

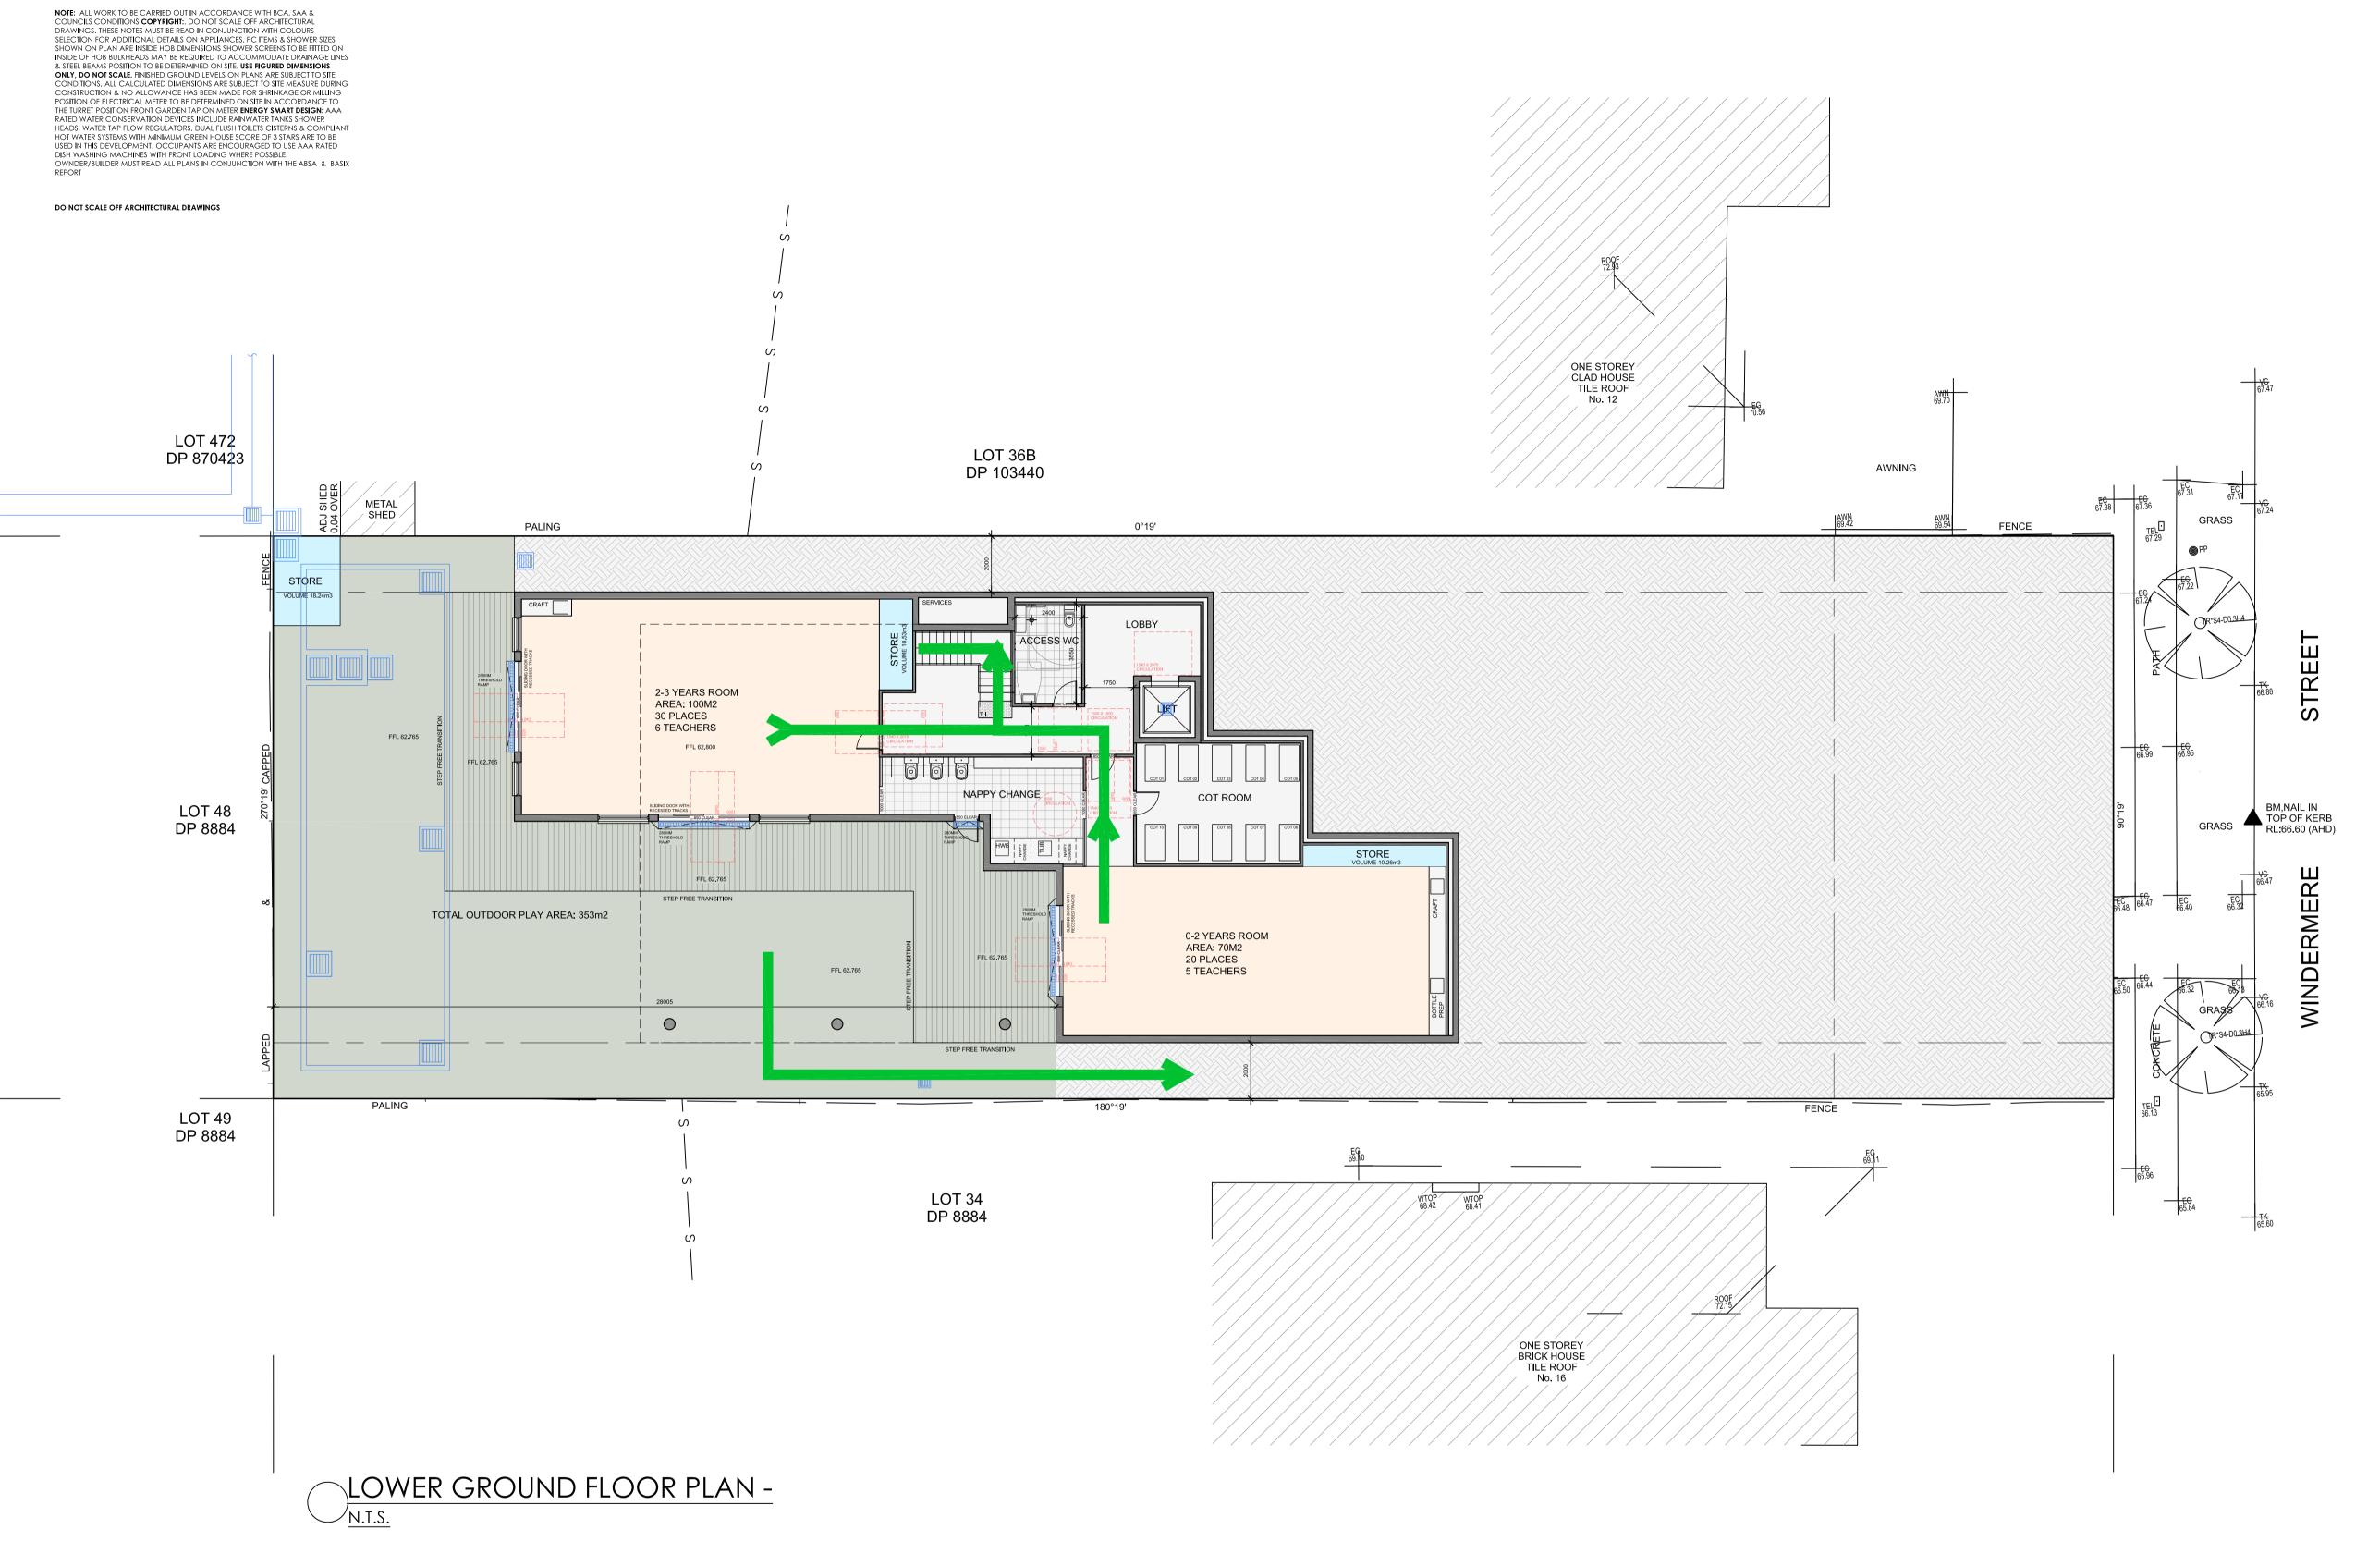

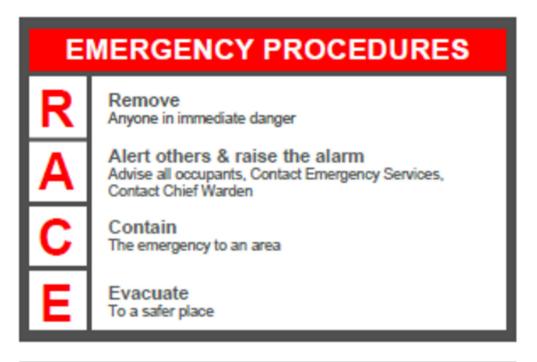




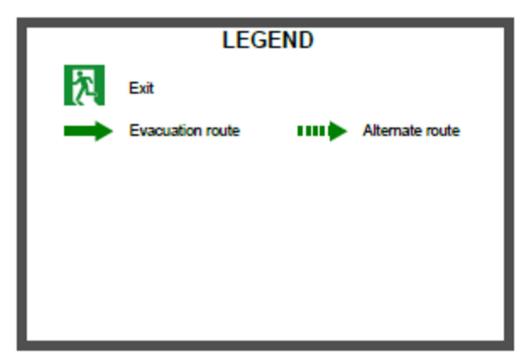

Note: For Development Application Purposes Only



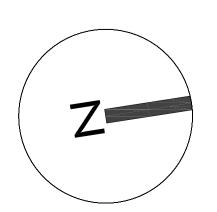

	AMENDMENTS	- Draigat Titla	
ISSUE:	DESCRIPTION	DATE:	<u> Project Title: </u>
			– Proposed Child Care
			[—] Centre
			_
			_
			<u> </u>

DRAWING TITLE:

Emergency Evacuation
Plan - Lower Ground Floor

ADDRESS:
14 Windermere Avenue,
Northmead

CLIENT DETAILS:


Barakat


or

LOCAL GOVERNMENT AREA:


Parramatta Council

Issue For: Issue:

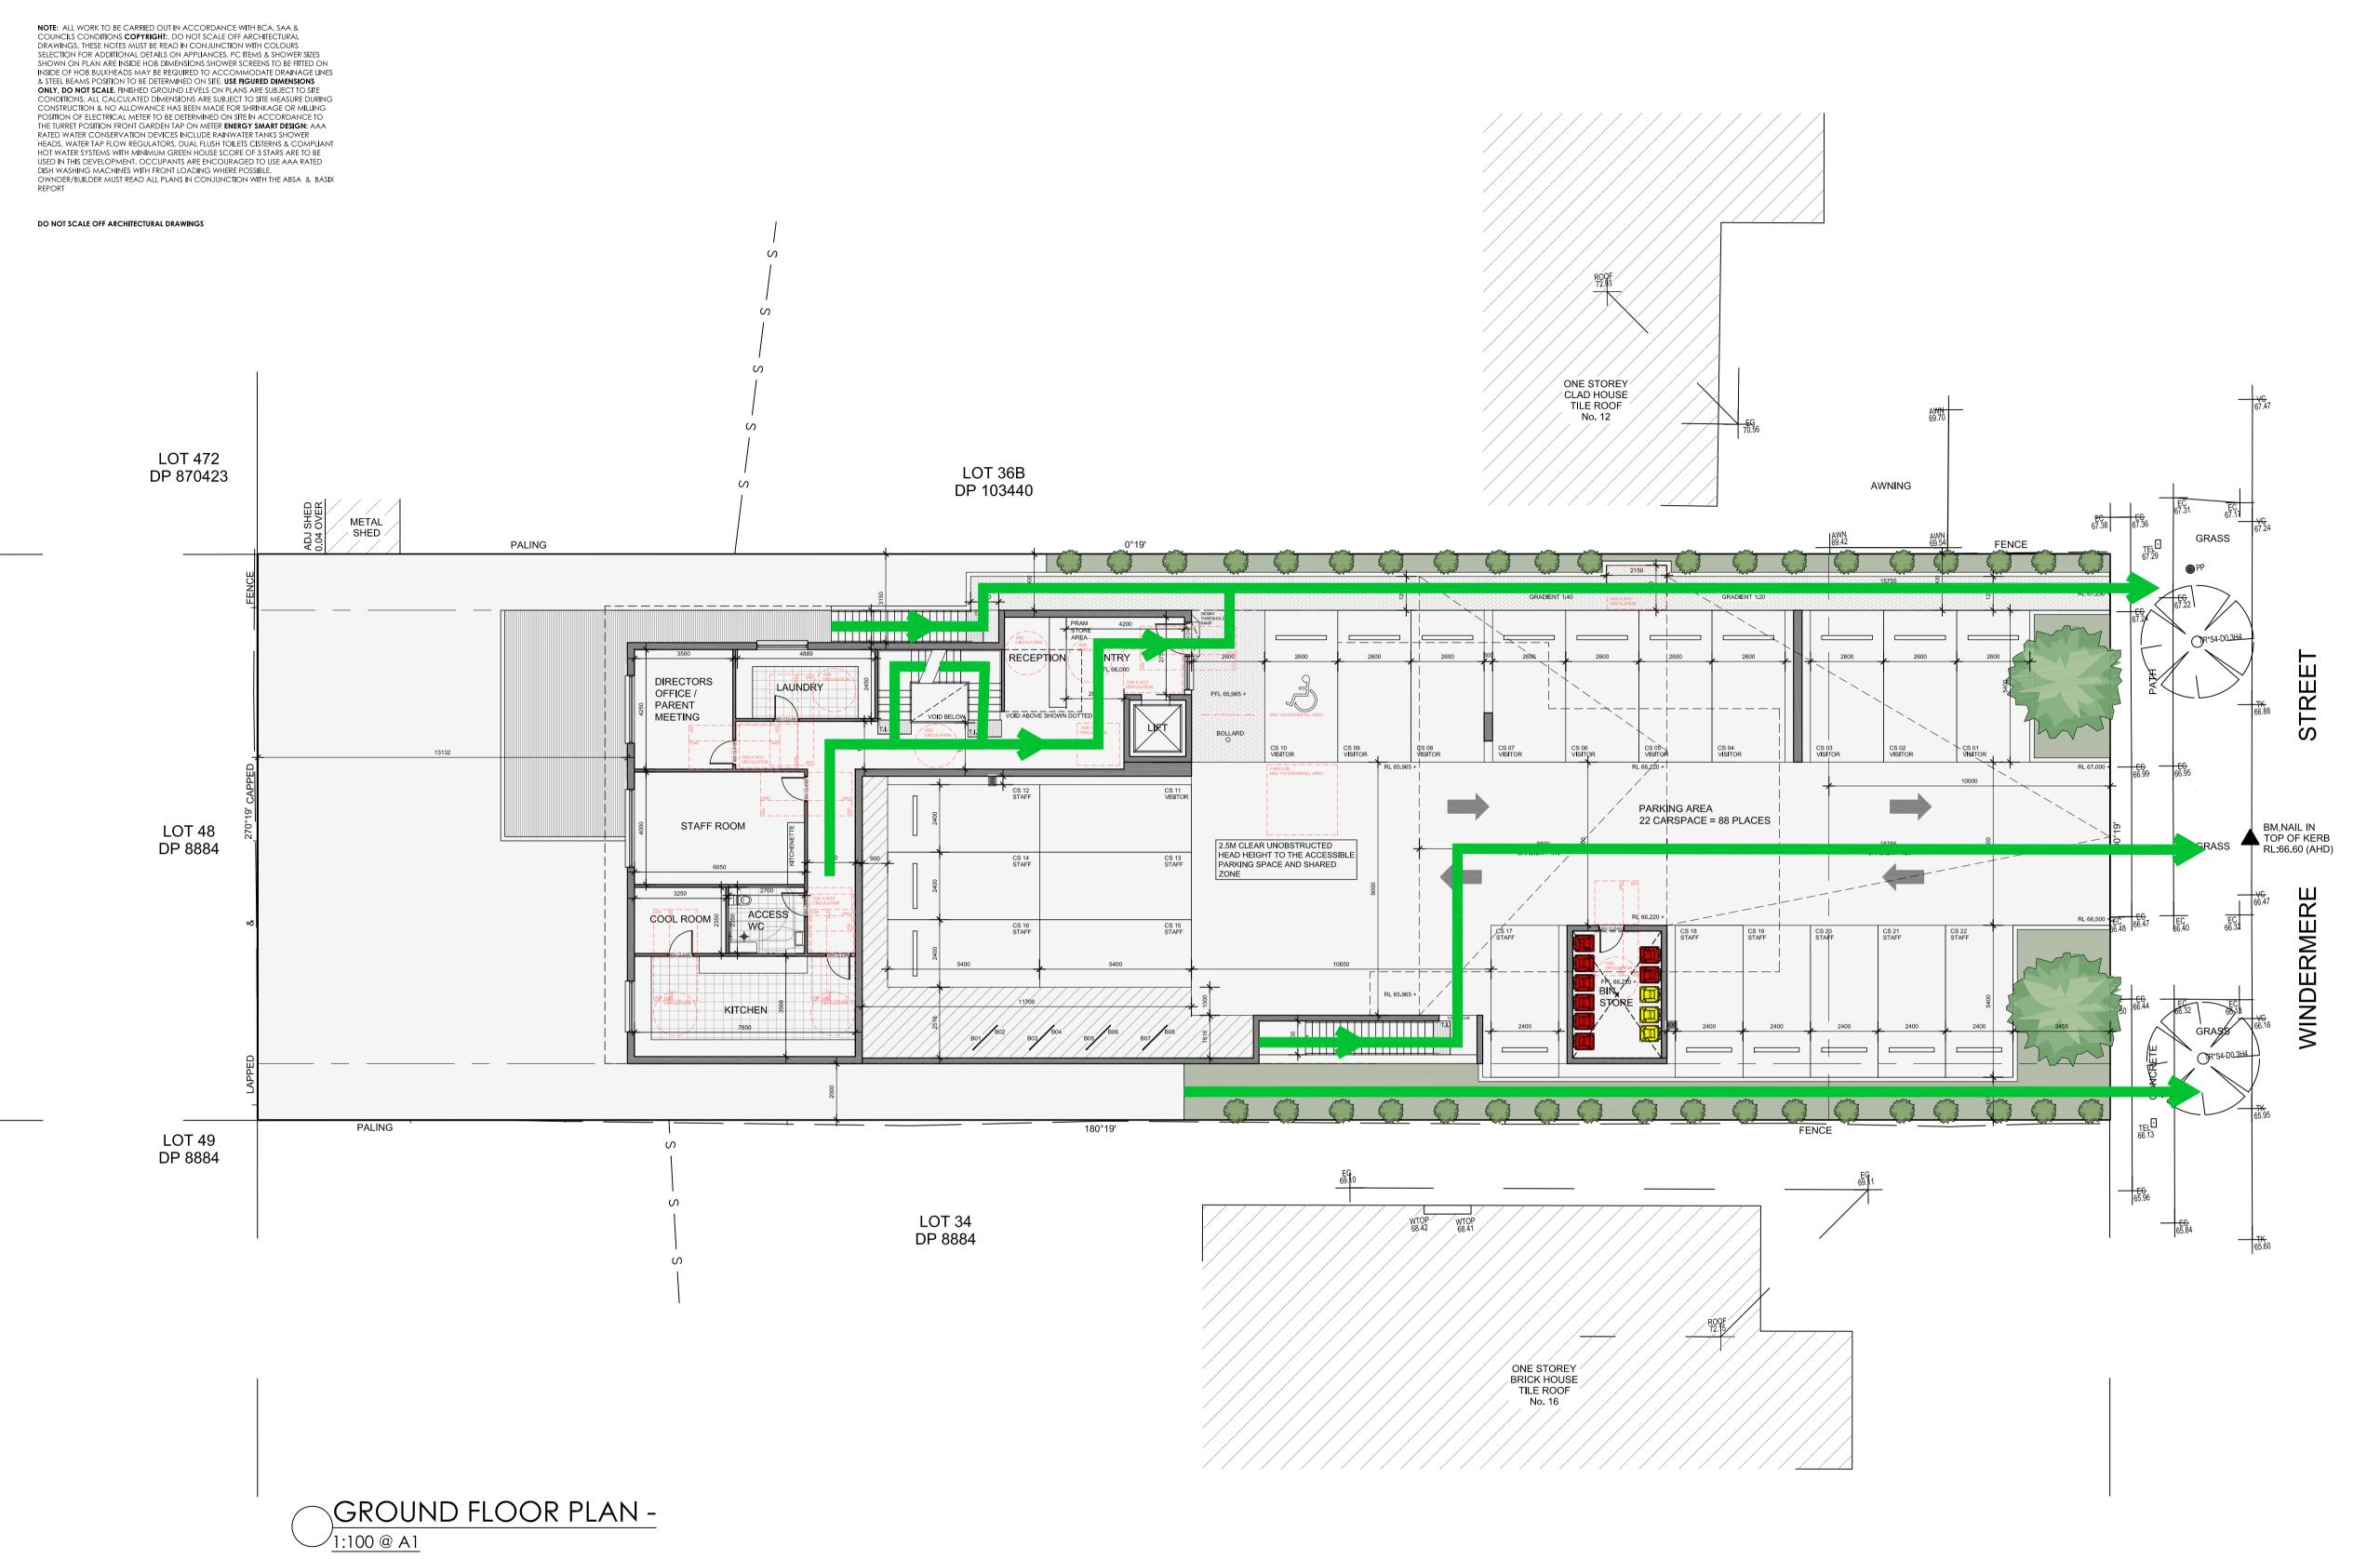

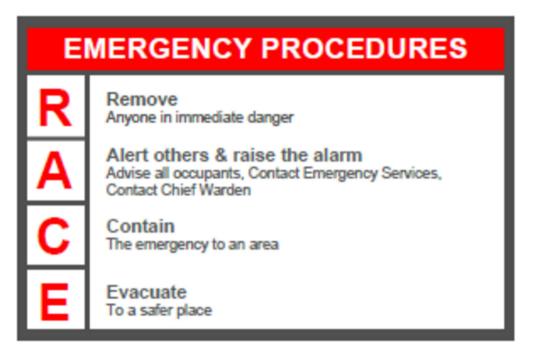




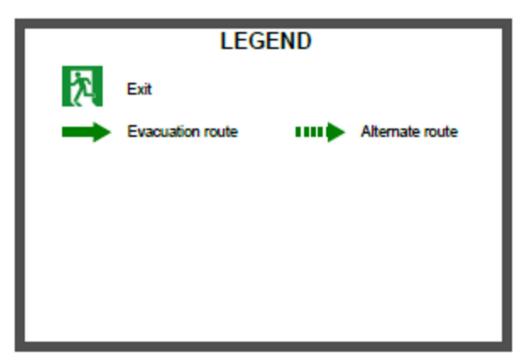

Note: For Development Application Purposes Only



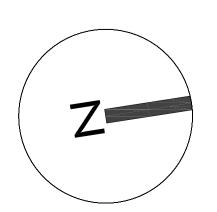

	AMENDMENTS	- Project Title:	
ISSUE:	DESCRIPTION	DATE:	<u> Project Title: </u>
			Proposed Child Care
			– Proposed Child Care
			[—] Centre
	+		_
			_
			_

DRAWING TITLE:
Emergency Evacuation
Plan - Ground Floor

ADDRESS:


14 Windermere Avenue,
Northmead


CLIENT DETAILS:

Barakat


LOCAL GOVERNMENT AREA:
Parramatta Council

e, Issue For:
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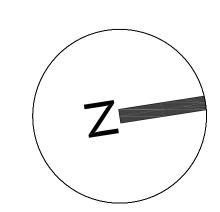


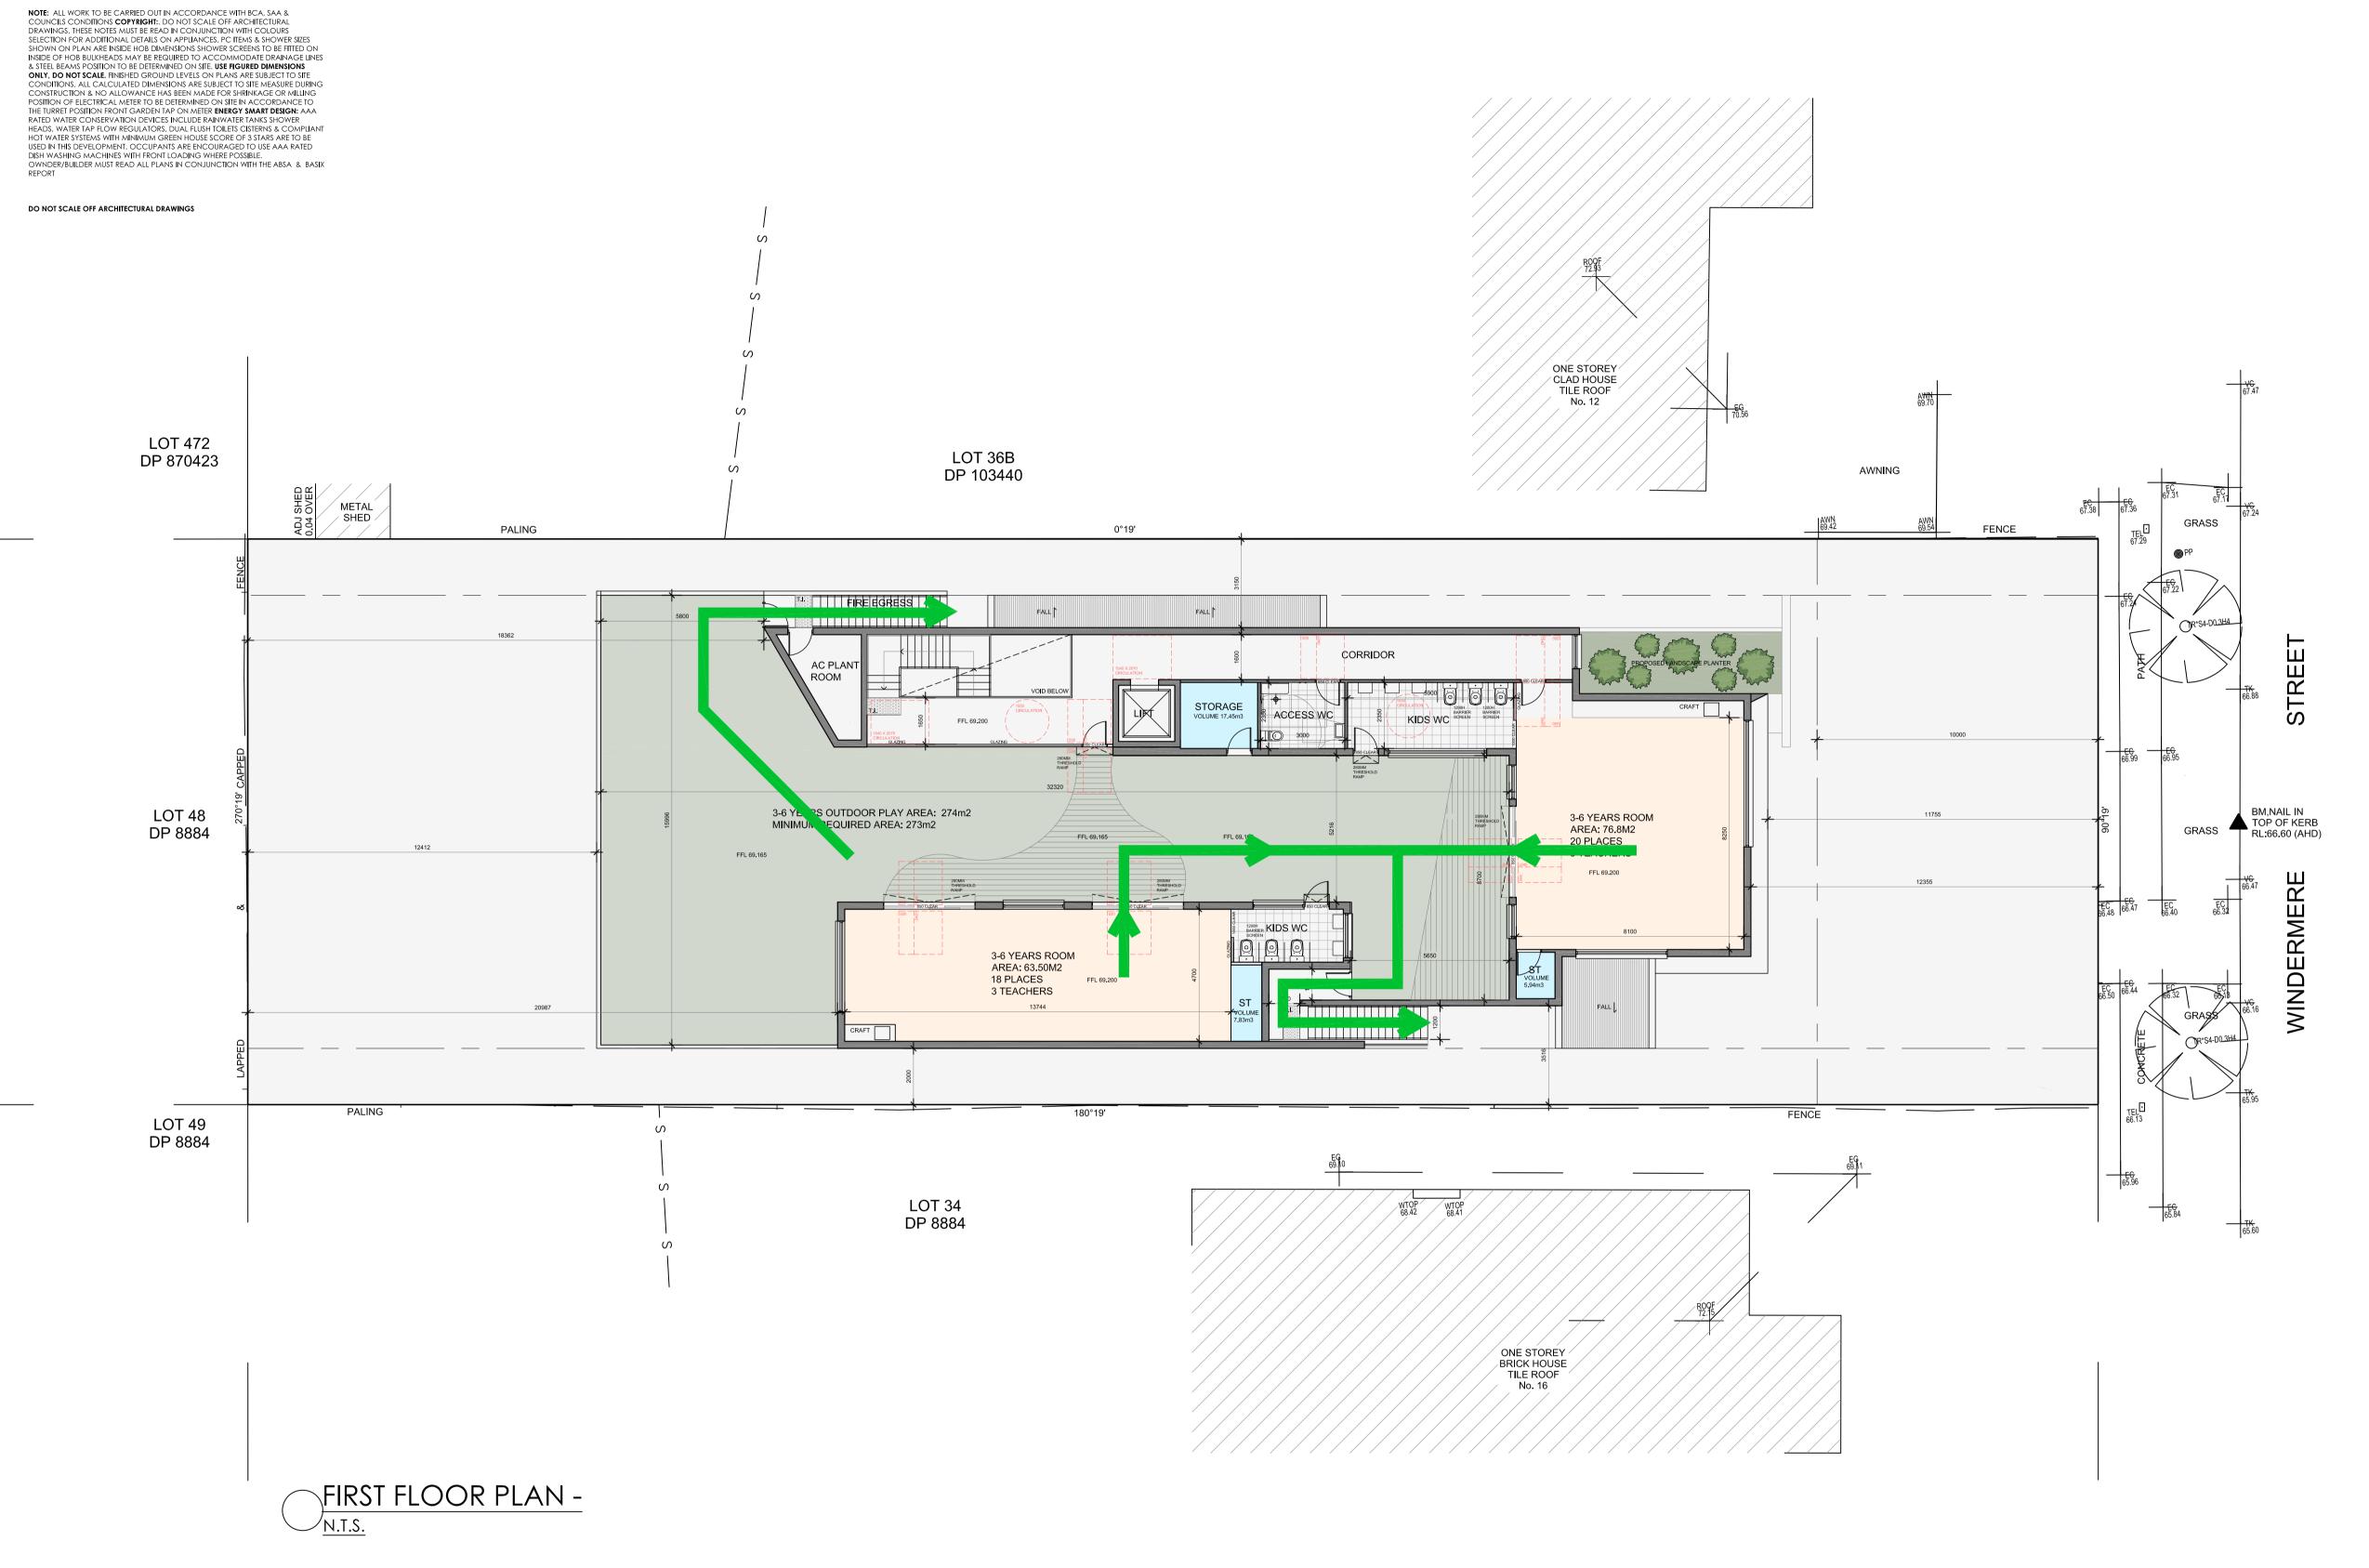

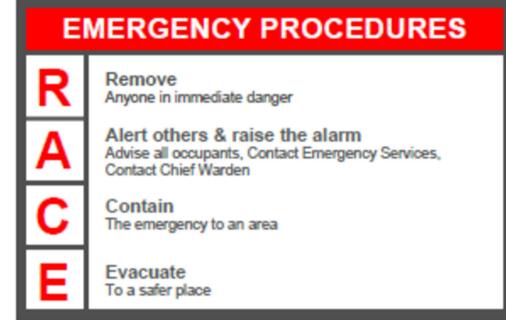

Note: For Development Application Purposes Only

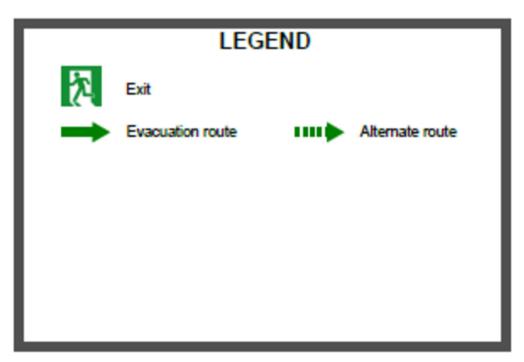



	AMENDMENTS		— D Till
ISSUE:	DESCRIPTION	DATE:	<u> Project Title:</u>
			– Proposed Child Care – Centre –
			_
			_

DRAWING TITLE:


Emergency Evacuation
Plan - First Floor


ADDRESS:


14 Windermere Avenue,
Northmead

CLIENT DETAILS:
Barakat

LOCAL GOVERNMENT AREA:
Parramatta Council

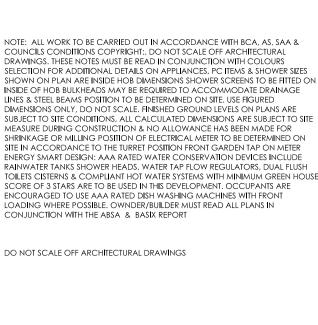

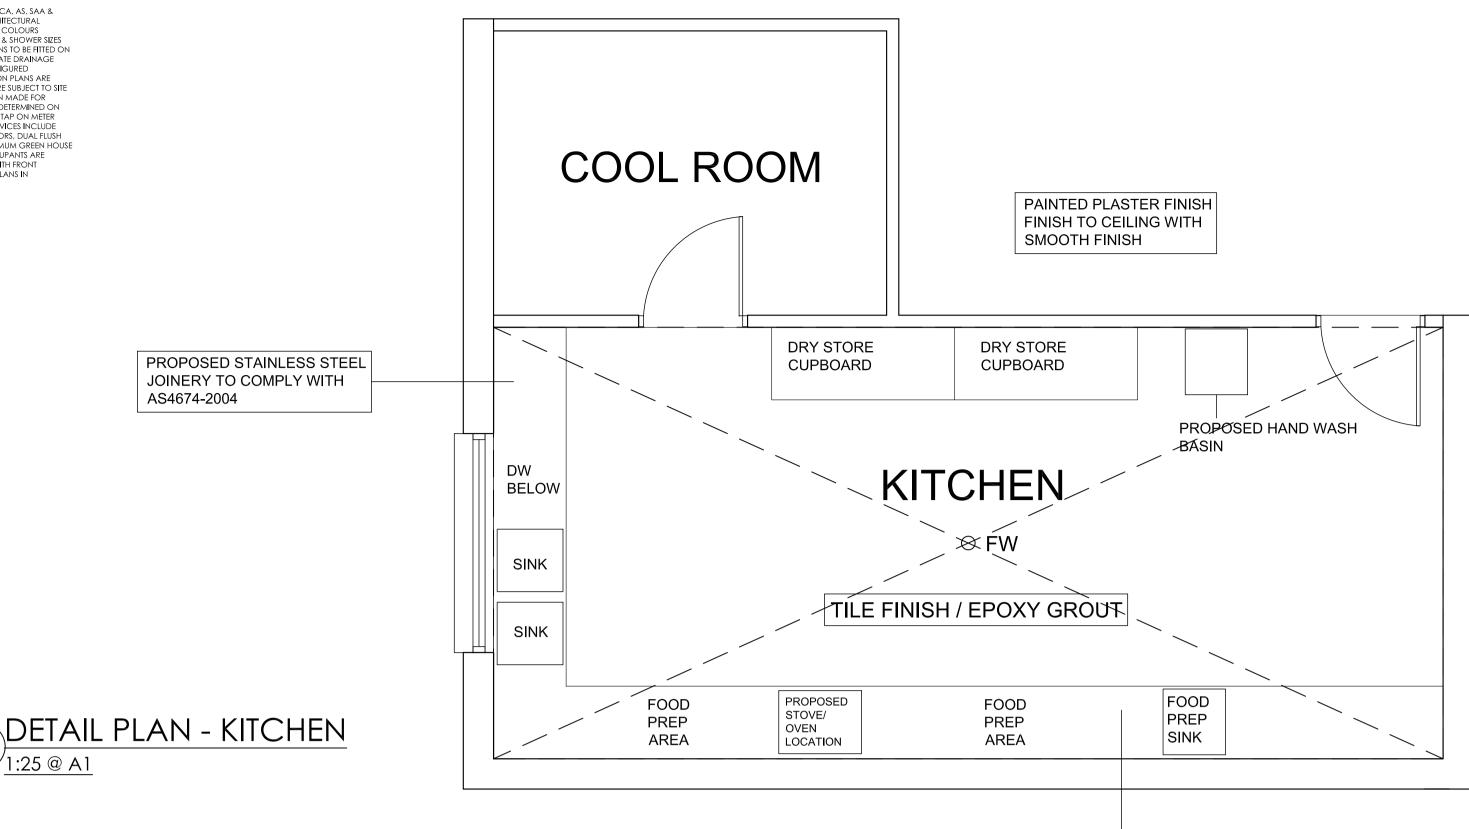

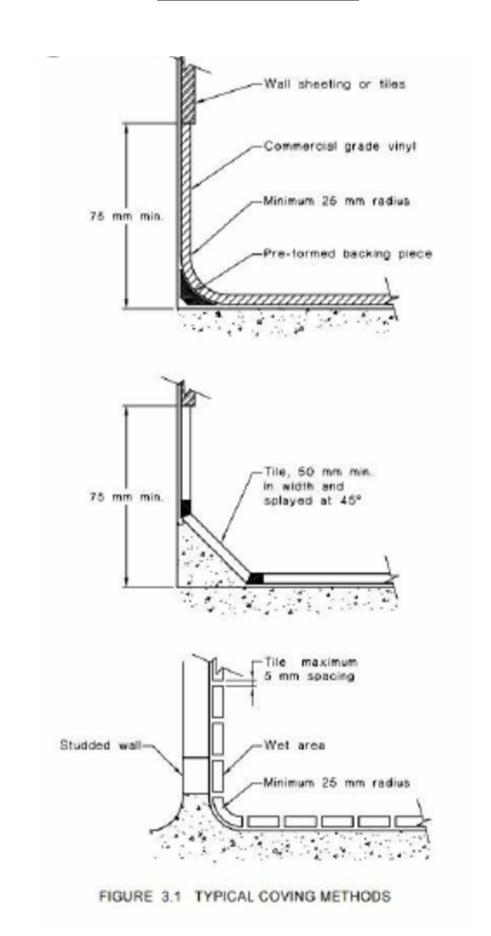

PAINTED PLASTER FINISH

FINISH TO CEILING WITH

SMOOTH FINISH

AS4674-2004 2.6 LIGHTING

2.6.1 GENERAL REQUIREMENTS

ALL FOOD PREMISES SHALL HAVE NATURAL OR ARTIFICICAL LIGHTING IN ACCORDANCE WITH THE REQUIREMENTS OF THE BUILDING CODE OF AUSTRALIA (BCA), WITH THE FOLLOWING EXCEPTIONS:

A. WHERE NATURAL LIGHTING IS PROVIDED THE LIGHTING SHALL ALSO COMPLY BE EQUIVALENT TO THE LEVELS FOR ARTIFICIAL LIGHTING.

PROPOSED STAINLESS STEEL

JOINERY TO COMPLY WITH

AS4674-2004

B. WHERE ARTIFICIAL LIGHTING IS PROVIDED THE LIGHTING SHALL ALSO COMPLY WITH THE REQUIREMENTS OF AS1680.1 AND AS/NZS1680.2.4

SUBDUED LIGHTING MAY BE PROVIDED IN DINING AND DRINKING AREAS, PROVIDED THAT THERE IS LIGHTIN AVAILABLE THAT COMPLIES WITH THE ABOVE REQRUIEMENTS DURING CLEANING AND INSPECTION OPERATIONS.

THE EXPOSED SURFACE OF ALL CONDUITS INSTALLED ON THE SURFACE OF WALLS OR CEILINGS SHALL BE SMOOTH.

2.6.2 LIGHT FITTINGS

IN AREAS WHERE OPEN FOOD IS HANDLED OR STORED, LIGHT FITTINGS SHALL BE -

A. DESIGNED AND CONSTRUCTED TO PREVENT CONTAMINATION OF FOOD SHOULD THE GLOBE OR TUBE SHATTER; AND

B. FREE FROM ANY FEATURES THAT WOULD HARBOUR DIRT, DUST OR INSECTS OR MAKE THE FITTING DIFFICULT TO CLEAN.

LIGHT FITTINGS, WHETHER INTENDED TO PROVIDE LIGHT OR HEAT, THAT ARE PART OF EQUIPMENT USED TO PROCESS OR DISPLAY OPEN FOOD SHALL COMPLY WITH THE REQUIREMENTS FOR LIGHT FITTINGS ABOVE.

2.5 VENTILATION

2.5.1 GENERAL REQUIREMENTS

ALL FOOD PREMISES SHALL HAVE EITHER NATURAL OR MECHANICAL VENTILATION IN ACCORDANCE WITH THE BUILDING CODE OF AUSTRALIA.

EQUIPMENT INSTALLED IN AREAS OF THE PREMISES, AFTER THE MECHANICAL EXHAUST VENTILATION SYSTEM HAS BEEN DESIGNED AND INSTALLED IN THAT AREA, SHALL NOT BE LOCATED SO AS TO IMPAIR THE EFFICIENCY OF THE MECHANICAL EXHAUST VENTILATION OR OF NATURAL VENTILATION.

2.5.2 MECHANICAL VENTILATION AND FILTRATION

IN ADDITION TO THE REQUIREMENTS OF AS/NZS 1668.1 AND AS 1668.2, AN EXTRACTION SYSTEM SHALL BE PROVIDED WHERE THERE IS ANY DISHWASHER AND OTHER WASHING AND SANITIZING EQUIPMENT THAT VENTS STEAM INTO THE AREA TO THE EXTENT THAT THERE IS, OR IS LIKELY TO BE, CONDENSATION ON WALLS AND CEILINGS.

CHILD CARE CENTRE KITCHEN

THE PREMISES ARE TO BE CONSTRUCTED AND FITTED OUT STRICTLY IN ACCORDANCE WITH THE AUSTRALIAN/NEW ZEALAND FOOD SAFETY STANDARDS CODE 3.2.3 'FOOD PREMISES & EQUIPMENT' AND AUSTRALIAN STANDARD 4674.2004 DESIGN, CONSTRUCTION & FIT OUT OF FOOD PREMISES.

FITOUT OF FOOD PREPARATION AREA

A RIGID SMOOTH FACED IMPERVIOUS CEILING SHALL BE PROVIDED OVER THE FOOD PREPARATION, COOKING AND SERVING AREAS. THE SURFACE FINISH SHALL BE FREE OF OPEN JOINTS, CRACKS, CREVICES OR OPENINGS WITH INTERSECTION OF THE WALLS AND CEILING BEING TIGHT JOINTED, SEALED AND DUSTPROOF.

THE CEILING SHALL BE PAINTED WITH A LIGHT COLOURED WASHABLE PAINT.

ALL FLUORESCENT LIGHT FITTINGS SHALL BE FITTED WITH A SMOOTH FACED DIFFUSER. LIGHTING SHALL BE EITHER:

RECESSED SO THAT THE DIFFUSER IS FLUSH WITH THE CEILING OR
 DESIGNED TO ENSURE THAT NO HORIZONTAL SURFACE EXISTS WHICH WOULD ALLOW DUST & GREASE TO ACCUMULATE.

THE FLOOR IS TO BE CONSTRUCTED OF CONCRETE OR OTHER MATERIAL IMPERVIOUS TO MOISTURE, FINISHED TO A SMOOTH TROWELLED FINISH, COVED AT THE INTERSECTIONS WITH THE WALLS AND GRADED AND DRAINED TO APPROVED SEWERAGE CONNECTIONS.

COVING IS TO BE PROVIDED BETWEEN ALL WALLS AND THE FLOOR AND BETWEEN THE FLOOR AND ALL FITTINGS. THIS CAN BE ACHIEVED BY COVING TILES, CEMENT RENDER, OR BY TURNING VINYL FLOORING UP THE WALLS. IN THIS CASE A FILLET OR BACKING PIECE IS REQUIRED TO SUPPORT THE COVE.

FLOOR TO BE CONSTRUCTED OF MATERIAL IMPERVIOUS TO WATER, NON SLIP AND GRADED AND DRAINED TO FLOOR WASTE.

THE WALLS IN THE KITCHEN ARE TO BE TILED WITH CLOSE JOINTED, GLAZED TILES OF A LIGHT COLOUR TO A HEIGHT OF 450MM ABOVE ALL SINKS, TUBS, DRAINING BOARDS, WASH HAND BASINS AND PREPARATION BENCHES.

ALL WALLS WHERE NOT TILED SHALL BE CEMENT RENDERED TO A SMOOTH SURFACE AND PAINTED WITH A LIGHT COLOURED WASHABLE PAINT.

REFRIGERATION, FROZEN FOOD CABINETS, COOKING APPLIANCES, EQUIPMENT, FITTINGS, CUPBOARDS AND CABINETS ARE TO BE SUPPORTED ON ONE OF THE FOLLOWING SYSTEMS:

- * WHEELS OR COASTERS WHICH ALLOW THE FULLY LOADED FITTING TO BE EASILY MOVED.
- * LEGS WHICH PROVIDE A MIN. 150MM CLEARANCE FROM THE FLOOR TO THE UNDERSIDE OF THE FITTING.

ALL SHELVING TO BE INSTALLED ON APPROVED METAL BRACKETS KEPT AT LEAST 25MM CLEAR OF WALL.

FOOD PREPARATION BENCHES SHALL BE CONSTRUCTED OF STAINLESS STEEL.

THE TOP AND EXPOSED EDGES OF ALL BENCHES, COUNTERS AND SHELVING TO FINISHED IN A SMOOTH AND NON-ABSORBENT MATERIAL FREE OF JOINT.

ALL SERVICE PIPES, CONDENSATE PIPES AND ELECTRICAL CONDUITS MUST BE SEALED INTO THE WALLS, FLOORS OR PLINTHS.

A FREESTANDING WASH HAND BASIN IS TO BE PROVIDED IN AN APPROVED POSITION IN THE KITCHEN/FOOD PREPARATION AREA CONNECTED TO BOTH HOT AND COLD WATER AT A MINIMUM TEMPERATURE OF 40°C THROUGH A SINGLE OUTLET, AS REQUIRED BY CLAUSE 14(1) AND (2) OF THE AUSTRALIAN NEW ZEALAND FOOD STANDARDS CODE FOOD SAFETY STANDARD 3.2.3 PROVIDE AND MAINTAIN DISPENSABLE SOAP AND SINGLE USE TOWELS OR OTHER SUITABLE HAND DRYING FACILITIES NEAR THE WASH HAND BASIN.

ALL OPENINGS IN THE WALLS, FLOOR AND CEILING AND ALL EXTERNAL DOORS AND WINDOWS MUST BE VERMIN PROOF.

ALL WINDOWS AND DOORS TO THE EXTERNAL AIR ARE TO BE PROVIDED WITH FLY SCREENS.

A KITCHEN EXHAUST HOOD IS TO BE PROVIDED ABOVE ALL APPLIANCES OF HEATING CAPACITY GREATER THAN 8KW IN ACCORDANCE WITH AS 1668 PART 2. A TEST CERTIFICATE SHALL BE SUBMITTED TO THE PRINCIPAL CERTIFYING AUTHORITY WITH AN APPLICATION FOR AN OCCUPATION CERTIFICATE.

THE DOORS OF THE AIR-LOCK AND SANITARY COMPARTMENTS MUST BE CLOSE FITTING AND SELF CLOSING.


A LIQUID SOAP DISPENSER AND PAPER TOWEL DISPENSER MUST BE PROVIDED ABOVE OR ADJACENT TO THE HAND BASIN.

WASHING FACILITIES MUST BE PROVIDED AND COMPLY WITH THE FOOD PREMISES CODE.

NOT LESS THAN 100 LUX OF LIGHT TO BE AVAILABLE ON ALL SURFACES WHERE FOOD IS PREPARED, OR UTENSILS ARE WASHED AND STERILIZED IN ACCORDANCE WITH AS 1680.



COVING DETAILS

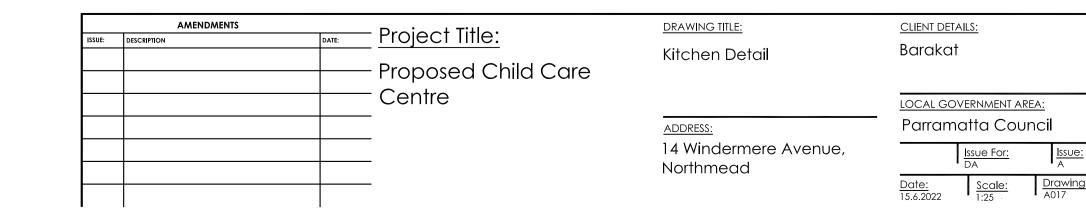

14 Windermere Street, Northmead

PROPOSED CHILDCARE CENTRE
COLOUR AND FINISHES SCHEDULE

Learning

FB1 - PGH BRICKS - DRY PRESSED

ARCHITECTURAL 'SILVER SHADOW' OR EQ

ALUMINIUM FENCING SLATS WITH TERRAIN FINISH OR EQUAL TO

ALUMINIUM WINDOW FRAMES WITH TERRAIN

JANSSEN DESIGNS info@janssendesigns.com.au | PO Box 41, Kenthurst 2156 | m: 0423 216 636 Nominated Architect: Jake Janssen NSW ARB 11575

CLADDING IN WHITE OR EQUAL TO

ARCHITECTURAL 'SILVER SHADOW' OR EQ -

FB1 - PGH BRICKS - DRY PRESSED

ALUMINIUM FENCING SLATS WITH TERRAIN FINISH OR EQUAL TO

FINISHES SCHEDULE TABLE:

BRICK WORK - FBI - PGH BRICKS - DRY PRESSED ARCHITECTURAL 'SILVER SHADOW' OR EQUAL TO.

CLADDING - C1 - JAMES HARDIE 'HARDIPLANK' WHITE OR EQUAL TO


WINDOW FRAMES - ALUMINIUM FRAMES WITH TERRAIN COLORBOND FINISH OR EQUAL TO.


FASCIA - COLORBOND FINISH WITH WHITE COLOUR OR EQUAL TO.


ROOF SHEETING - COLORBOND FINISH WITH WINDSPRAY COLOUR OR EQUAL TO.

FENCING TO FRONT BOUNDARY - ALUMINIUM FEATURE SLAT - TERRAIN OR EQUAL TO.


AMENDMENTS ISSUE: DESCRIPTION	 	ject Title: posed Child Care	DRAWING TITLE: Colour and Finishes Schedule	CLIENT DETAILS: Barakat
	Cer	ntre	ADDRESS: 14 Windermere Avenue, Northmead	LOCAL GOVERNMENT AREA: Parramatta Council Issue For:

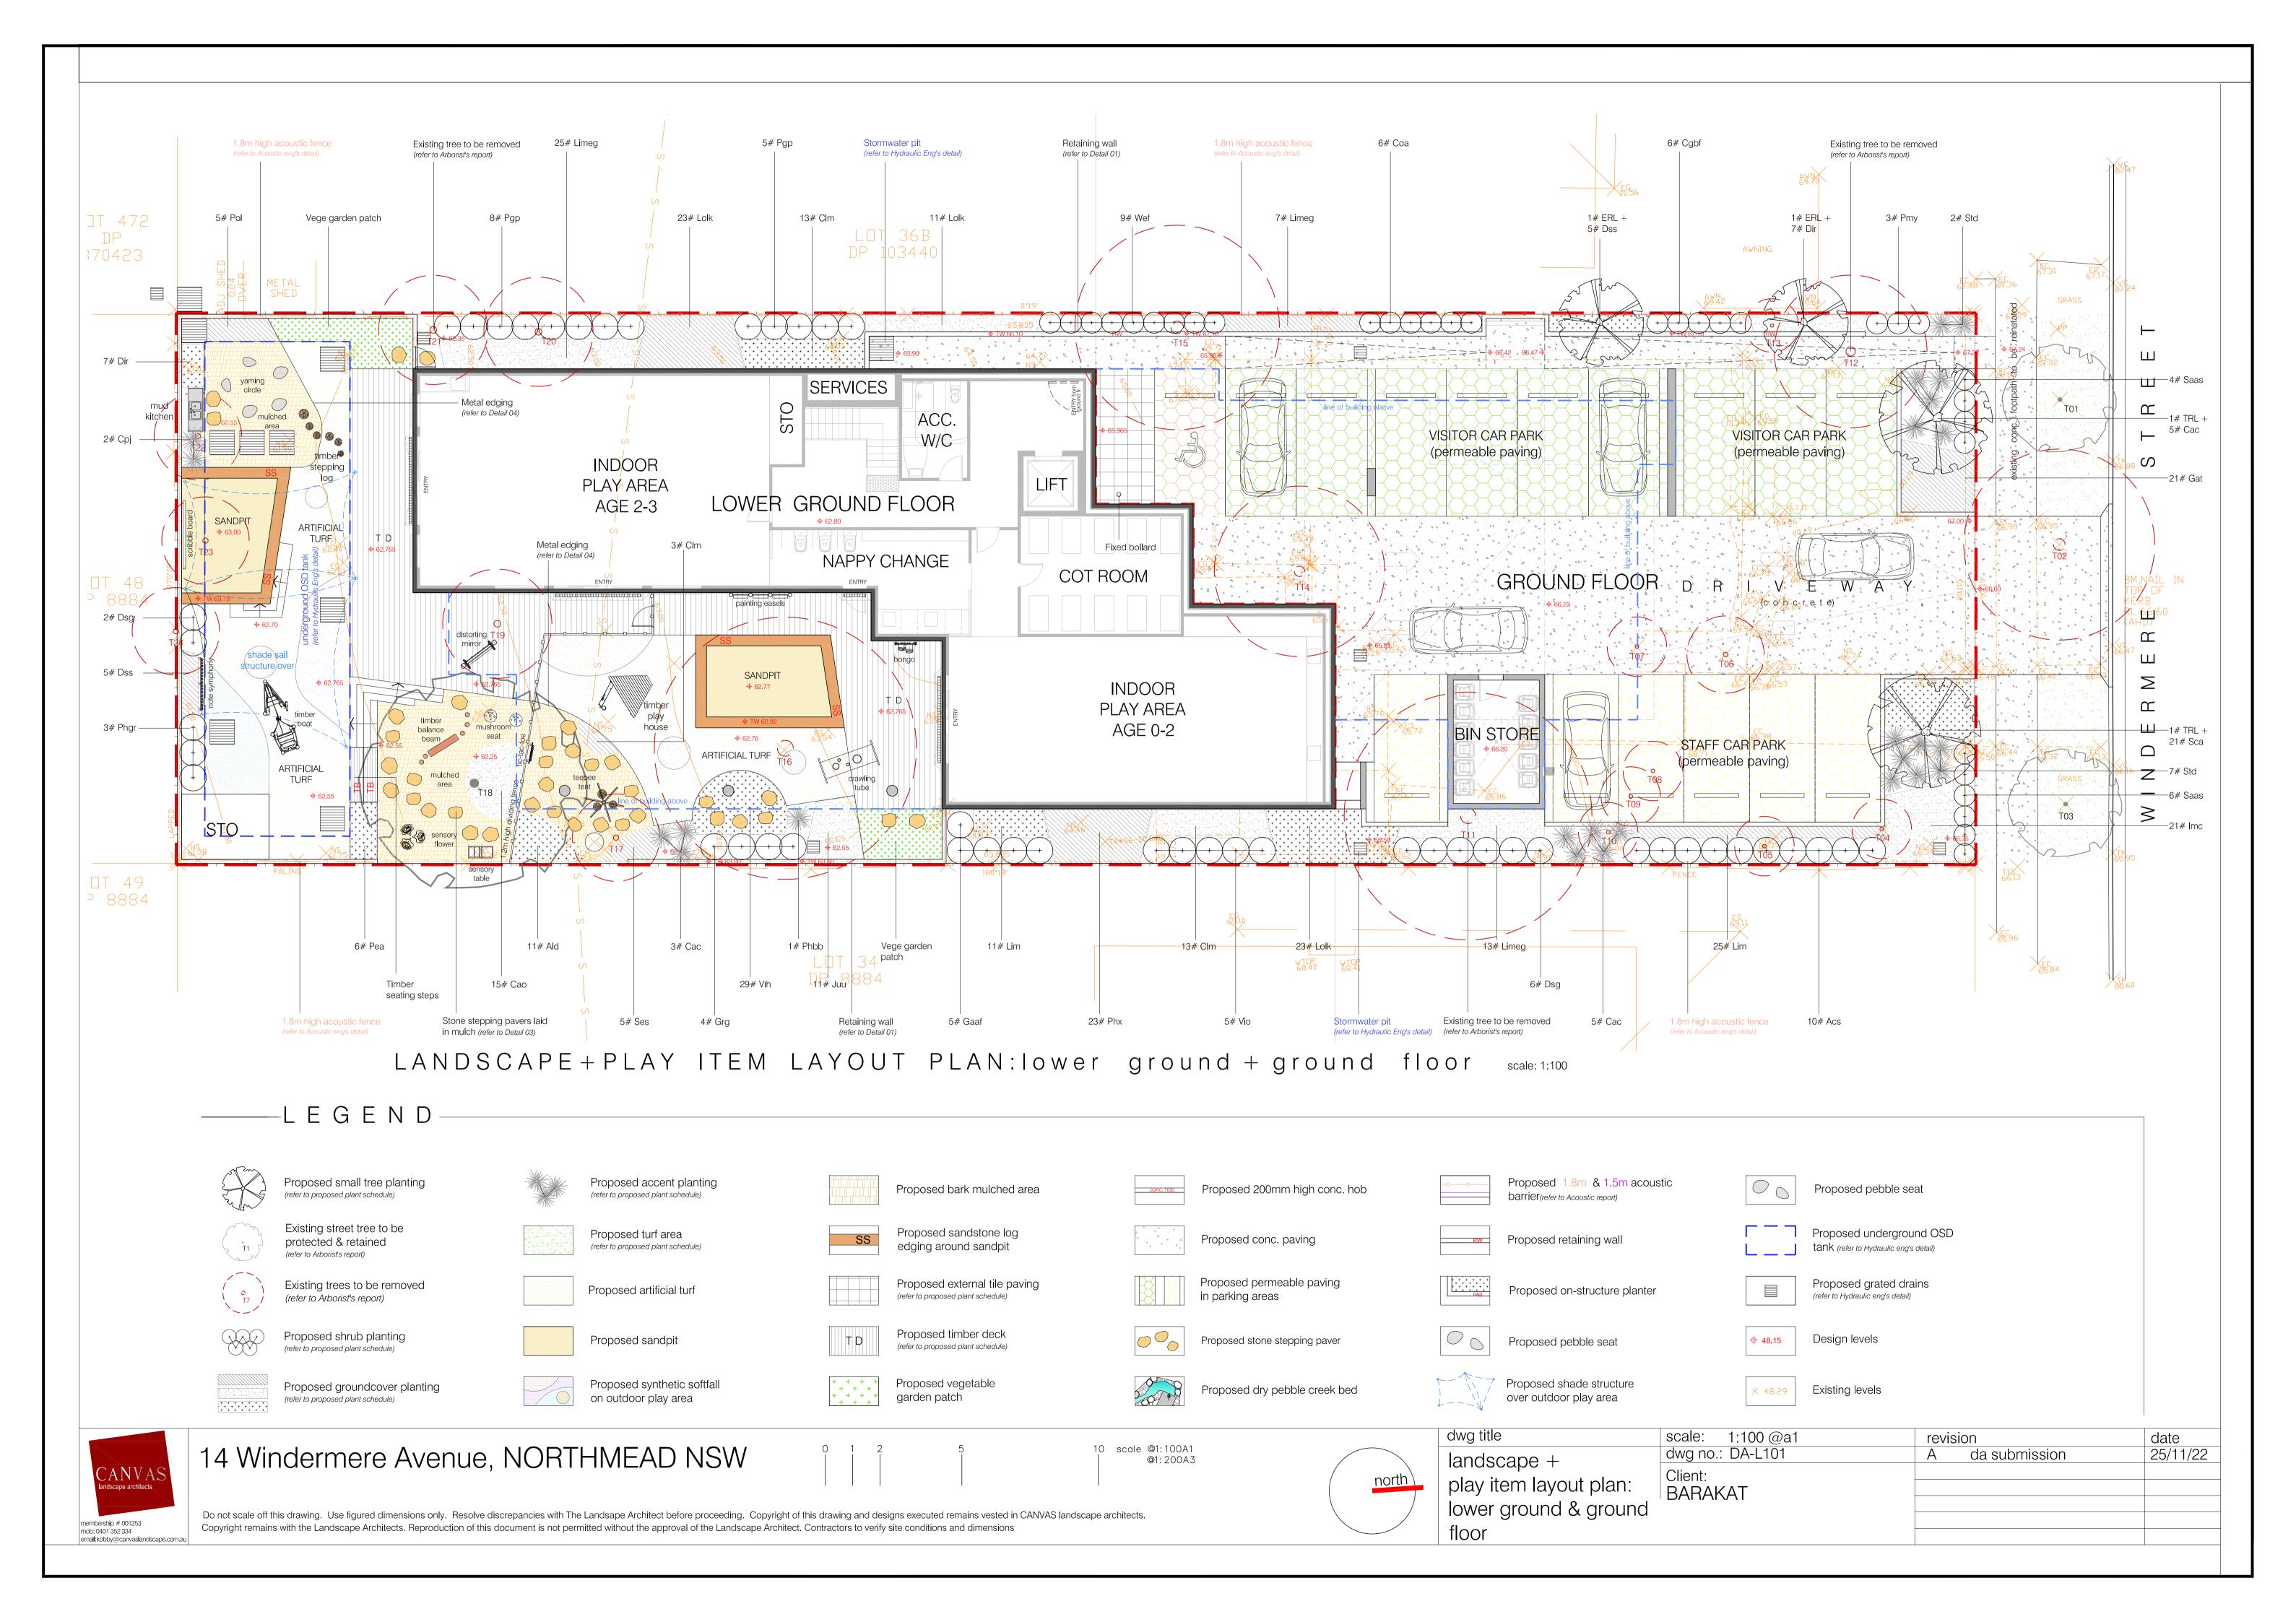

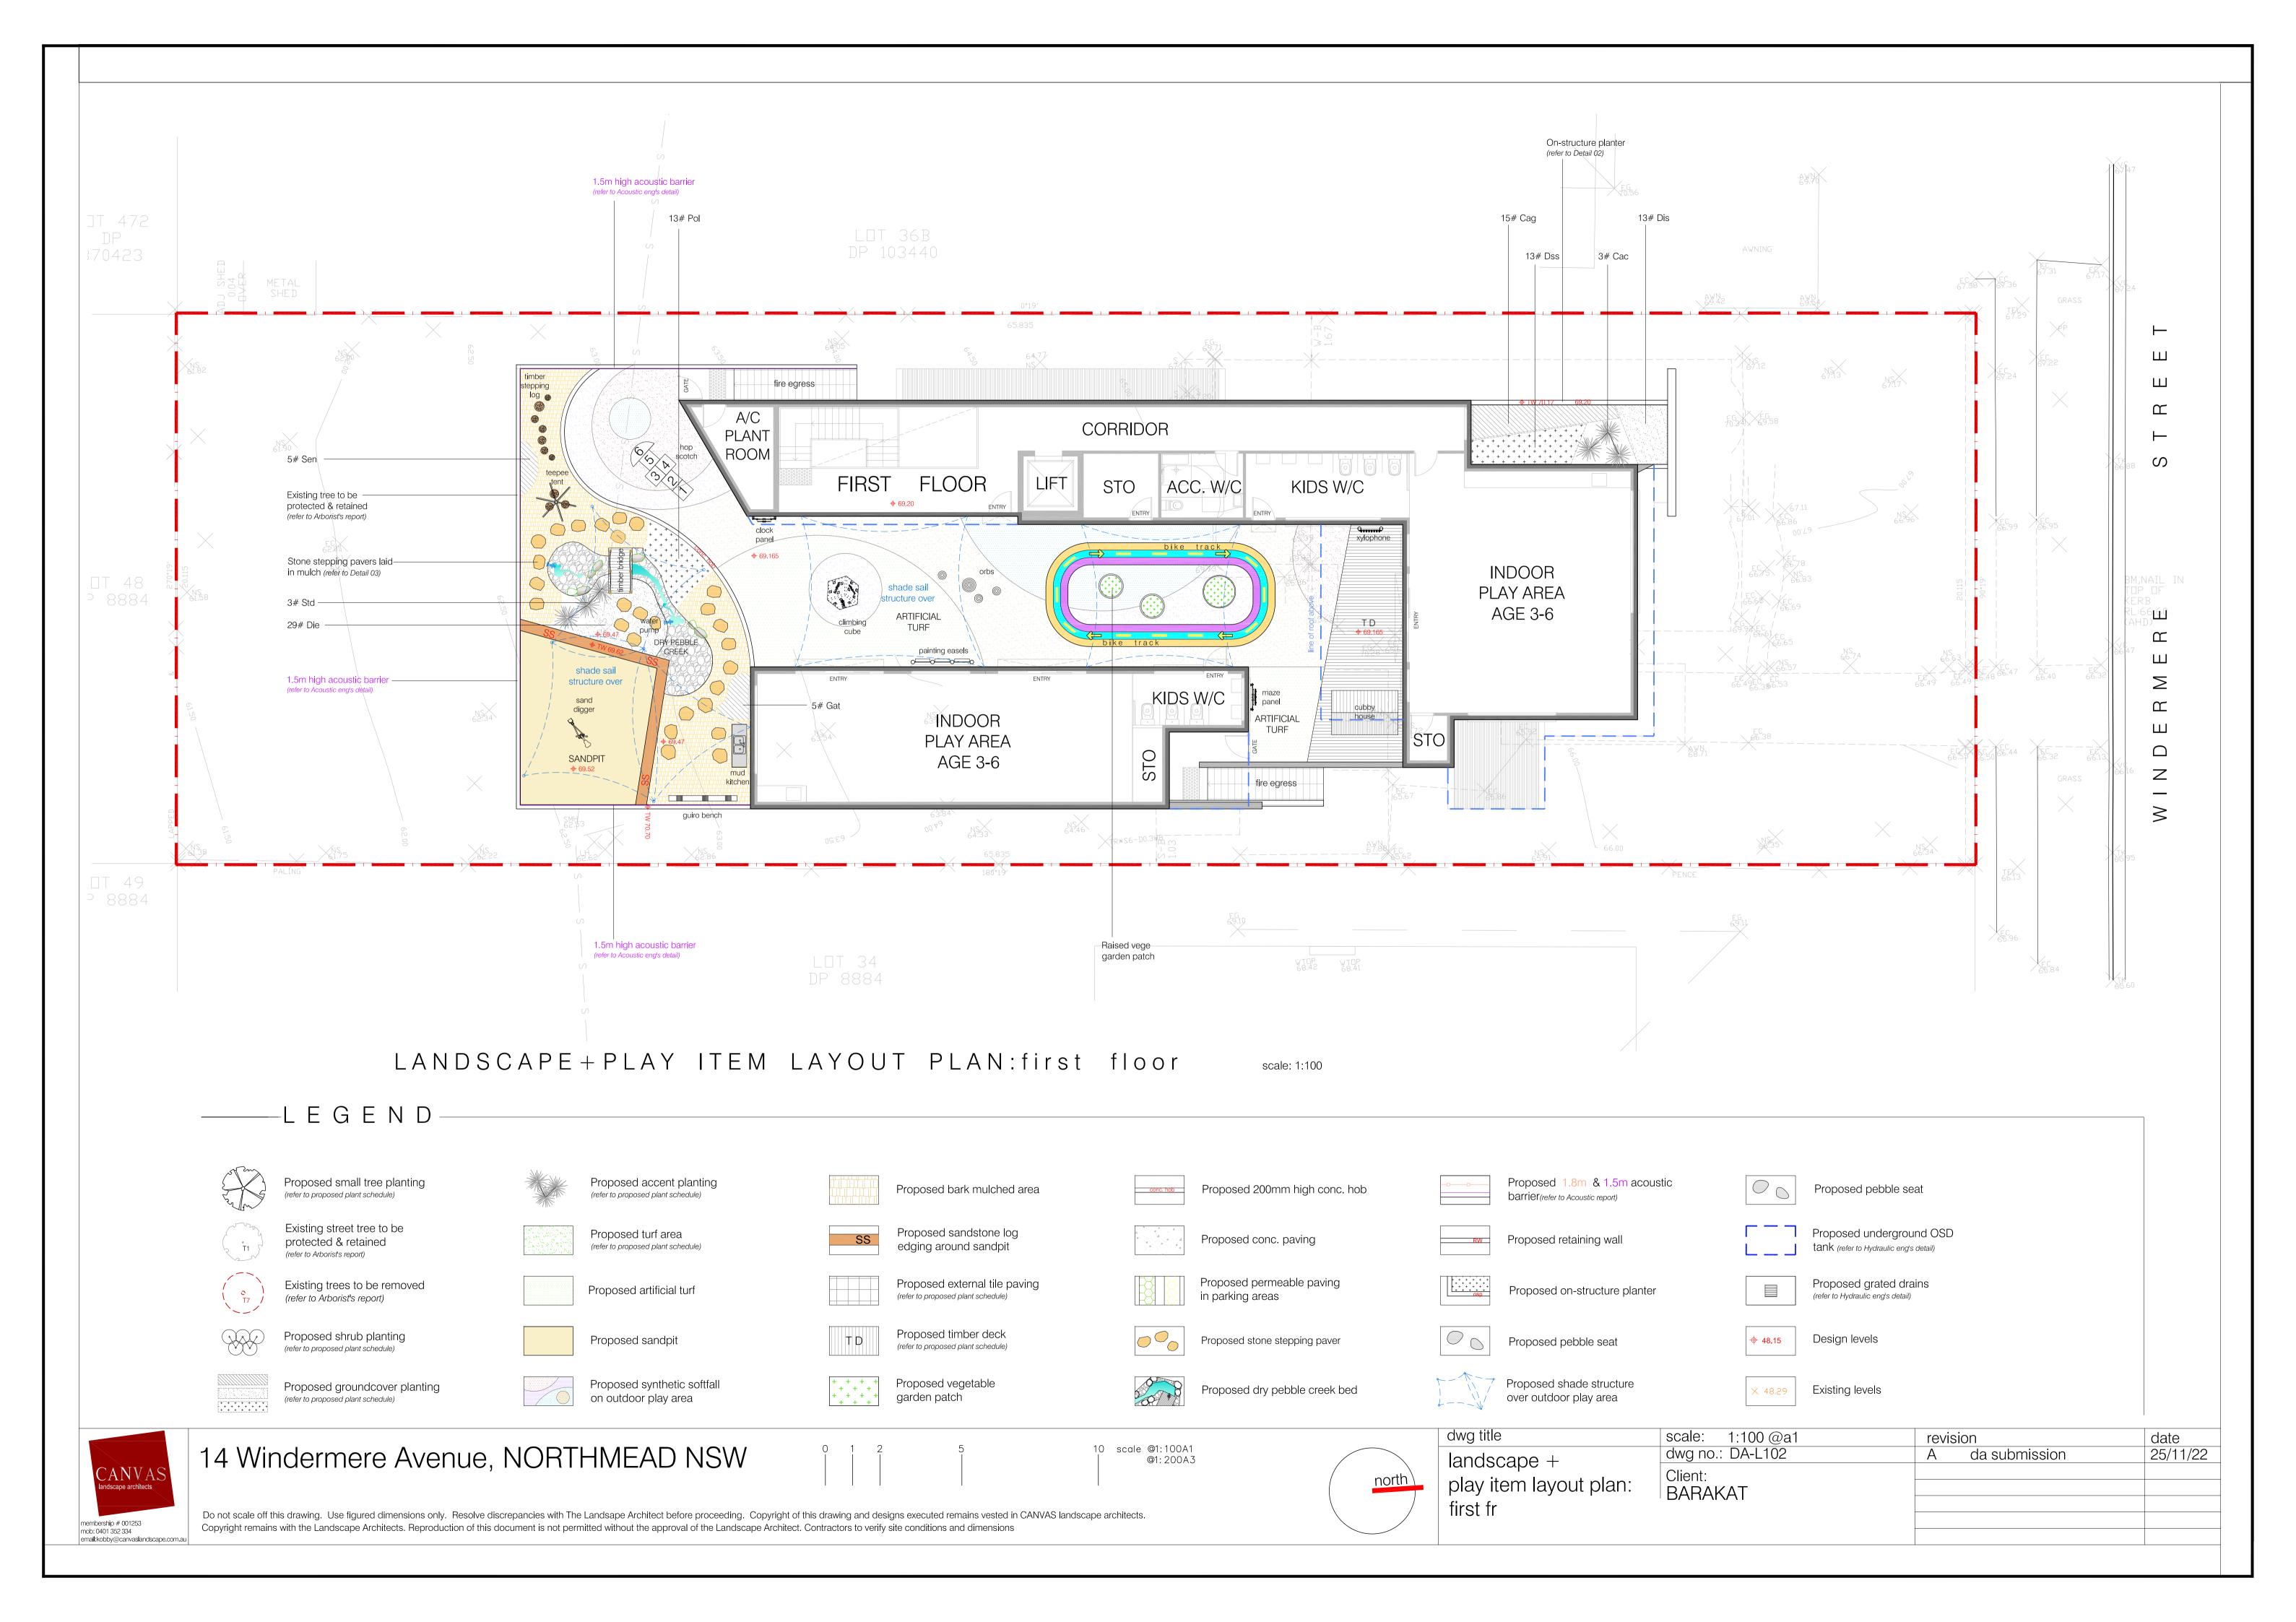

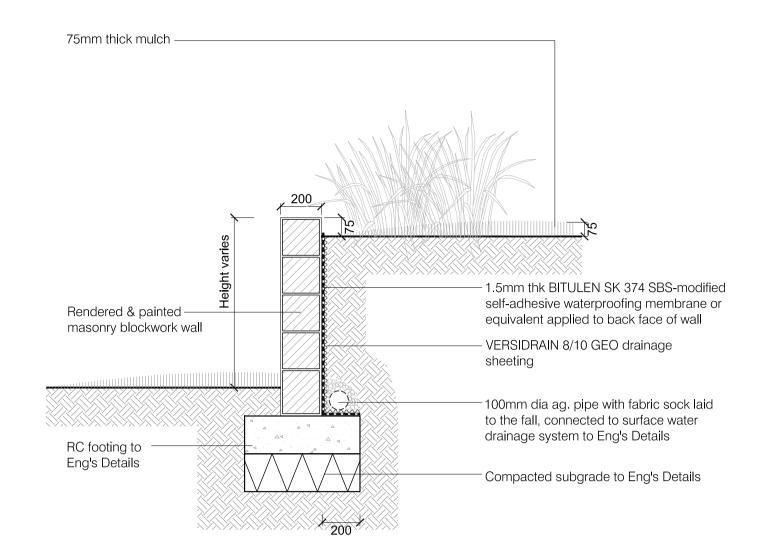

TYPICAL DETAIL 01: retaining wall scale: 1:20

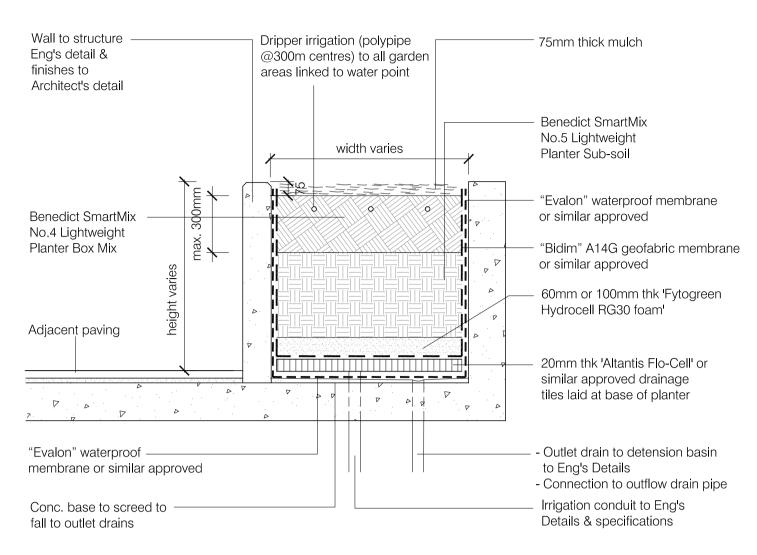

TYPICAL DETAIL 02: on-structure planter

MAINTENANCE PROGRAM

The typical range of maintenance tasks required over a 12 month period is summarised

Any information provided in the table must be assessed in the light of the weather and general site conditions. For example, watering frequency depends on the soil drainage and rainfall; fertiliser type and frequency needs to be adjusted to suit the plant requirements and the soil fertility and pH.

Mulch will need be topped up periodically to maintain a min. depth of 75mm. Mulch should be kept at least 50mm away from plant stems to reduce the rick of collar rot.

Weeds in mulched beds will need to be controlled by hand pulling or by the use of non residual herbicides. When using herbicides be very careful to avoid spray drifting onto valuable plants. the smallest contact with the chemicals can cause damage.


PLANT MAINTENANCE

Deep watering once or twice a week is more beneficial to plants than frequent light watering. Frequent watering will produce shallow roots and make the plant less stable and susceptible to drought. Maintain moisture to the bottom of the rootball for the first 3 months. To help safeguard plants remove labels immediately after planting. Where plants are susceptible to damage by vehicles to pedestrians, maintain protective fences until plants are well established Replace dead plants fortnightly until such time as alternative maintenance procedures are in places.


LAWN MAINTENANCE

Once lawn has been established, carry out watering and fertilising as suggested in the typical maintenance program. In summer, through watering, two or three times each week will encourage roots to go deeper in search of water. Mow grass as required to maintain an even tidy appearance.

	Frequency											
Maintenance Task	January	February	March	April	Мау	June	July	August	September	October	November	December
Grass												
Mowing lawn		WEEKI			AS R	EQUIRED				WFFKLY		
Watering lawn	TV	VICE WEE	KLY			AS REQU	IRED			TWICE	WEEKLY	
Feritilising lawn												
Weed control												
Top dressing												
Aerating				PRIOR	TO RESE	DING						
Reseeding												
Trees & Shrubs												
Watering		WEEKLY				AS REQU	IRED				W	FKI Y
Feritilising												
Pruning												
Mulching												
Weed control												
Thinning												
Insect & disease control												

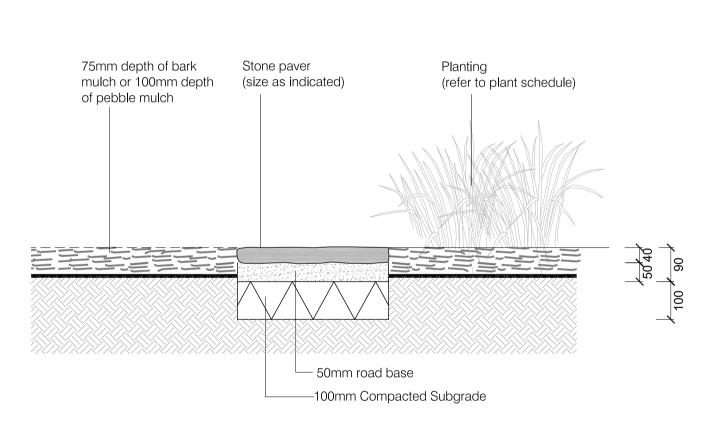

TYPICAL DETAIL 03: stone stepping paver

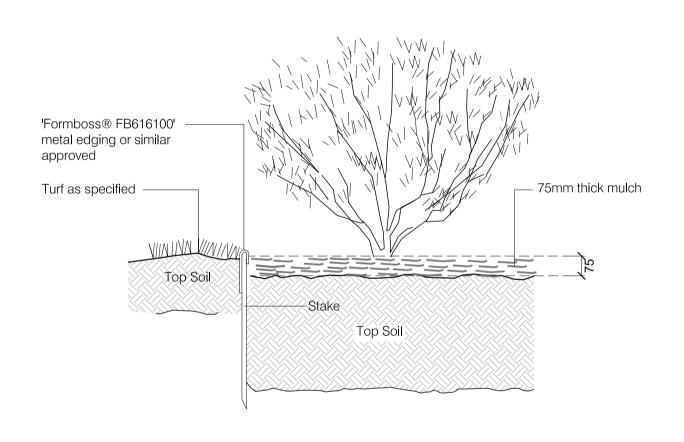

TYPICAL DETAIL 04: metal edging

		PROPO	SED	PLA	Ν
	CODE	BOTANICAL NAME	COMMON NAME	POT SIZE	MATURE HEIGHT
		TREES			
	ELR	Elaeocarpus reticulatus	Blue-berry Ash	100L	8m
	TRL	Tristaniopsis laurina	Water Gum	45L	8m
Н		SCREEN & BARRIER SHRUBS			

	THEE			
ELR	Elaeocarpus reticulatus	Blue-berry Ash	100L	8m
TRL	Tristaniopsis laurina	Water Gum	45L	8m
	SCREEN & BARRIER SHRUBS			
Acs	Acmena smithii var.minor	Dwarf Lillypilly	25L	3m
Cgbf	Callistemon "Great Balls of Fire"	Great Balls of Fire Bottlebrush	200mm	1.5m
Coa	Correa alba	White Correa	200mm	1.5m
Dsg	Duranta "Sheena's Gold"	Golden Dew Drop (Hedge)	25L	2m
Gaaf	Gardenia augusta 'Florida'	Gardenia 'Florida'	200mm	1.5m
Grg	Grevillea 'Robyn Gordon'	Robyn Gordon Grevillea	200mm	1.5m
Pgp	Pittosporum "Green Pillar"	Green Pillar Pittosporum	5L	3m
Phgr	Photinia glabra 'Rubens'	Photinia	25L	2m
Pmy	Philotheca myoporoides	Wax Flower	200mm	1.5m
Saas	Syzygium australe 'Aussie Southern'	Syzygium 'Aussie Southern'	5L	2m
Vio	Viburnum odoratissimum 'Emerald Lustre'	Emerald Lustre	300mm	2m
Wef	Westringia fruticosa	Coastal rosemary	200mm	1.5m
	ACCENT PLANTS			
Cac	Cordyline australis 'Cabernett'	Cordyline Cabernett	200mm	1.2m
Срј	Cordyline "Pink Joy"	Pink Joy Cordyline	200mm	1.2m
Phbb	Phormium 'Bronze Baby'	Bronze Baby Flax	200mm	0.8m
Std	Strelitzia reginae dwart	Dwarf Bird-of-Paradise	200mm	0.6m

NOTE.

native plant species

CODE	BOTANICAL NAME	COMMON NAME	POT SIZE	MATURE HEIGHT
	GROUND COVERS			
Ald	Alternanthera dentata	Ruby leaf alternanthera	200mm	0.5m
Cag	Casuarina glauca 'cousin it'	Cousin It	200mm	0.3m
Cao	Calathea ornata	Prayer/Peacock Plant	200mm	0.4m
Clm	Clivea miniata	Kaffir Lilly	140mm	0.4m
Die	Dichondra repens	Kidney Weed	200mm	0.1m
Dir	Dianella revoluta 'little rev'	Black Anther Flax Lily	200mm	0.3m
Dis	Dichondra 'silver falls'	Dichondra	200mm	0.2m
Dss	Dianella Silver Streak	Silver Streak Flax Lily	200mm	0.4m
Gat	Gazania tomentosa	Gazania	200mm	0.2m
Imc	Imperata cylindrica	Blady Grass	200mm	0.6m
Juu	Juncus usitatus	Tussock Rush	200mm	0.9m
Lim	Liriope muscari 'Variegata'	Variegata Lily Turf	150mm	0.3m
Limeg	Liriope muscari 'Evergreen Giant'	Giant Lily Turf	200mm	0.6m
Lolk	Lomandra longifolia 'Katrinus'	Spiny-headed Mat-rush 'Katrinus'	200mm	0.7m
Pea	Pennisetum alopecuroides	Black Lea	200mm	0.8m
Phx	Philodendron 'Xanadu'	Xanadu	200mm	1m
Pol	Poa labilladieri	Tussock Grass	200mm	0.8m
Sca	Scaevola 'Purple Fanfare	Puple Fan Flower	200mm	0.3m
Ses	Senecio serpens	Dwarf Blue Chalk Sticks	200mm	0.2m
Vih	Viola hederacea	Native Violet	200mm	0.1m
	TURF GRASS			

Sir Walter Buffalo

SCHEDULE

PROPOSED PLANTING & SAMPLE PLAY ITEMS IMAGE PALETTE



























































As noted | Stenotaphrum secundatum










roll

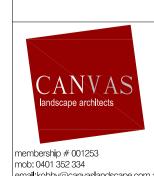

14 Windermere Avenue, NORTHMEAD NSW

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dwg title landscape typical details, proposed plant schedule & maintenance program

	scale: 1:10 & 20 @a1	revision		date
	dwg no.: DA-L103	Α	da submission	25/11/2
nt	Client: BARAKAT			

PROPOSED CHILDCARE CENTRE AT 14 WINDERMERE AVENUE, NORTHMEAD NSW 2152


GENERAL NOTES


- ALL WORKS SHALL BE IN ACCORDANCE WITH B.C.A AND AS3500.3
- ALL EXISTING LEVELS TO BE CONFIRMED BY BUILDER PRIOR TO CONSTRUCTION.
- THE BUILDER SHALL ENSURE THAT THE STORMWATER ENGINEERS DRAWINGS CORRESPOND TO THE ARCHITECTURAL, STRUCTURAL, AND LANDSCAPING DRAWINGS. IF THERE EXISTS ANY DISCREPANCIES BETWEEN THE DRAWINGS, THE BUILDER SHALL REPORT THE DISCREPANCIES TO THE ENGINEER PRIOR TO COMMENCEMENT OF ANY WORKS
- PRIOR TO COMMENCING ANY WORKS, THE BUILDER SHALL ENSURE THAT THE INVERT LEVELS OF WHERE THE SITE STORMWATER SYSTEM CONNECTS INTO THE COUNCILS KERB/DRAINAGE SYSTEM MATCHED THE DESIGN LEVELS. ANY DISCREPANCIES SHALL BE REPORTED TO THE DESIGN ENGINEER
- THE DRAINAGE CONTRACTOR IS TO LOCATE AND RELOCATE AS NECESSARY ALL SERVICES ON SITE.
- ALL LEVELS SHALL RELATE TO THE ESTABLISHED BENCH MARK. THIS IS TYPICALLY METRES TO AUSTRALIAN HEIGHT DATUM (AHD).
- ALL DOWNPIPES TO BE 100MM DIAMETER UNLESS NOTED OTHERWISE.
- ALL DOWN PIPES TO HAVE LEAF GUARDS.
- ALL LINES ARE TO BE 100MM DIAMETER uPVC AT A MINIMUM 1.0% SLOPE UNLESS NOTED OTHERWISE. LINES ARE TO BE SEWER-GRADE AND SEALED.
- G10 ALL PIPES TO HAVE MINIMUM 150MM COVER IF LOCATED WITHIN PROPERTY.
- G11 ALL THE CLEANING EYES (OR INSPECTION EYES) FOR THE UNDERGROUND PIPES HAVE TO BE TAKEN UP TO THE FINISHED GROUND LEVEL FOR EASY IDENTIFICATION AND MAINTENANCE PURPOSES
- G12 ALL SUB-SOIL DRAINAGE SHALL BE OF A MINIMUM 100MM DIAMETER AND SHALL BE PROVIDED WITH A FILTER SOCK. THE SUBSOIL DRAINAGE SHALL BE INSTALLED IN ACCORDANCE WITH DETAILS TO BE PROVIDED BY THE LANDSCAPE ARCHITECT OR STORMWATER ENGINEER
- G13 ALL RETAINING WALLS SHALL BE CONSTRUCTED COMPLETELY WITHIN THE PROPERTY BOUNDARY LIMITS TO DETAILS PREPARED BY THE STRUCTURAL ENGINEER. WALLS FORMING THE ON-SITE DETENTION SYSTEM SHALL BE OF MASONARY/BRICK/CONCRETE CONSTRUCTION AND WATER TIGHT.
- G14 ALL MULCHING TO BE USED WITHIN THE AREA DESIGNATED AS ON-SITE DETENTION STORAGE SHALL BE OF A NON-FLOTABLE MATERIAL SUCH AS DECORATIVE RIVER GRAVEL. PINE PARK MULCHING SHALL NOT BE USED WITHIN THE DETENTION STORAGE AREA.
- G15 ALL DRAINAGE WORKS ARE TO AVOID TREE ROOTS. ROOT BARRIER TO BE INSTALLED ADJACENT TO TREE ZONES WHERE DRAINAGE MAY BE AT RISK.
- G16 ALL WORK WITHIN COUNCIL RESERVE TO BE INSPECTED BY COUNCIL PRIOR TO CONSTRUCTION.
- G17 COUNCIL'S ISSUED FOOTWAY DESIGN LEVELS TO BE INCORPORATED INTO THE FINISHED LEVELS ONCE ISSUED BY COUNCIL


RAINWATER TANKS

- RAINWATER TANK, DRAINED ROOF AREAS AND REUSE PLUMBING TO COMPLY WITH BASIX REQUIREMENTS AND CERTIFICATE.
- ADEQUATE SCREENING TO PREVENT MOSQUITO BREEDING AND ENTRY OF ANIMAL OR FLOATING MATTER
- A 'FIRST FLUSH' DIVERSION TO REMOVE ROOF CONTAMINANTS MUST BE PROVIDED.
- TANKS TO BE PUMPED TO TOP-UP FROM THE POTABLE WATER SUPPLY DURING DRY PERIOD WHEN THE TANK IS 80% EMPTY.
- PUMP TO BE SUITABLY SOUNDPROOFED
- A SIGN IS TO BE INSTALLED NEAR THE RAINWATER TANK HIGHLIGHTING "NOT FOR HUMAN CONSUMPTION".

LEGEND

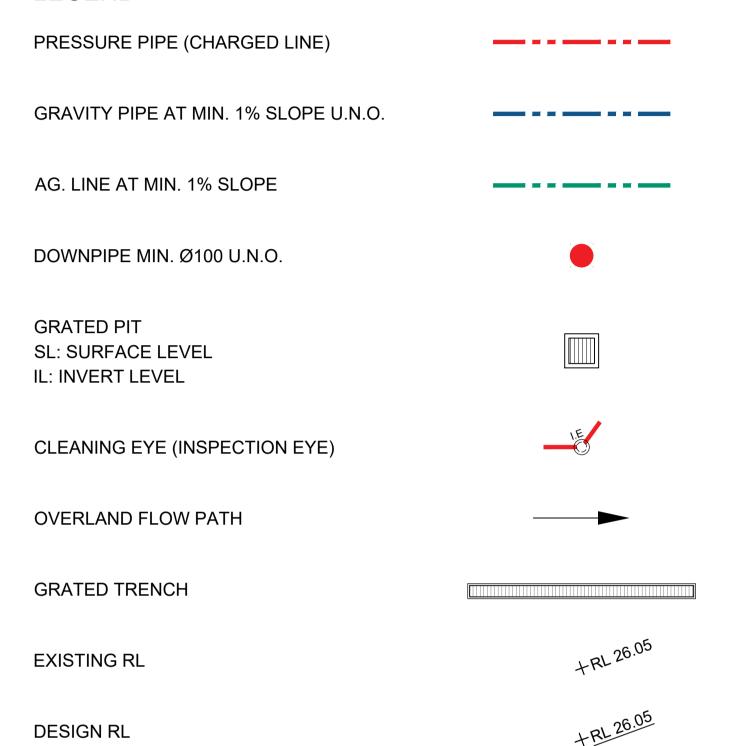


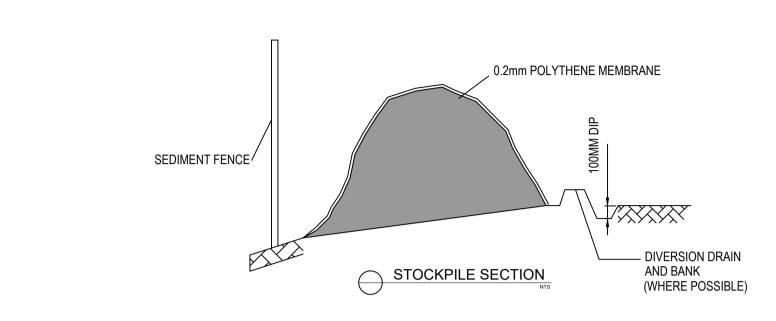

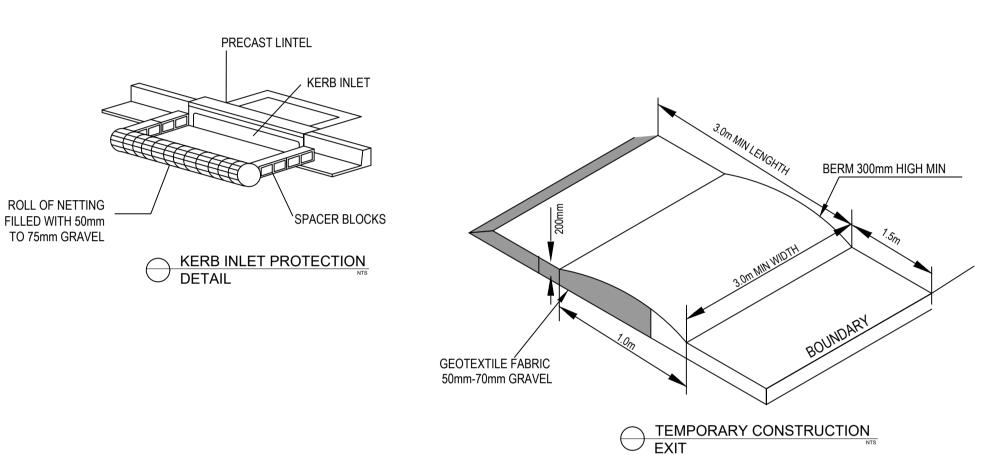

SEDIMENT & EROSION CONTROL

- S1 PLANS ARE MINIMUM REQUIREMENTS AND ARE TO BE USED AS A GUIDE ONLY. EXACT MEASURES USED SHALL BE DETERMINED ON SITE IN CONJUNCTION WITH PROGRAM OF CONTRACTORS WORKS.
- IMMEDIATELY FOLLOWING SETTING OUT OF THE WORKS. BUT PRIOR TO COMMENCEMENT OF ANY CLEARING OR EARTHWORKS, THE CONTRACTOR AND SUPERINTENDENT SHALL WALK THE SITE TO NOMINATE THE LOCATIONS AND TYPES OF SEDIMENT AND EROSION CONTROL MEASURE TO BE ADOPTED. THESE MEASURES SHALL BE IMPLEMENTED PRIOR TO ANY CLEARING OR EARTHWORKS AND MAINTAINED UNTIL THE WORKS ARE COMPLETED AND NO LONGER POSE AN EROSION HAZARD. UNLESS OTHERWISE APPROVED BY THE SUPERINTENDENT.
- IMMEDIATELY FOLLOWING SETTING OUT OF THE WORKS. BUT PRIOR TO COMMENCEMENT OF ANY CLEARING OR EARTHWORKS. THE CONTRACTOR AND SUPERINTENDENT SHALL WALK THE SITE TO IDENTIFY AND MARK TREES WHICH ARE TO BE PRESERVED. NOTWITHSTANDING THE ABOVE. THE CONTRACTOR SHALL TAKE ALL REASONABLE PRECAUTIONS TO MINIMISE DISTURBANCE TO EXISTING VEGETATION AND GROUND COVER OUTSIDE THE MINIMUM AREAS REQUIRED TO COMPLETE THE WORKS AND SHALL BE RESPONSIBLE FOR RECTIFICATION, AT ITS OWN COST, OF ANY DISTURBANCE BEYOND THOSE AREAS.
- PROVIDE GULLY GRATE INLET SEDIMENT TRAPS AT ALL GULLY PITS.
- PROVIDE SILT FENCING ALONG PROPERTY LINE AS DIRECTED BY SUPERINTENDENT.
- ADDITIONAL CONTROL DEVICES TO BE PLACED WHERE DIRECTED BY THE PRINCIPLE.
- ALTERNATIVE DESIGNS TO BE APPROVED BY SUPERINTENDENT PRIOR TO CONSTRUCTION.
- WASH DOWN/RUMBLE AREA TO BE CONSTRUCTED WITH PROVISIONS RESTRICTING ALL SILT AND TRAFFICKED DEBRIS FROM ENTERING THE STORMWATER SYSTEM.
- NO WORK OR STOCKPILING OF MATERIALS TO BE PLACED OUTSIDE OF SITE WORK BOUNDARY.
- S10 APPROPRIATE EROSION AND SEDIMENT CONTROLS TO BE USED TO PROTECT STOCKPILES AND MAINTAINED THROUGHOUT CONSTRUCTION.
- S11 IT IS THE CONTRACTORS RESPONSIBILITY TO TAKE DUE CARE OF NATURAL VEGETATION. NO CLEARING IS TO BE UNDERTAKEN WITHOUT PRIOR APPROVAL FROM THE SUPERINTENDENT.
- S12 TO AVOID DISTURBANCE TO EXISTING TREES. EARTHWORKS WILL BE MODIFIED AS DIRECTED ON SITE BY THE SUPERINTENDENT.

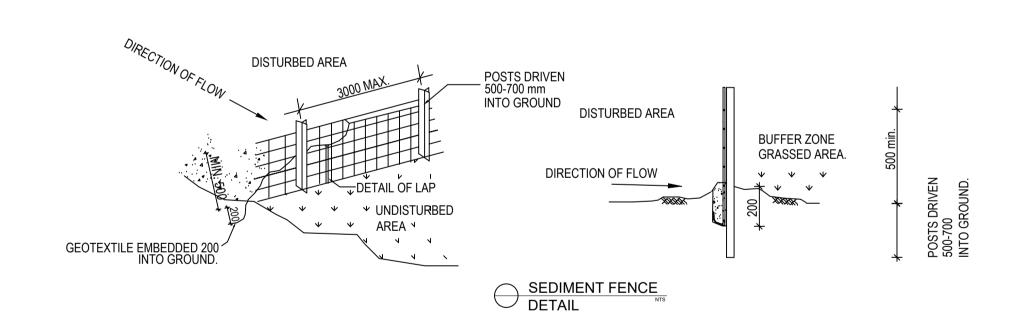

SEDIMENT FENCE

- F1 FILTER CLOTH TO BE FASTENED SECURELY TO POSTS WITH GALVANISED WIRE TIES, STAPLES OR ATTACHMENT BELTS.
- WHEN TWO SECTIONS OF FILTER CLOTH ADJOIN EACH OTHER THEY SHALL BE OVERLAPPED BY 150MM AND FOLDED.
- POSTS SHALL NOT BE SPACED MORE THAN 3.0 METRES APART.
- F4 FOR EXTRA STRENGTH TO SILT FENCE, WOVEN WIRE (14MM GAUGE, 150MM MESH SPACING) TO BE FASTENED SECURELY BETWEEN FILTER CLOTH AND POSTS BY WIRE TIES OR STAPLES
- F5 INSPECTIONS SHALL BE PROVIDED ON A REGULAR BASIS, SPECIALLY AFTER RAINFALL AND EXCESSIVE SILT DEPOSITS REMOVED WHEN "BULGES" DEVELOP IN SILT FENCE SEDIMENT FENCES SHALL BE CONSTRUCTED WITH SEDIMENT TRAPS AND EMERGENCY SPILLWAYS AT SPACINGS NO GREATER THAN 40M ON FLAT TERRAIN DECREASING TO 20M SPACINGS ON STEEP TERRAIN

NOTE DO NOT SCALE OFF DRAWINGS. REFER TO ARCHITECTURAL PLANS FOR LEVELS, STEPS, DIMENSIONS AND SETOUT. VERIFY

DIMENSIONS ON SITE. THE ENGINEER

BEFORE COMMENCEMENT OF WORKS


SHALL BE NOTIFIED OF ANY VARIATIONS

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AT: 14 WINDERMERE AVE, NORTHMEAD NSW 2152	DESIGNED BY: B.P	DATE: 28/09/2022	
GENERAL NOTES	DRAWN BY: B.P	SCALE: AS SHOWN	



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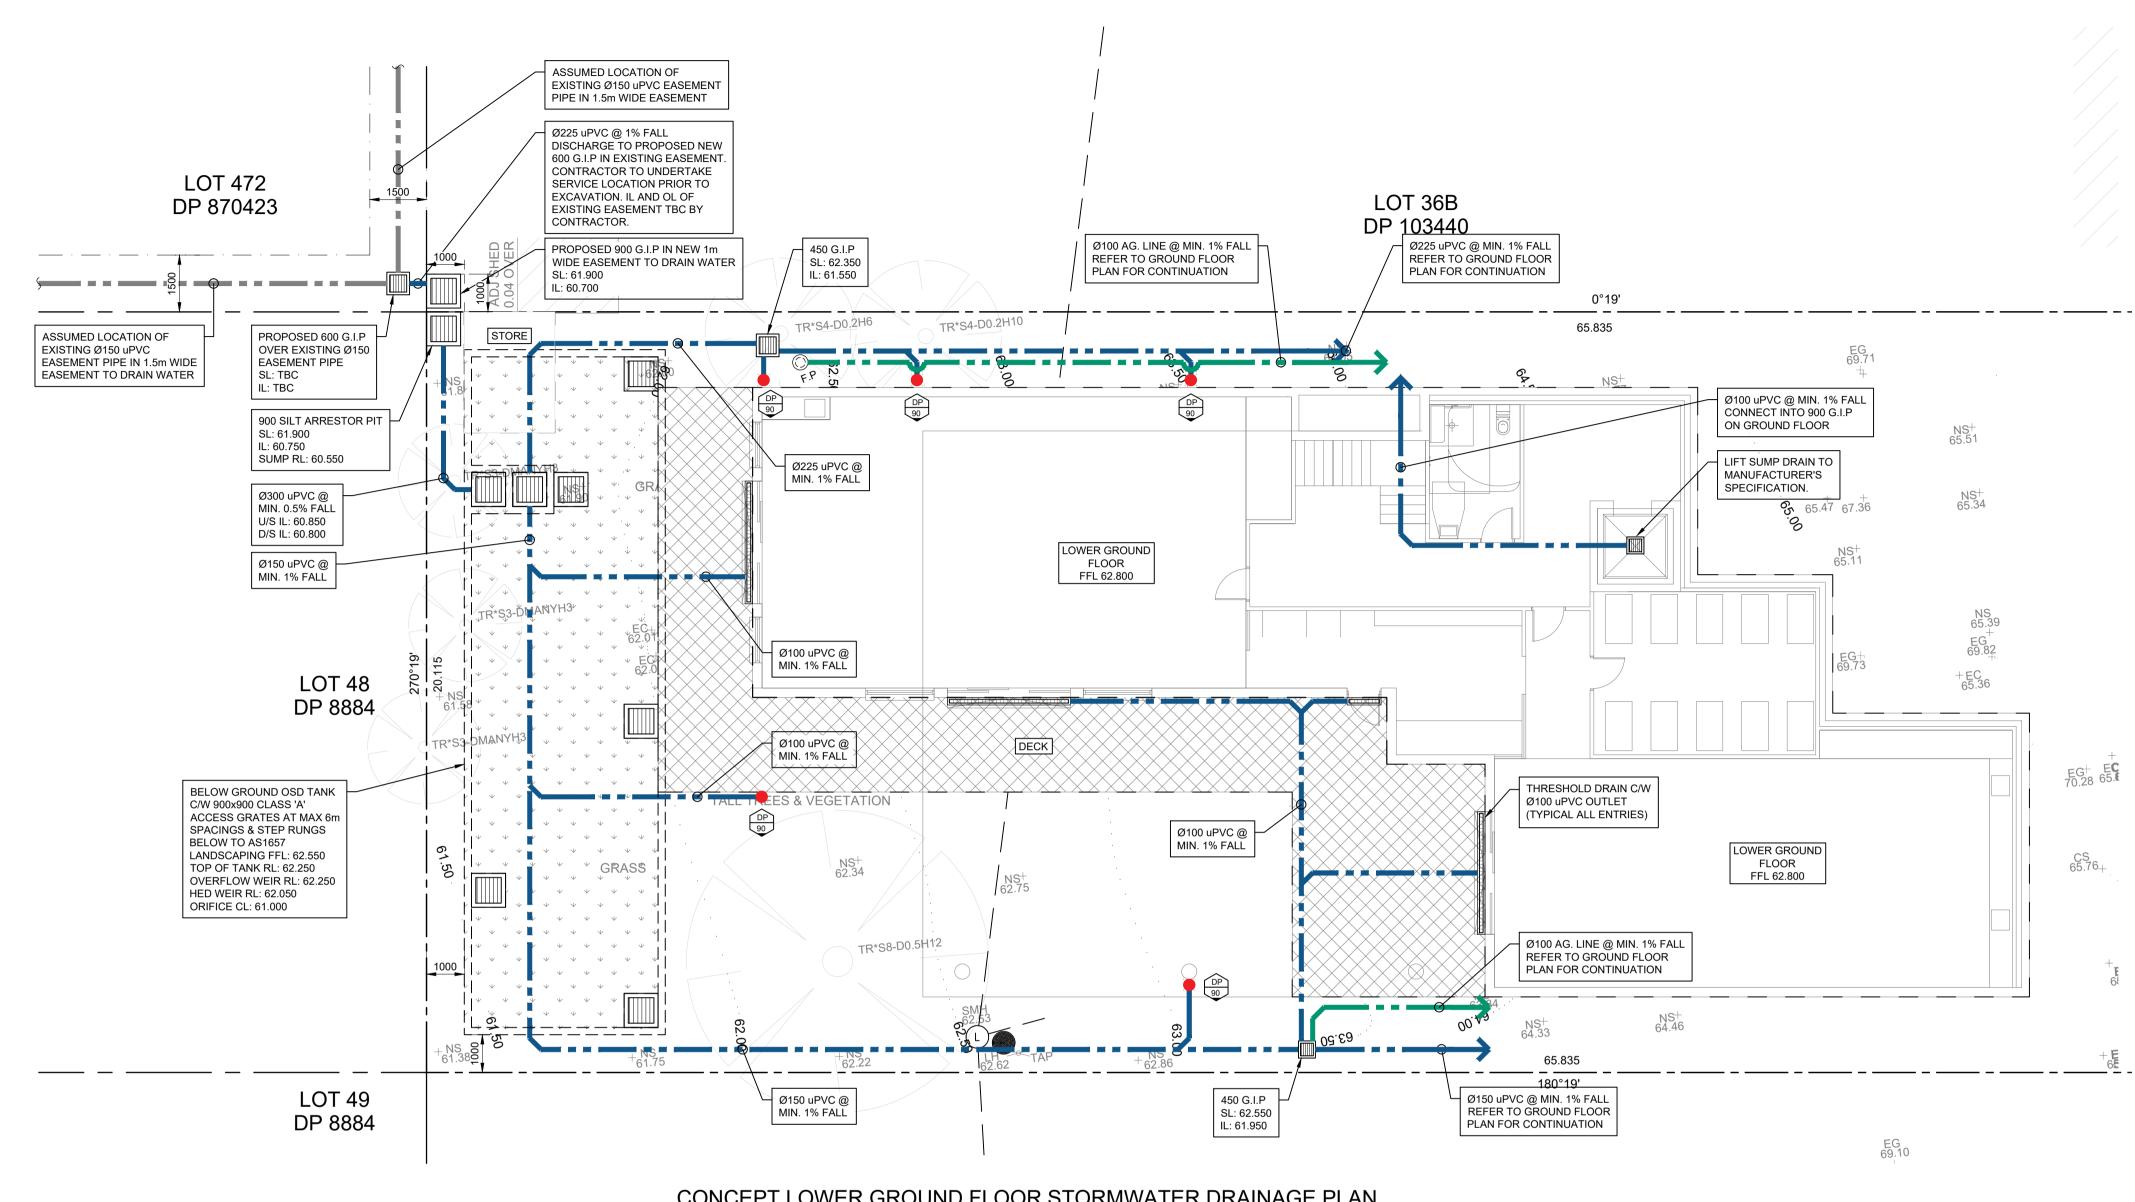
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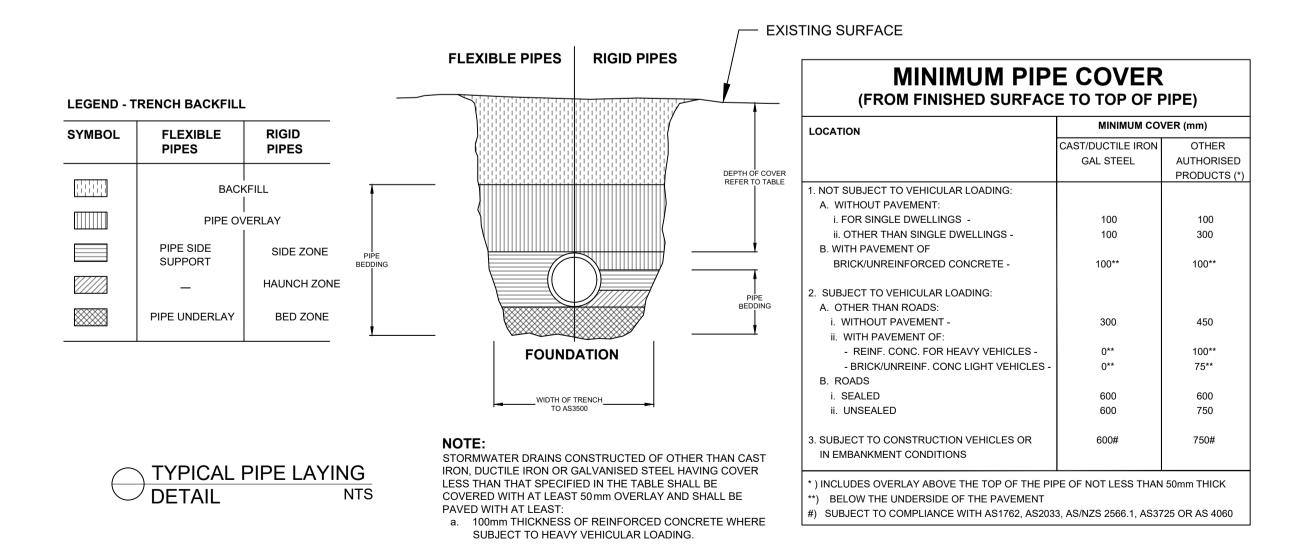
PROPOSED JOB NUMBER: ORIGINAL SIZE: DWG NUMBER: C001 220214 **CHILDCARE CENTRE** AT: 14 WINDERMERE AVE, NORTHMEAD NSW 2152 DESIGNED BY: DATE: 28/09/2022 CONCEPT STORMWATER CATCHMENT PLAN SCALE: AS SHOWN / ON-SITE DETENTION DETAILS

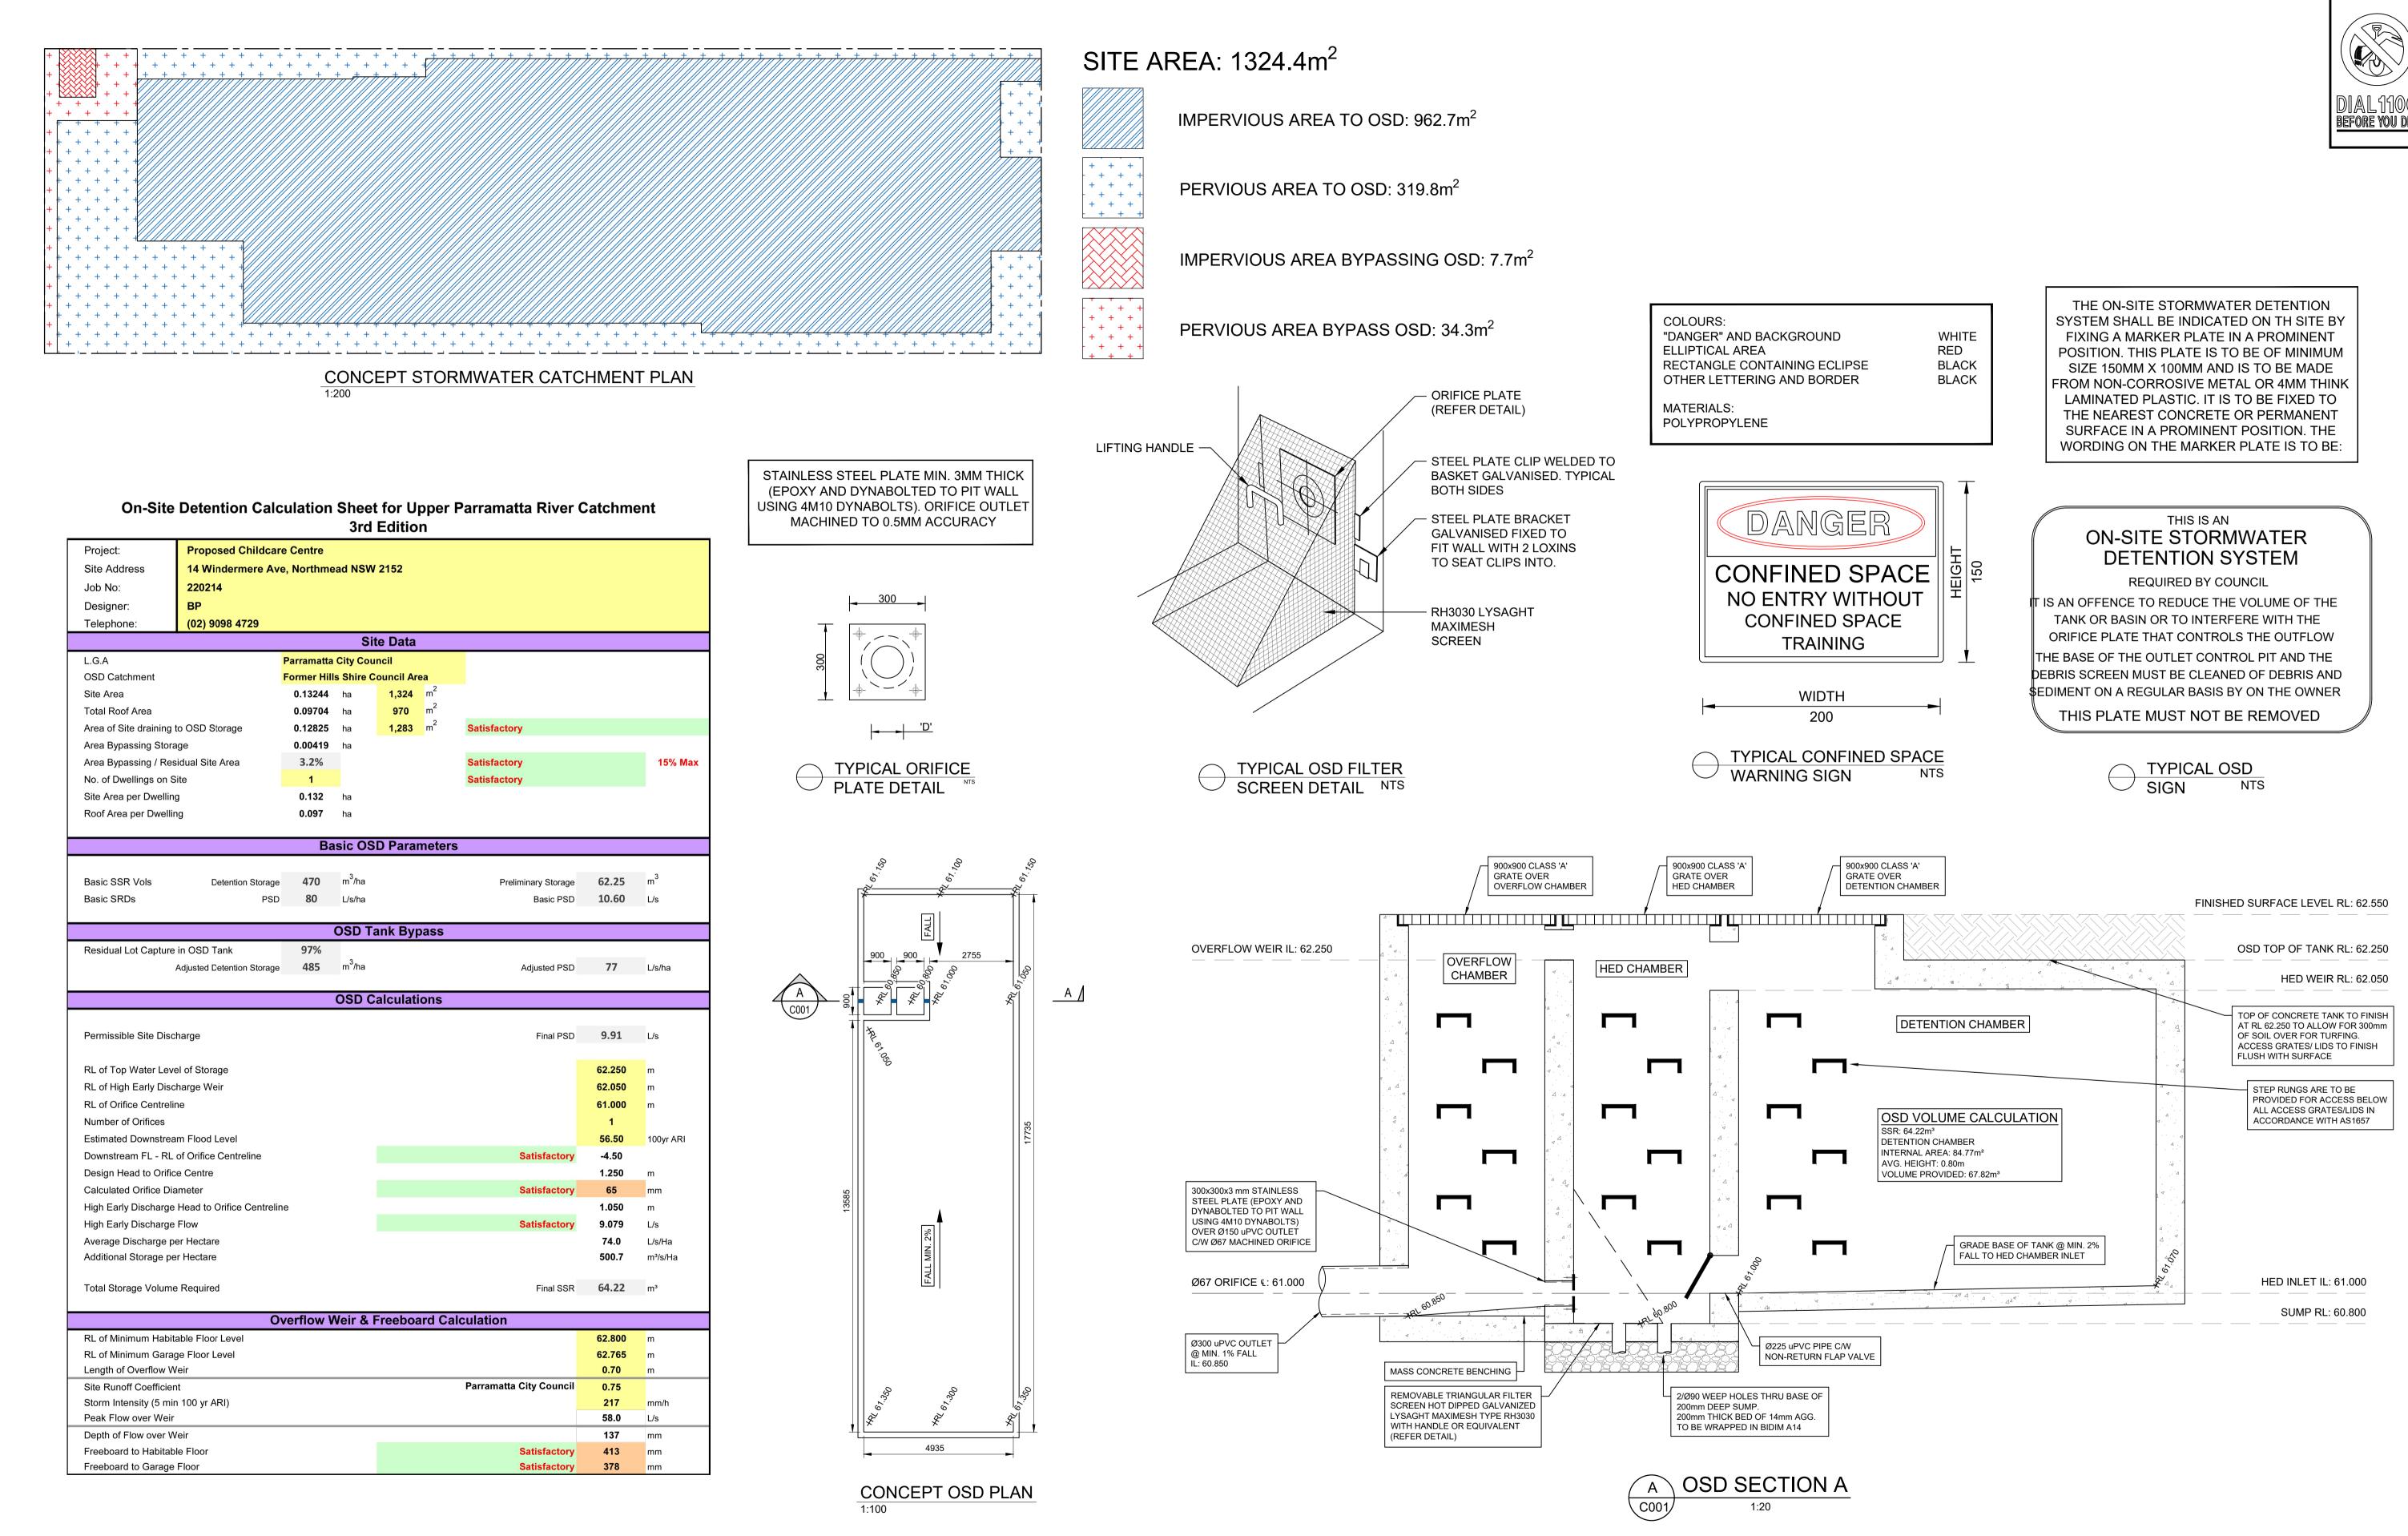



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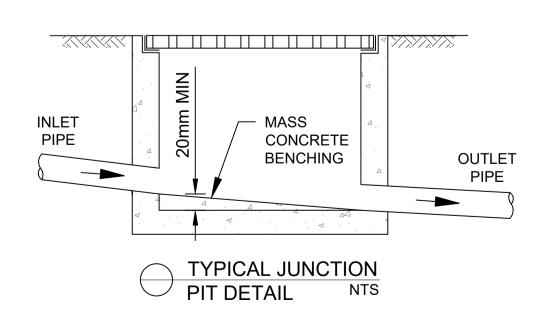








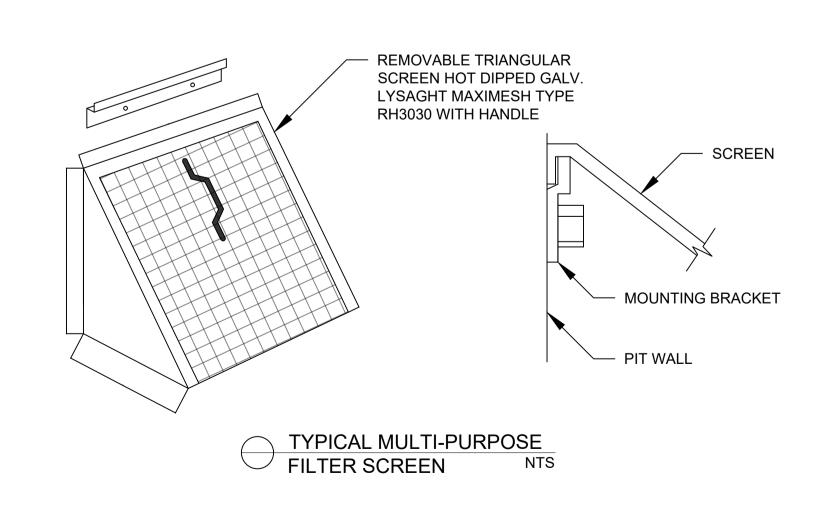

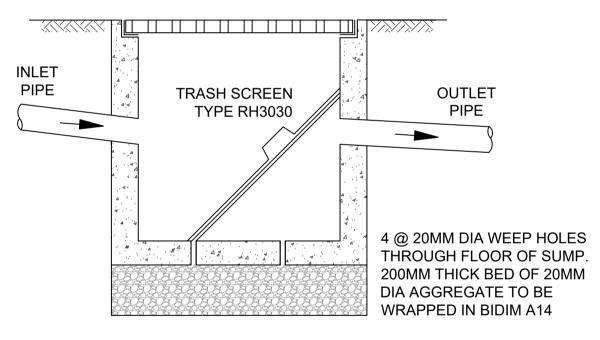

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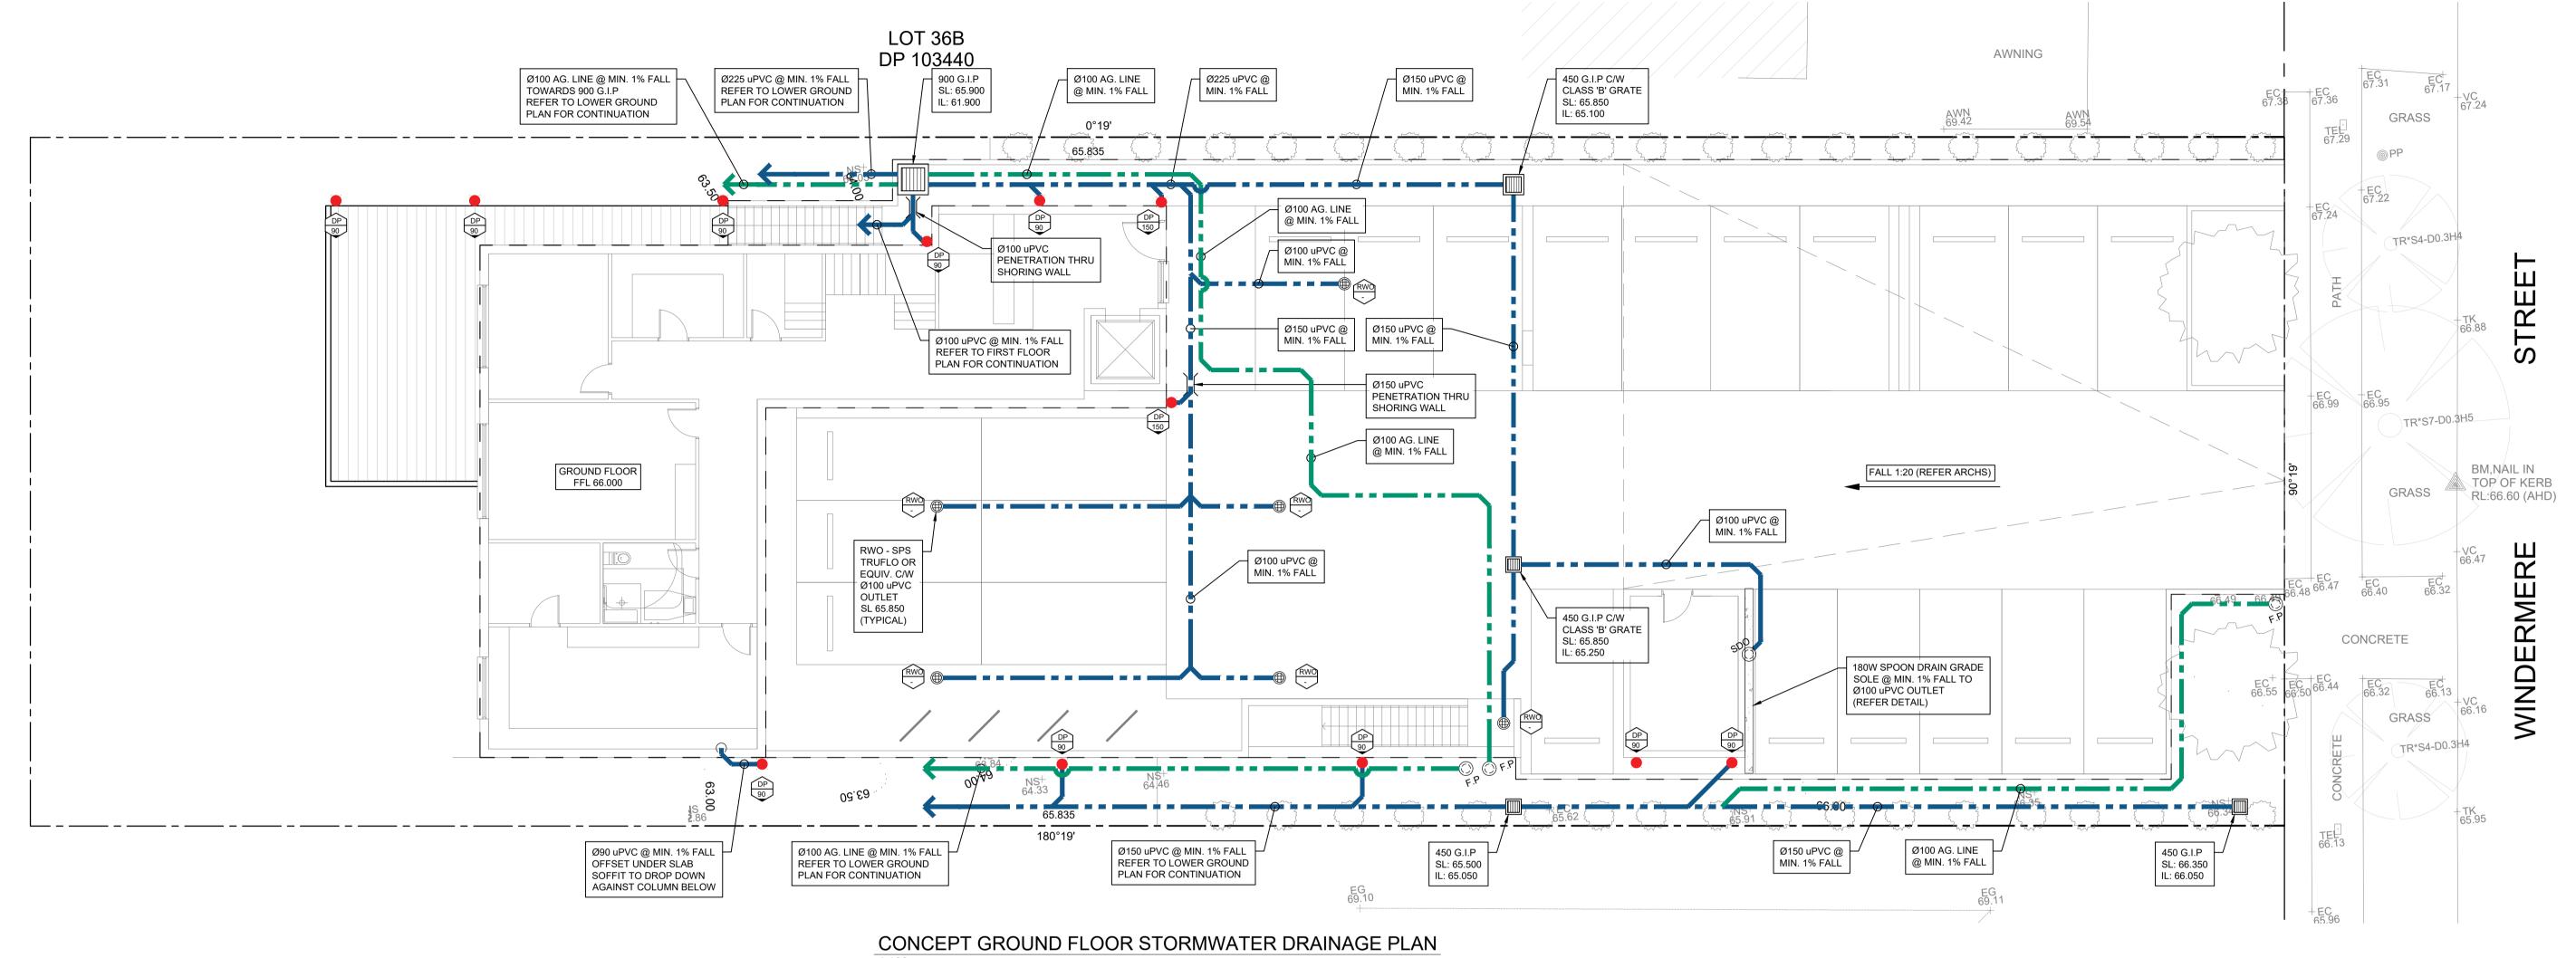
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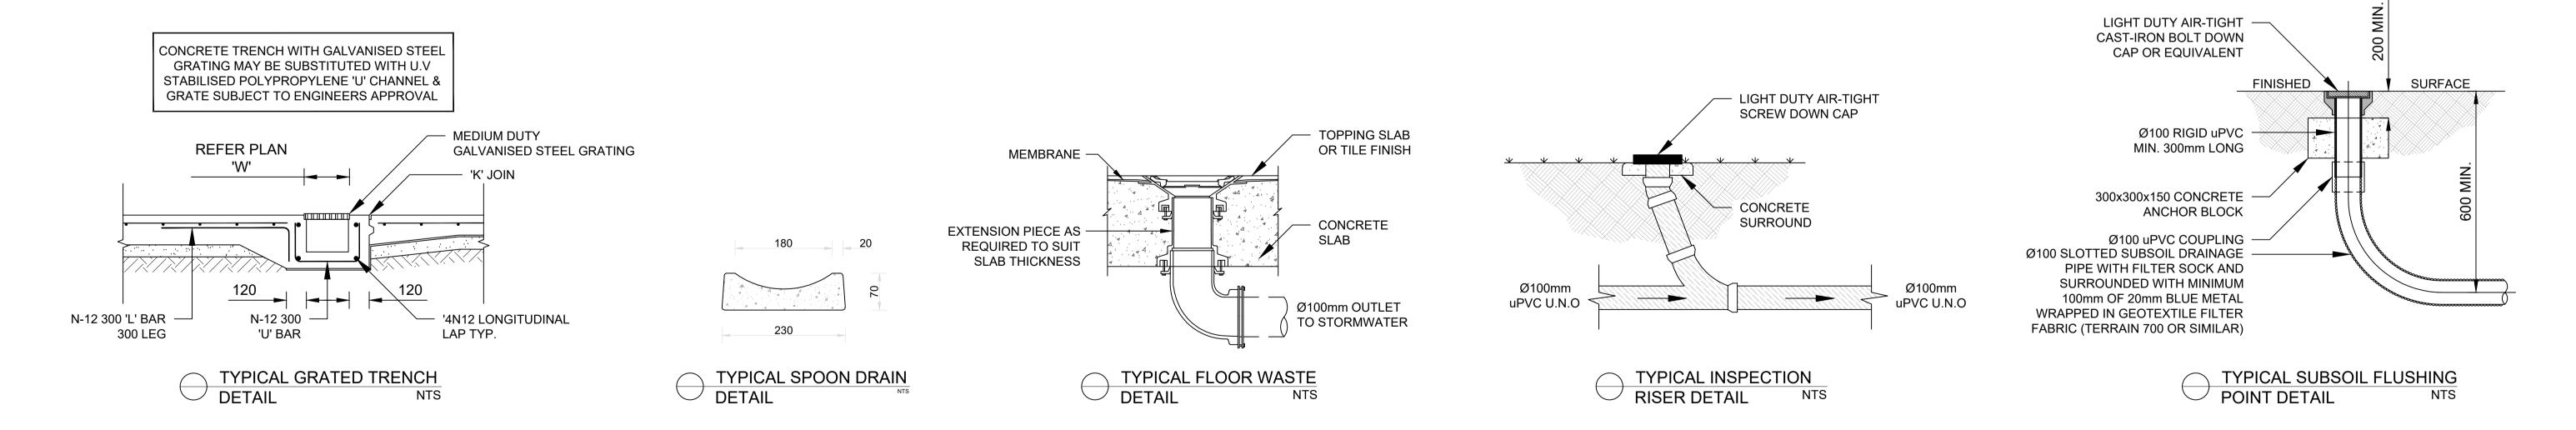
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CONCEPT LOWER GROUND FLOOR STORMWATER DRAINAGE PLAN / DETAILS	DRAWN BY: B.P	SCALE: AS SHOWN









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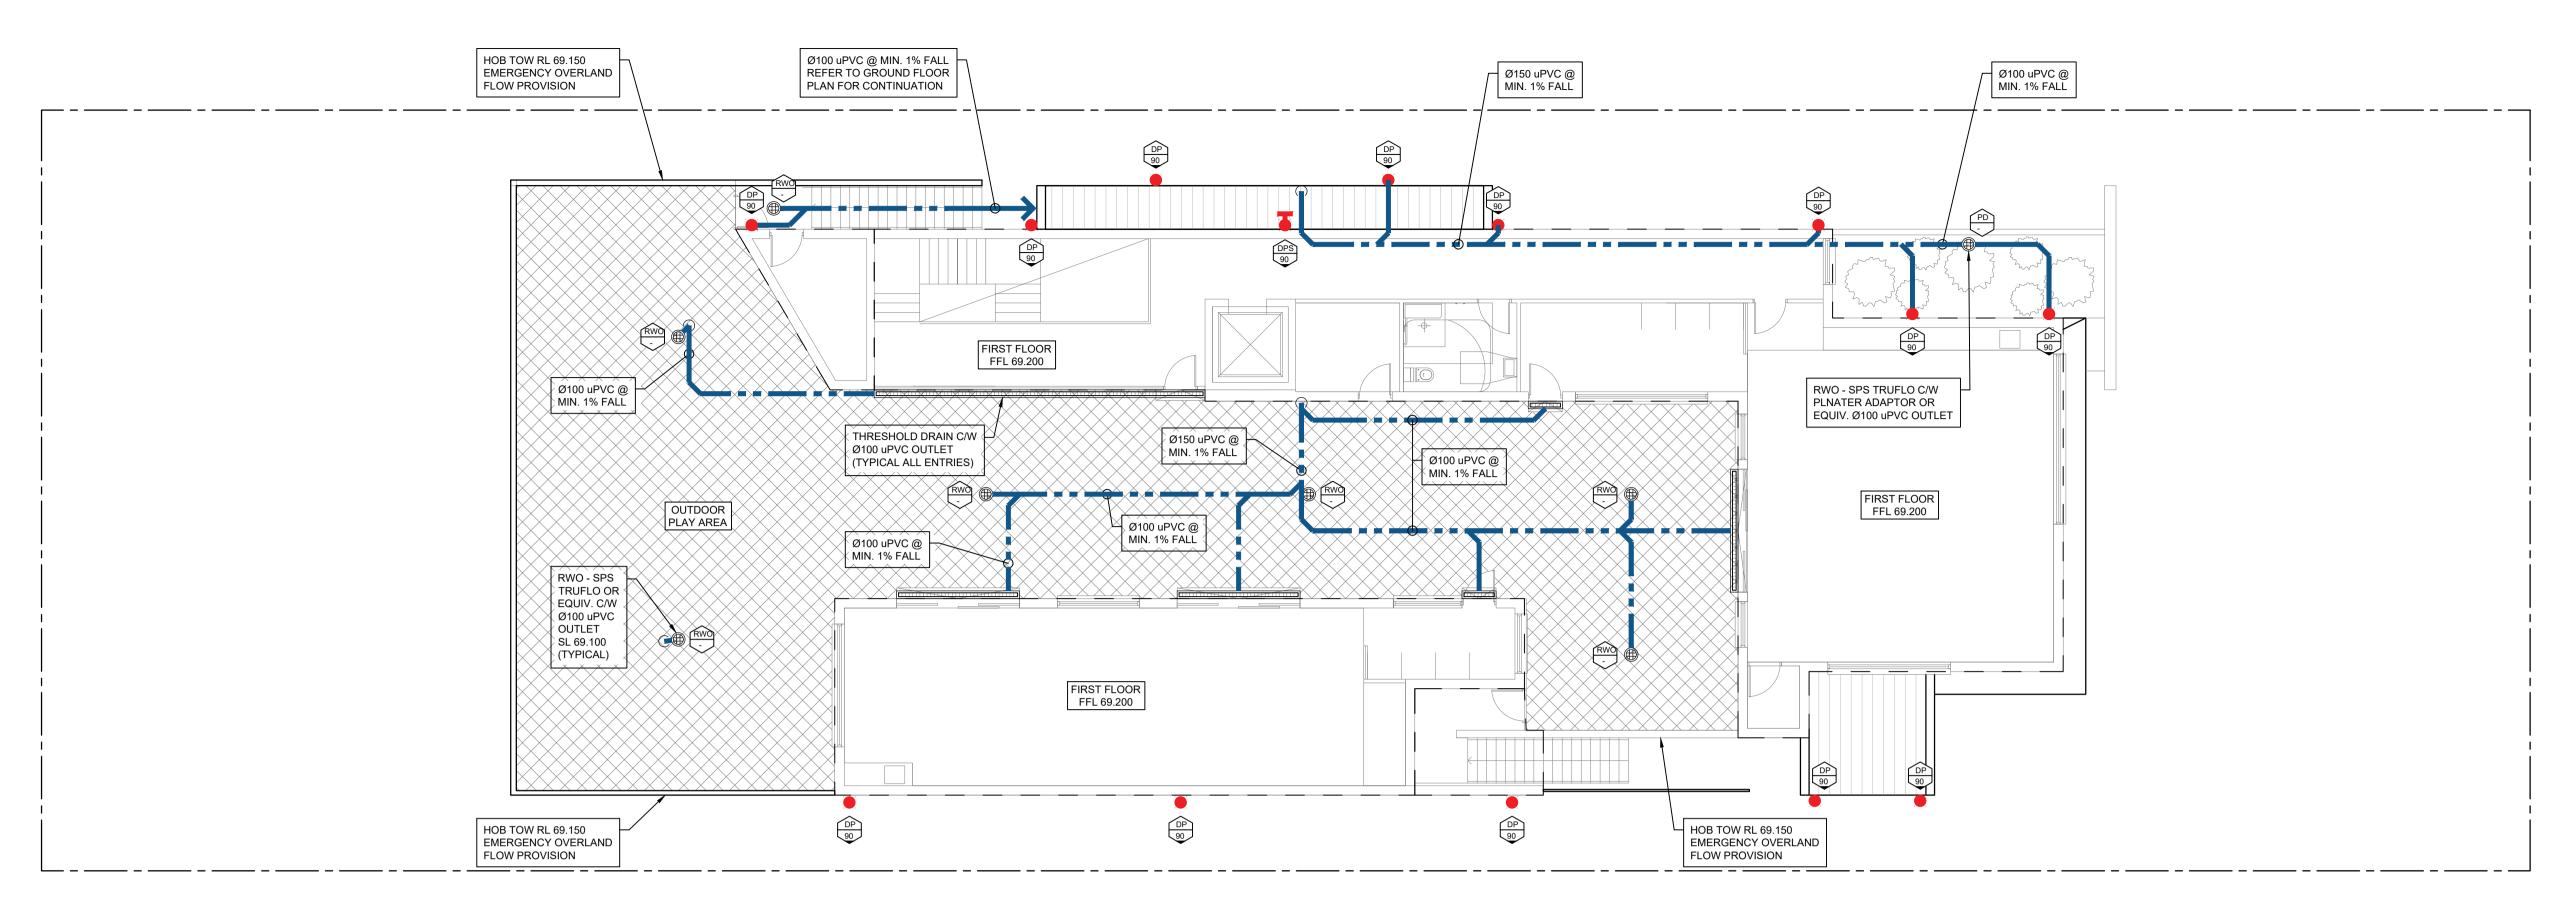
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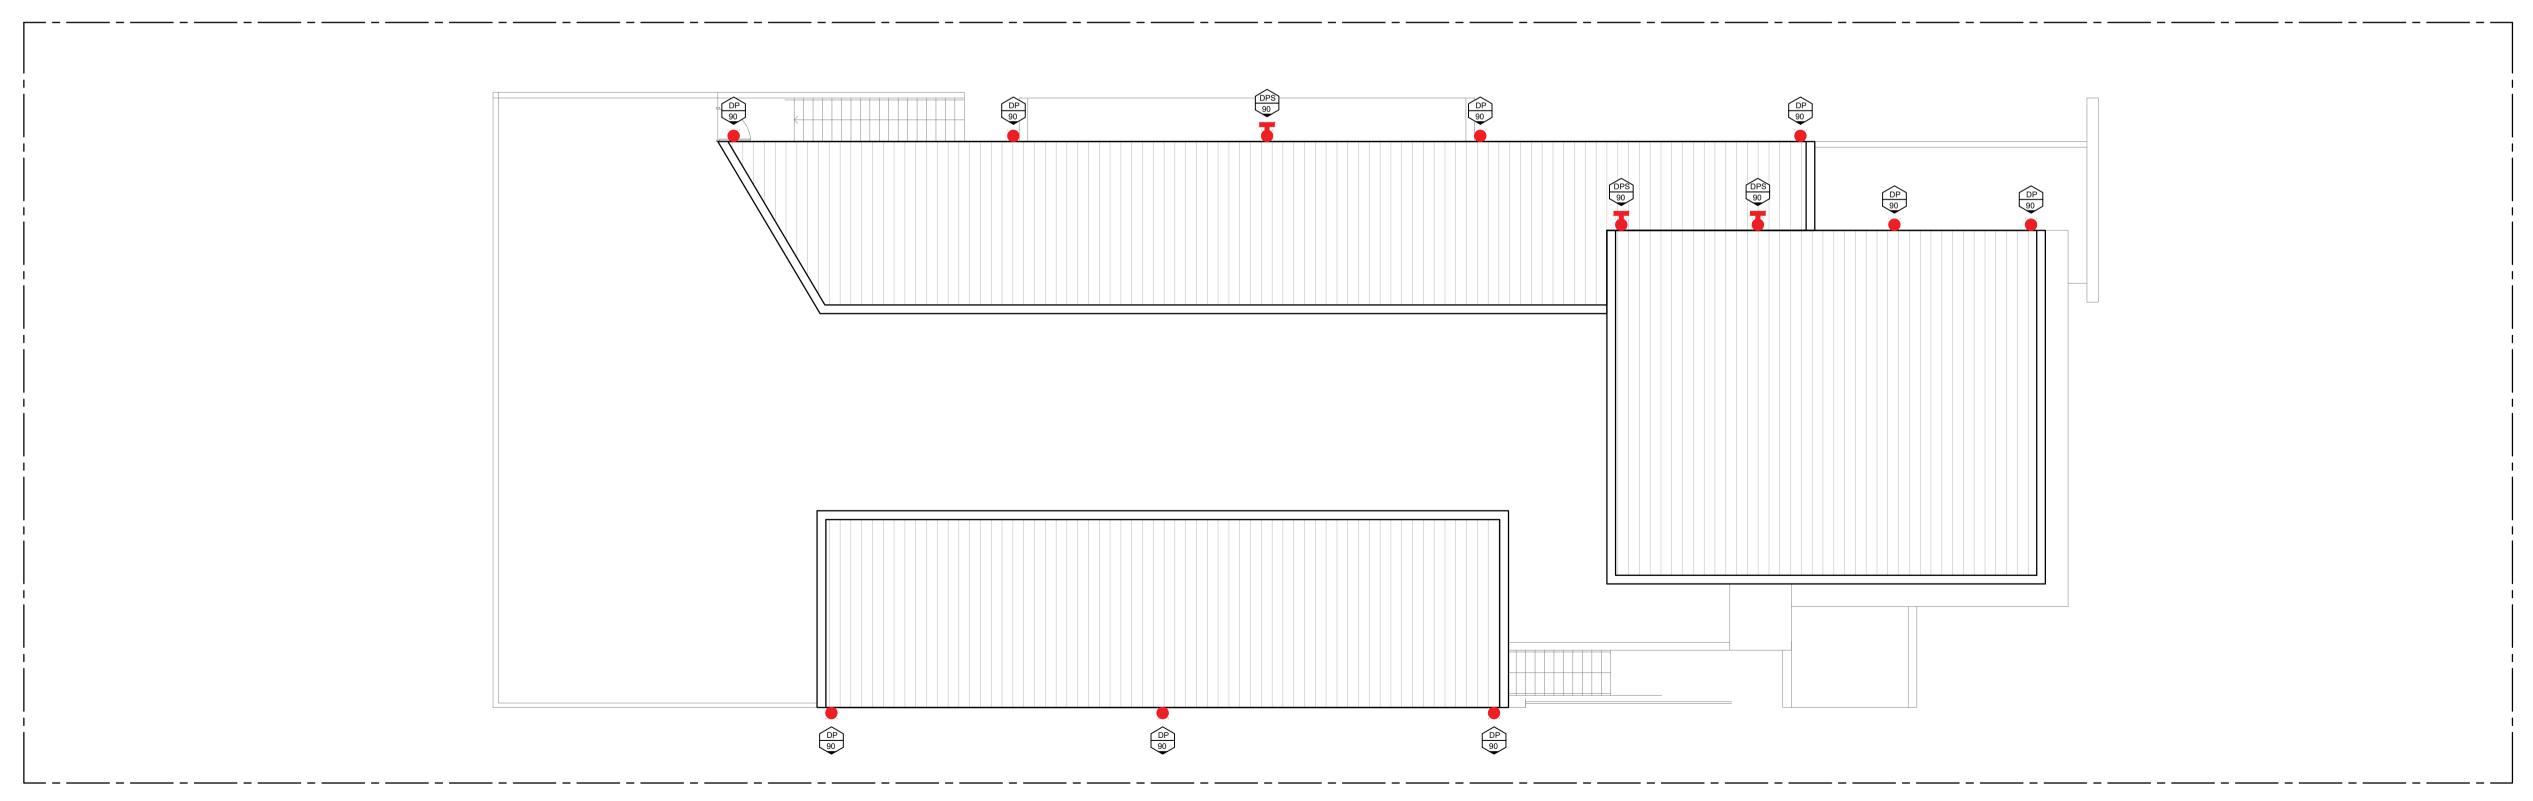
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PROPOSED	JOB NUMBER:	DWG NUMBER:	ORIGINAL	
CHILDCARE CENTRE	220214	C003	A1	
AT: 14 WINDERMERE AVE, NORTHMEAD NSW 2152	DESIGNED BY: B.P	DATE: 28/09/2022		
		20/00/2022		
CONCEPT GROUND FLOOR STORMWATER DRAINAGE PLAN / DETAILS	DRAWN BY: B.P	SCALE: AS SHOWN		





CONCEPT LOWER GROUND FLOOR STORMWATER DRAINAGE PLAN 1:100



CONCEPT ROOF STORMWATER DRAINAGE PLAN
1:100

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CONCEPT FIRST FLOOR / ROOF STORMWATER DRAINAGE PLANS	DRAWN BY: B.P	SCALE: AS SHOWN

